



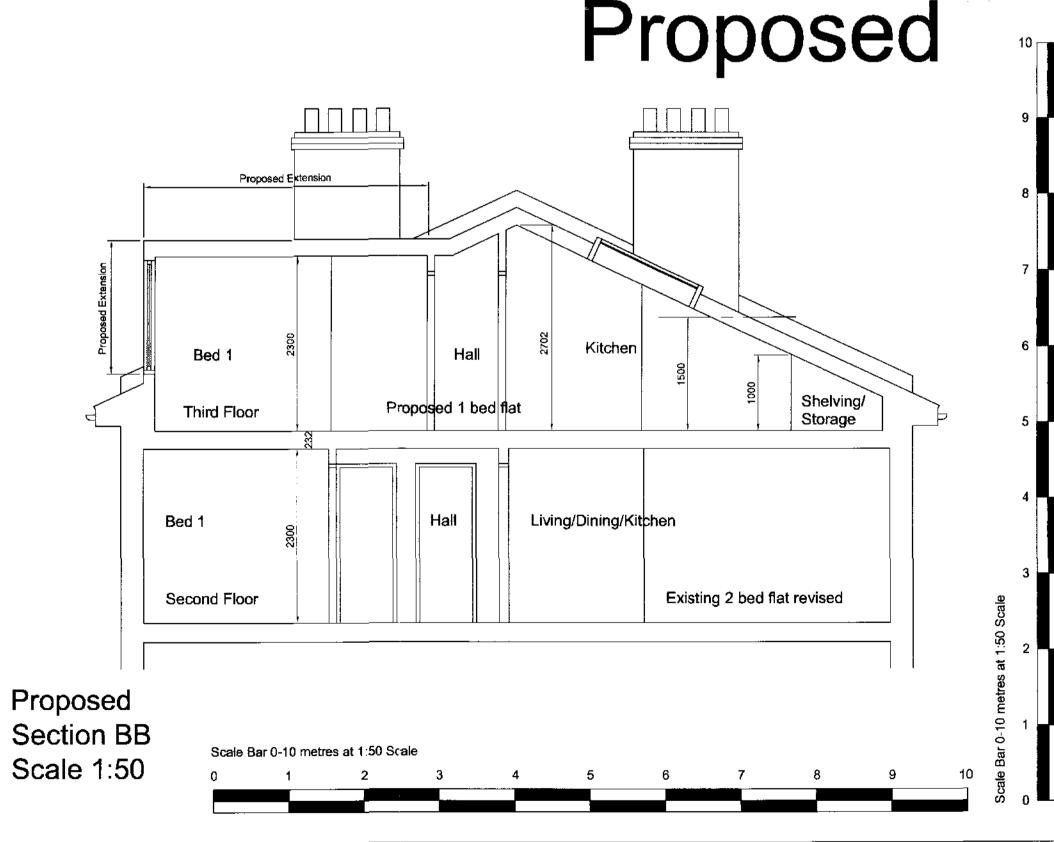



Proposed Rear Elevation Scale 1:100

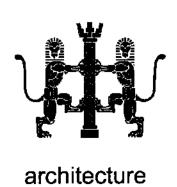



& landscape

Scale 1:100

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■ CLIENT Mr Jon Grant

168 Belsize Road, London, NW6 4BJ

TITLE OF DRAWING

LOCATION/PROJECT

Existing & Proposed Elevations Sections AA & BB

DESCRIPTION OF PROPERTY

Proposed Rear Dormer Window & Conversion of Roof Space into 1 Bedroom Flat

DRAWING STATUS For Planning Application

This drawing has been produced in support of a planning application or a building regulations submission and should not be used for any other purpose. Copyright. No part of this drawing or any other drawings, details, calculations or schedules pertaining to this project as titled (including any notes therein) may be produced in any form either in part or whole without the prior permission in writing

of Kevin O'Callaghan, Architec All dimensions are in millimeters. If in doubt ask. This drawing is not to be used for setting out.

All sizes and dimensions to be checked on site prior to commencement and confirmed by the architect. This drawing is to be read in conjunction with all other relevant drawings and details.

Party Walls. All relevant party wall agreements are to be entered into and agreed between owners prior to commencement of works. All cross over, build over agreements with utility companies to be agreed and approved prior to works on site.

Materials and workmanship must be of a standard conforming with the appropriate recognised authority. For example "National House Building Council", "British Standards Institution", "Department of the Environment- (Building

regulations 1991)" etc. Health and Safety The client, will be the/ or appoint a , Planning Supervisor to act on his behalf who

the Planning Supervisor and the designer prior to commencement.

will ensure that where applicable the "Construction (Design & Management) Regulations 1994" are adhered to, if required. The Contractor must at all times operate safe working practices, maintain the integrity of the existing structures, and conform to all the appropriate requirements of the health & Safety Executive including the "Construction (Health , Safety and welfare) Regulations 1996".

The working methods of any hazardous operations must first be discussed with

DRAWN BY K O'C June 2011 REVISIONS 1:50 & 1:100 DRAWING NUMBER A1 SIZE DRAWING

Existing

127-PL-2000

