

00. INDEX


Drawing Number	Drawing Title	Description
E10014/00	Index	Index of Drawings.
E10014/01	Location Plan	Scale 1:1250 at A4.
E10014/02	Block Plan	Photo of Site from above.
E10014/03	Roof Plan	Drawing of block from above, showing equipment positions.
E10014/04	South. West Elevation	Main dropping location of cables and loom sizes.
E10014/05	South Elevation 1	Description and location of the antenna and dishes + mounting and measurements.
E10014/06	South Elevation 2	Description and location of the Main cabinet size, colour + measurements.
E10014/07	South Elevation 3	Description of Cable routes, loom sizes and entry points.
E10014/08	Existing Equipments	Description, location and view of the existing equipment on site before install.
E10014/09	Antenna, Dish Sizes & Typical Mounting Heights	Sketch of the Antenna and Dishes + mounting, position and height.

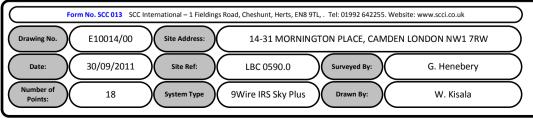

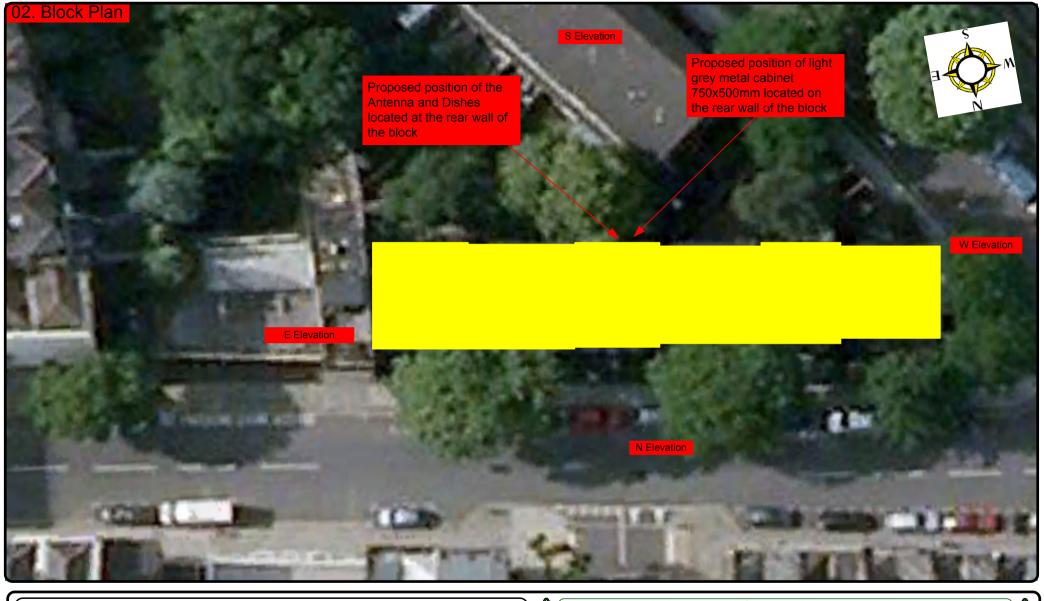





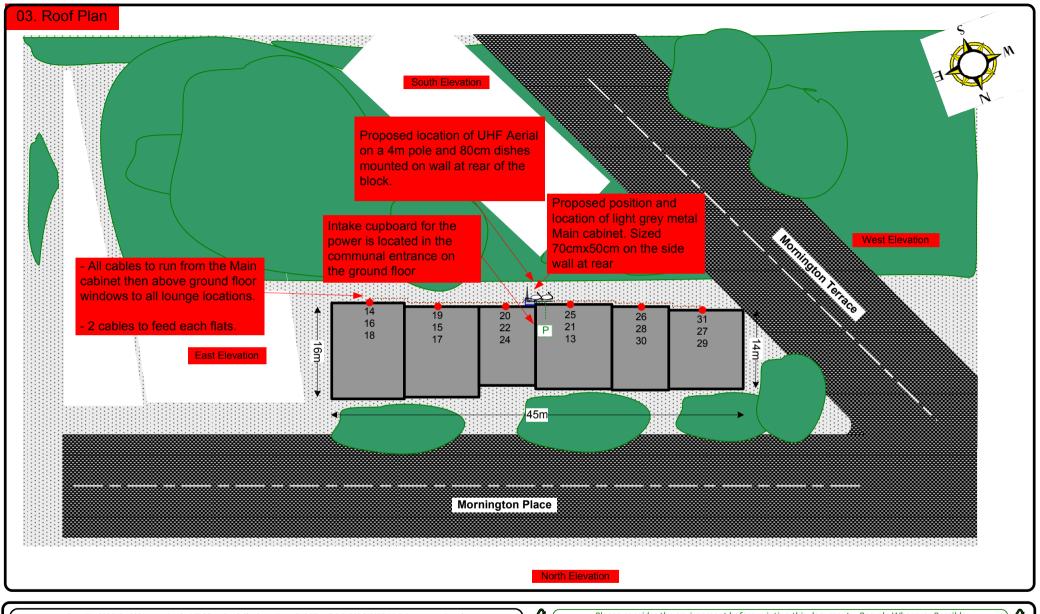



Cable Harness sizes

2-4 cables = 15mm

6-8 cables = 20mm


10-14 cables = 30mm


16-18 Cables = 35mm


20 cables = 40mm


40 cables = 65mm

60 cables = 90mm

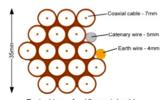

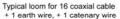

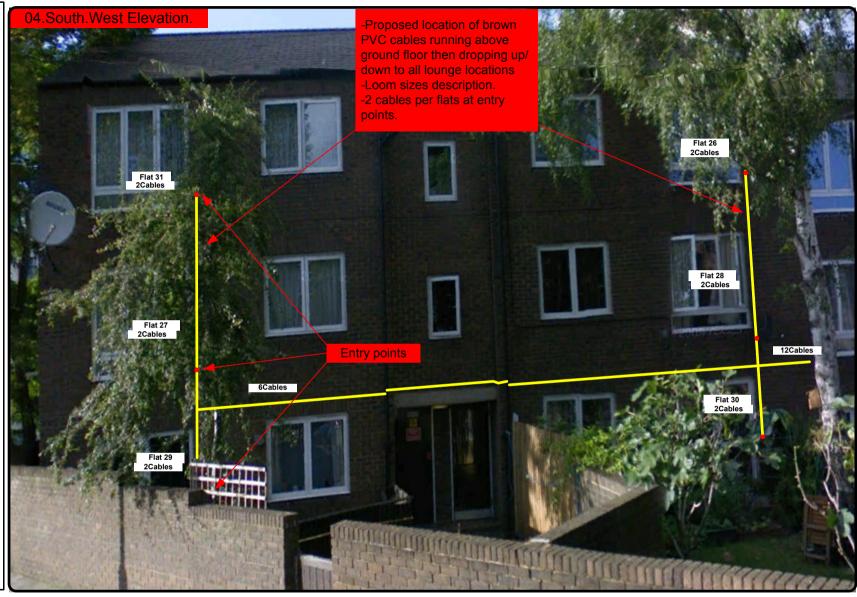

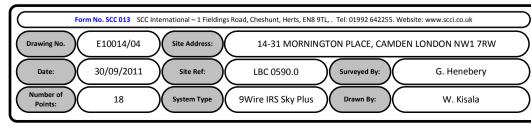



Cable Harness sizes

2-4 cables = 15mm

6-8 cables = 20mm


10-14 cables = 30mm


16-18 Cables = 35mm


20 cables = 40mm

40 cables = 65mm

60 cables = 90mm

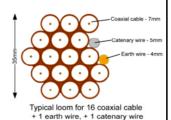

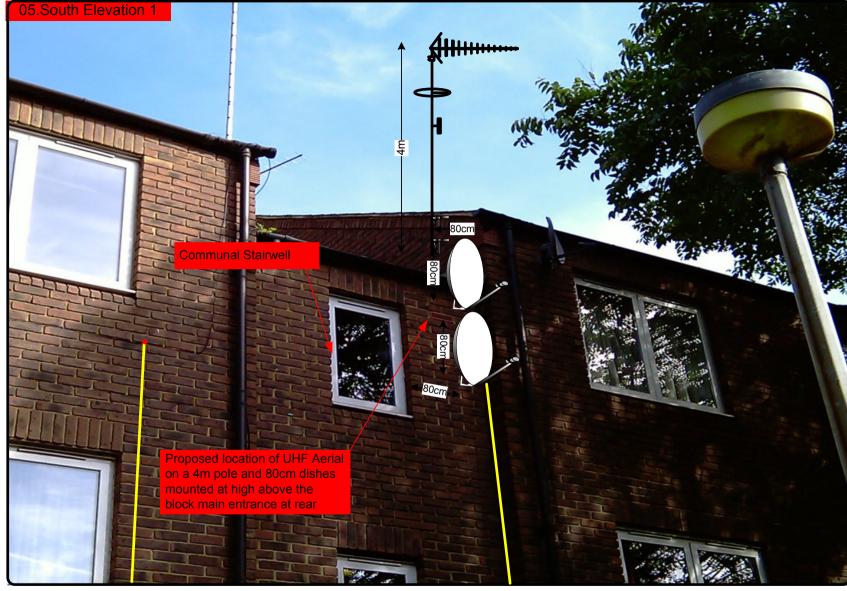

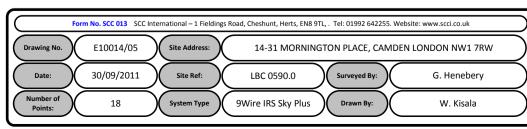



Cable Harness sizes

2-4 cables = 15mm

6-8 cables = 20mm


10-14 cables = 30mm

16-18 Cables = 35mm


20 cables = 40mm


40 cables = 65 mm

60 cables = 90mm

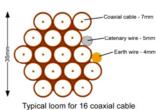

Typical loom for 16 coaxial cable + 1 earth wire, + 1 catenary wire

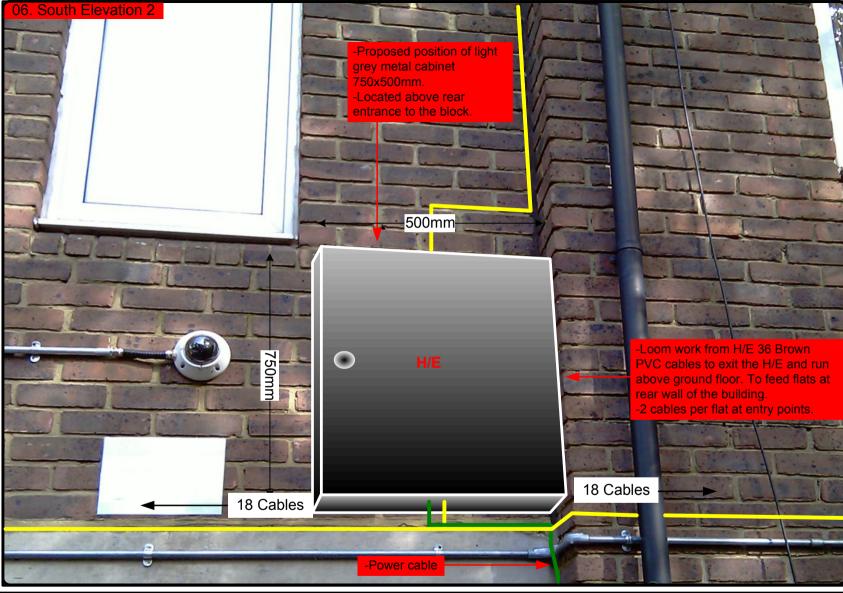

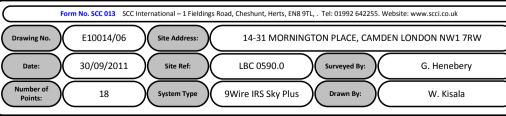



Cable Harness sizes

2-4 cables = 15mm

6-8 cables = 20mm


10-14 cables = 30mm

16-18 Cables = 35mm


20 cables = 40mm


40 cables = 65 mm

60 cables = 90 mm

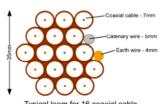

Typical loom for 16 coaxial cable + 1 earth wire, + 1 catenary wire

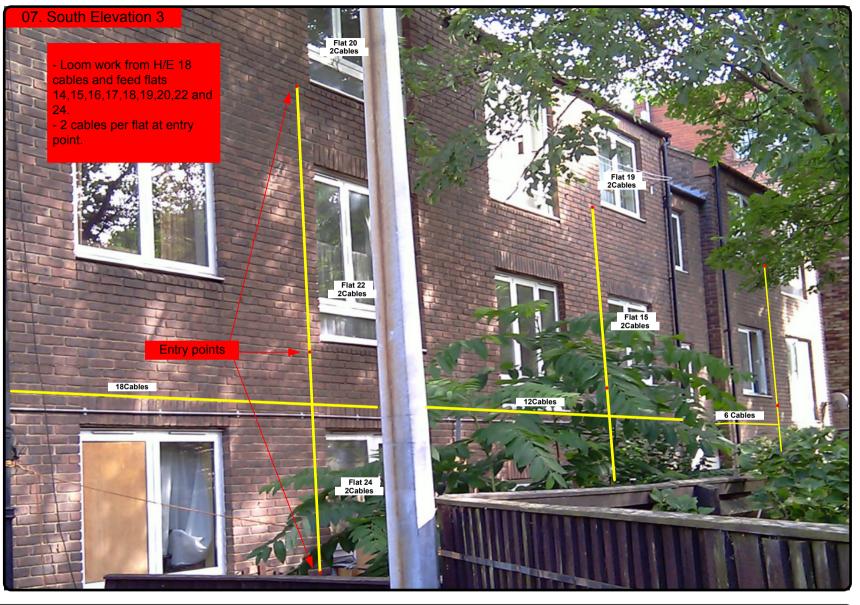

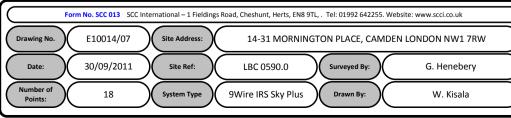



Cable Harness sizes

2-4 cables = 15mm

6-8 cables = 20mm

10-14 cables = 30mm

16-18 Cables = 35mm

20 cables = 40mm

40 cables = 65mm

60 cables = 90mm

