

00. INDEX

Drawing Number	Drawing Title	Description
E45232/00	Index	Index of Drawings.
E45232/01	Location Plan	Scale 1:1250 at A4.
E45232/02	Block Plan	Photo of Site from above.
E45232/03	Roof Plan	Drawing of block from above, showing equipment positions.
E45232/04	Roof Elevation	Description and location of the antenna and dishes + mounting
E45232/05	Main Cabinet Location	Description and Location of the main cabinet + size
E45232/06	S. West Elevation	Description of cable routes, colour and loom sizes per flats at entry points for each drops
E45232/07	Existing Equipments	View and location of existing equipment on site
E45232/08	Antenna, Dish Sizes & Typical Mounting Heights	Antenna and Dishes description, mounting, position, height and measurements.

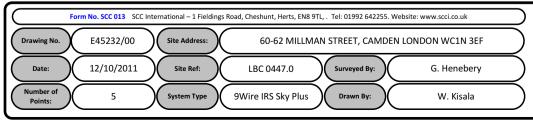




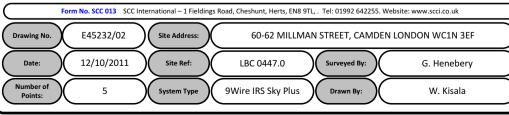





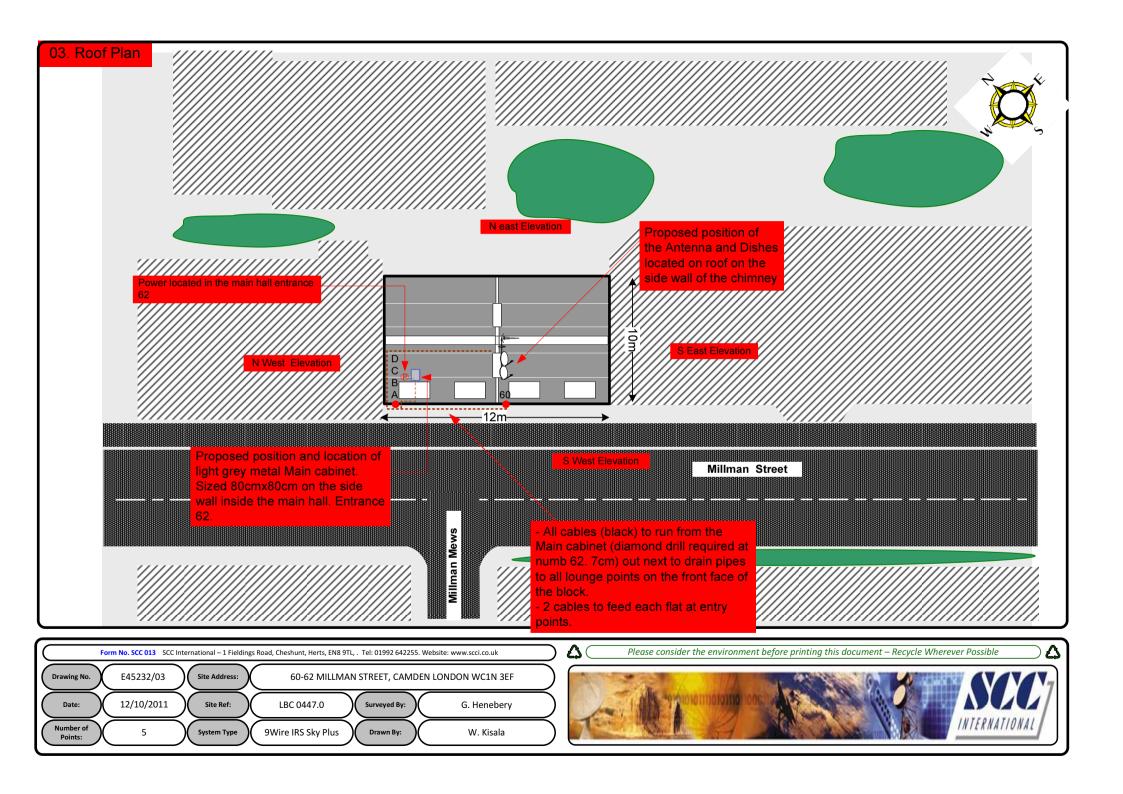

Cable Harness sizes

2-4 cables = 15mm

6-8 cables = 20mm


10-14 cables = 30mm

16-18 Cables = 35mm


20 cables = 40mm


40 cables = 65mm

60 cables = 90mm

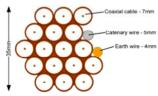

Typical loom for 16 coaxial cable + 1 earth wire, + 1 catenary wire

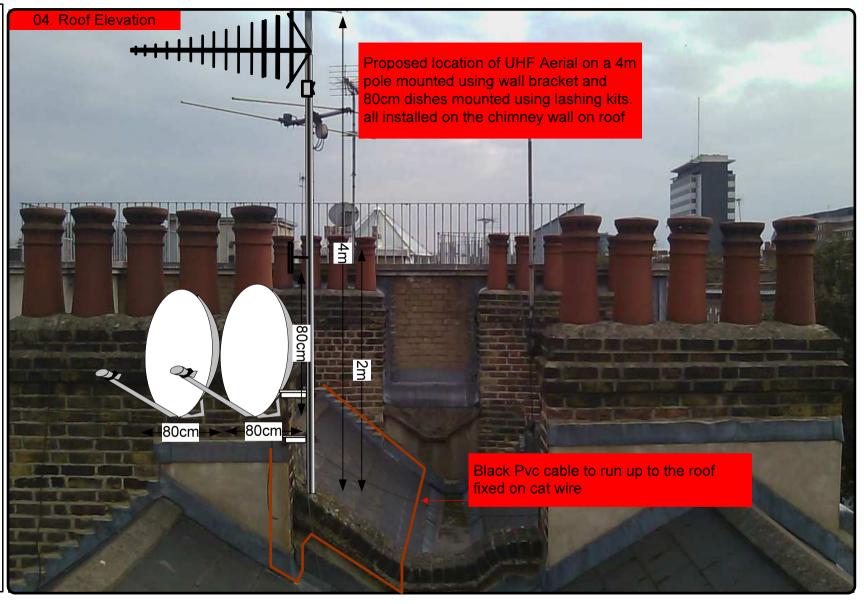

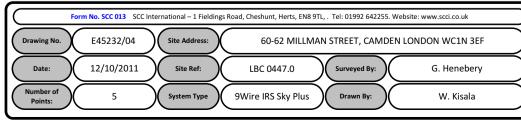



Cable Harness sizes

2-4 cables = 15mm

6-8 cables = 20mm


10-14 cables = 30mm

16-18 Cables = 35mm

20 cables = 40mm


40 cables = 65mm

60 cables = 90mm

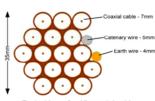

Typical loom for 16 coaxial cable + 1 earth wire, + 1 catenary wire



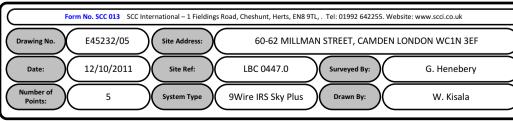



Cable Harness sizes

2-4 cables = 15mm

6-8 cables = 20mm


10-14 cables = 30mm

16-18 Cables = 35mm


20 cables = 40mm

40 cables = 65mm

60 cables = 90mm

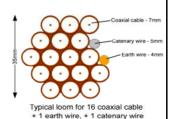



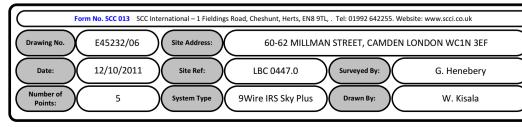



Cable Harness sizes

2-4 cables = 15mm

6-8 cables = 20mm

10-14 cables = 30mm

16-18 Cables = 35mm

20 cables = 40mm

40 cables = 65mm

60 cables = 90mm

