

00. INDEX

Drawing Number	Drawing Title	Description
E14053/00	Index	Index of Drawings.
E14053/01	Location Plan	Scale 1:1250 at A4.
E14053/02	Block Plan	Photo of Site from above.
E14053/03	Roof Plan	Drawing of block from above, showing equipment positions.
E14053/04	South East Elevation	Description and location of the antenna and dishes + mounting and measurements.
E14053/05	South Elevation	Description of Cable routes, loom sizes and entry points.
E14053/06	North Elevation	Description of Cable routes, loom sizes and entry points.
E14053/07	Existing Equipments	Description, location and view of the existing equipment on site before install.
E14053/08	Antenna, Dish Sizes & Typical Mounting Heights	Antenna and Dishes description + mounting, position and height.

Form No. SCC 013 SCC International – 1 Fieldings Road, Cheshunt, Herts, EN8 9TL, . Tel: 01992 642255. Website: www.scci.co.uk



Please consider the environment before printing this document – Recycle Wherever Possible



Drawing No.	E14053/00	Site Address:	46-54 ST ALBANS ROAD, CAMDEN LONDON NW5 1RH		
Date:	10/10/2011	Site Ref:	LBC 0582.0	Surveyed By:	G. Henebery
Number of Points:	6	System Type	9Wire IRS Sky Plus	Drawn By:	W. Kisala



02. Block Plan



Form No. SCC 013 SCC International – 1 Fieldings Road, Cheshunt, Herts, EN8 9TL, . Tel: 01992 642255. Website: www.scci.co.uk

Drawing No. E14053/02 Site Address: 46-54 ST ALBANS ROAD, CAMDEN LONDON NW5 1RH

Date: 10/10/2011 Site Ref: LBC 0582.0 Surveyed By: G. Henebery


Number of Points: 6 System Type: 9Wire IRS Sky Plus Drawn By: W. Kisala



Please consider the environment before printing this document – Recycle Wherever Possible



03. Roof Plan

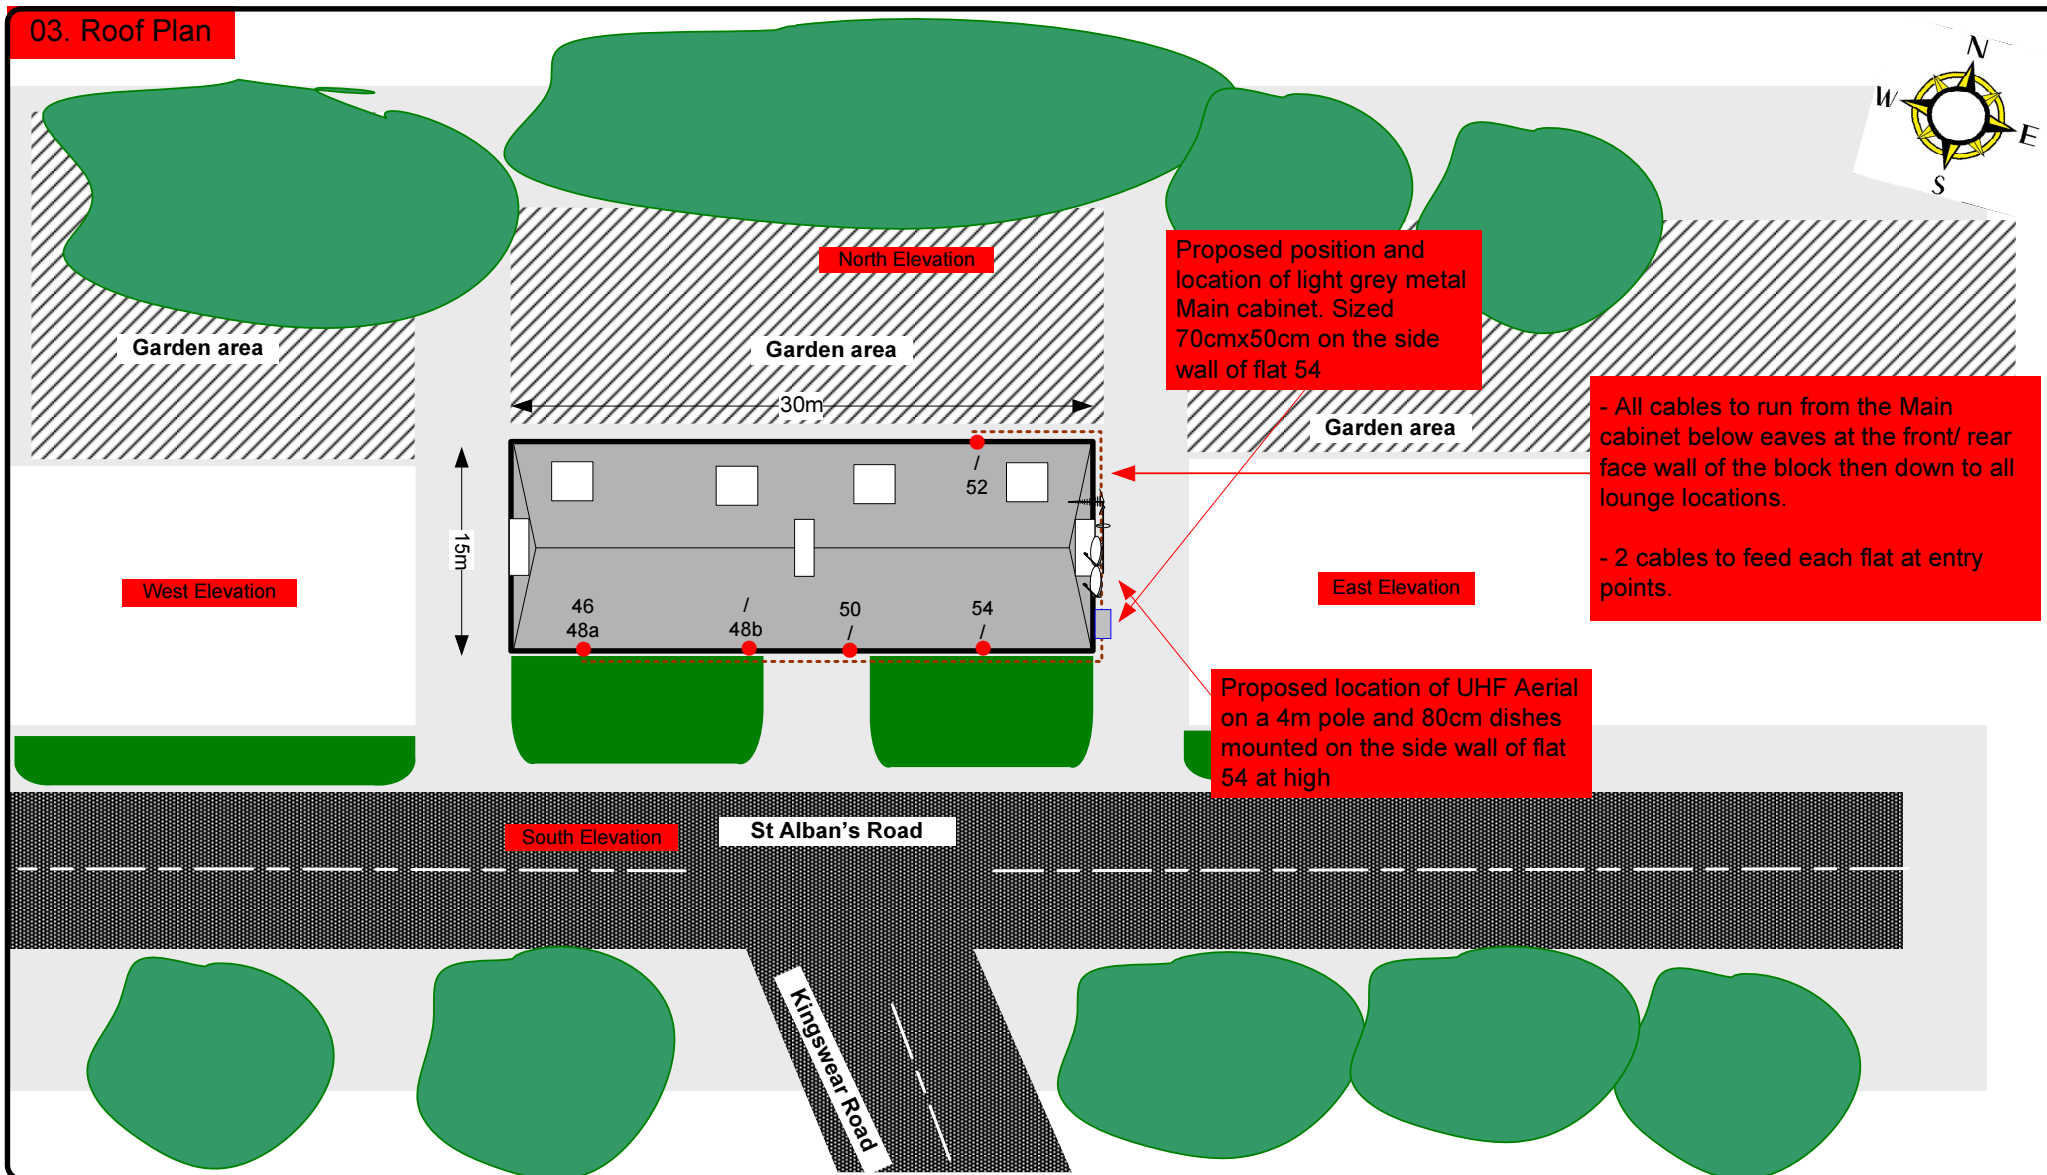

Form No. SCC 013 SCC International – 1 Fieldings Road, Cheshunt, Herts, EN8 9TL, . Tel: 01992 642255. Website: www.scci.co.uk

Drawing No. E14053/03 Site Address: 46-54 ST ALBANS ROAD, CAMDEN LONDON NW5 1RH

Date: 10/10/2011 Site Ref: LBC 0582.0 Surveyed By: G. Henebery

Number of Points: 6 System Type: 9Wire IRS Sky Plus Drawn By: W. Kisala



Please consider the environment before printing this document – Recycle Wherever Possible



Each property will have
two cables to lounge
position.

Cable Harness sizes

2-4 cables = 15mm

6-8 cables = 20mm


10-14 cables = 30mm

16-18 Cables = 35mm

20 cables = 40mm

40 cables = 65mm

60 cables = 90mm

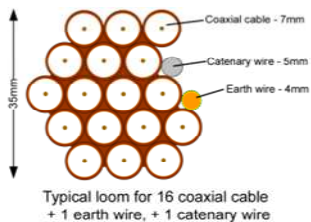

04. South East Elevation

- Proposed location of brown PVC cables to run below eaves then drop down to all lounge locations
- Loom sizes description.
- 2 cables per flats at entry points.

Proposed location of UHF Aerial
on a 4m pole and 80cm dishes
mounted at high on the side wall
of flat 54

- Proposed position of light grey metal cabinet 700x500mm.
- Mounted on the side wall of flat 54

Form No. SCC 013 SCC International – 1 Fieldings Road, Cheshunt, Herts, EN8 9TL, . Tel: 01992 642255. Website: www.scci.co.uk

Drawing No. E14053/04

Site Address:

46-54 ST ALBANS ROAD, CAMDEN LONDON NW5 1RH

Date:

10/10/2011

Site Ref:

LBC 0582.0

Surveyed By:

G. Henebery

Number of Points:

6

System Type

9Wire IRS Sky Plus

Drawn By:

W. Kisala

Please consider the environment before printing this document – Recycle Wherever Possible



Each property will have two cables to lounge position.

Cable Harness sizes

2-4 cables = 15mm

6-8 cables = 20mm


10-14 cables = 30mm

16-18 Cables = 35mm

20 cables = 40mm

40 cables = 65mm

60 cables = 90mm

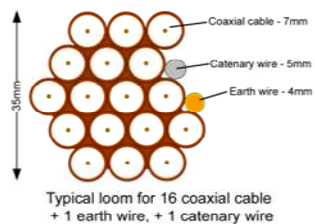

05. South Elevation



Form No. SCC 013 SCC International – 1 Fieldings Road, Cheshunt, Herts, EN8 9TL, . Tel: 01992 642255. Website: www.scci.co.uk

Drawing No. E14053/05 Site Address: 46-54 ST ALBANS ROAD, CAMDEN LONDON NW5 1RH

Date: 10/10/2011 Site Ref: LBC 0582.0 Surveyed By: G. Henebery

Number of Points: 6 System Type: 9Wire IRS Sky Plus Drawn By: W. Kisala



Please consider the environment before printing this document – Recycle Wherever Possible



Each property will have two cables to lounge position.

Cable Harness sizes

2-4 cables = 15mm

6-8 cables = 20mm


10-14 cables = 30mm

16-18 Cables = 35mm

20 cables = 40mm

40 cables = 65mm

60 cables = 90mm

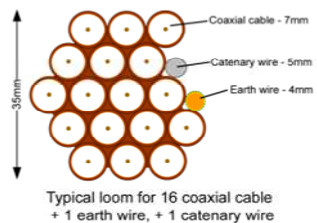

06. North Elevation

Proposed Brown cables to run below eaves at rear of the block to feed flat 52.

2 cables per flat at entry points



Form No. SCC 013 SCC International – 1 Fieldings Road, Cheshunt, Herts, EN8 9TL, . Tel: 01992 642255. Website: www.scci.co.uk

Drawing No.	E14053/06	Site Address:	46-54 ST ALBANS ROAD, CAMDEN LONDON NW5 1RH
Date:	10/10/2011	Site Ref:	LBC 0582.0
Number of Points:	6	System Type	9Wire IRS Sky Plus
		Surveyed By:	G. Henebery
		Drawn By:	W. Kisala



Please consider the environment before printing this document – Recycle Wherever Possible



Each property will have two cables to lounge position.

Cable Harness sizes

2-4 cables = 15mm

6-8 cables = 20mm


10-14 cables = 30mm

16-18 Cables = 35mm

20 cables = 40mm

40 cables = 65mm

60 cables = 90mm

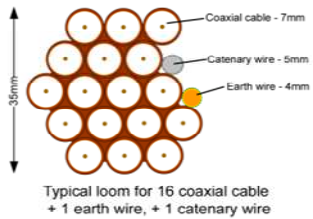

07. Existing Equipments



South Elevation

Form No. SCC 013 SCC International – 1 Fieldings Road, Cheshunt, Herts, EN8 9TL, . Tel: 01992 642255. Website: www.scci.co.uk

Drawing No.	E14053/07	Site Address:	46-54 ST ALBANS ROAD, CAMDEN LONDON NW5 1RH		
Date:	10/10/2011	Site Ref:	LBC 0582.0	Surveyed By:	G. Henebery
Number of Points:	6	System Type	9Wire IRS Sky Plus	Drawn By:	W. Kisala




Please consider the environment before printing this document – Recycle Wherever Possible



08. Antenna and Dishes Measurements

Digital TV,
FM & DAB Radio
Aerials

Proposed location of UHF Aerial on a 4m
pole and 80cm dishes on 1.5x1m poles
mounted on the side wall of flat 54

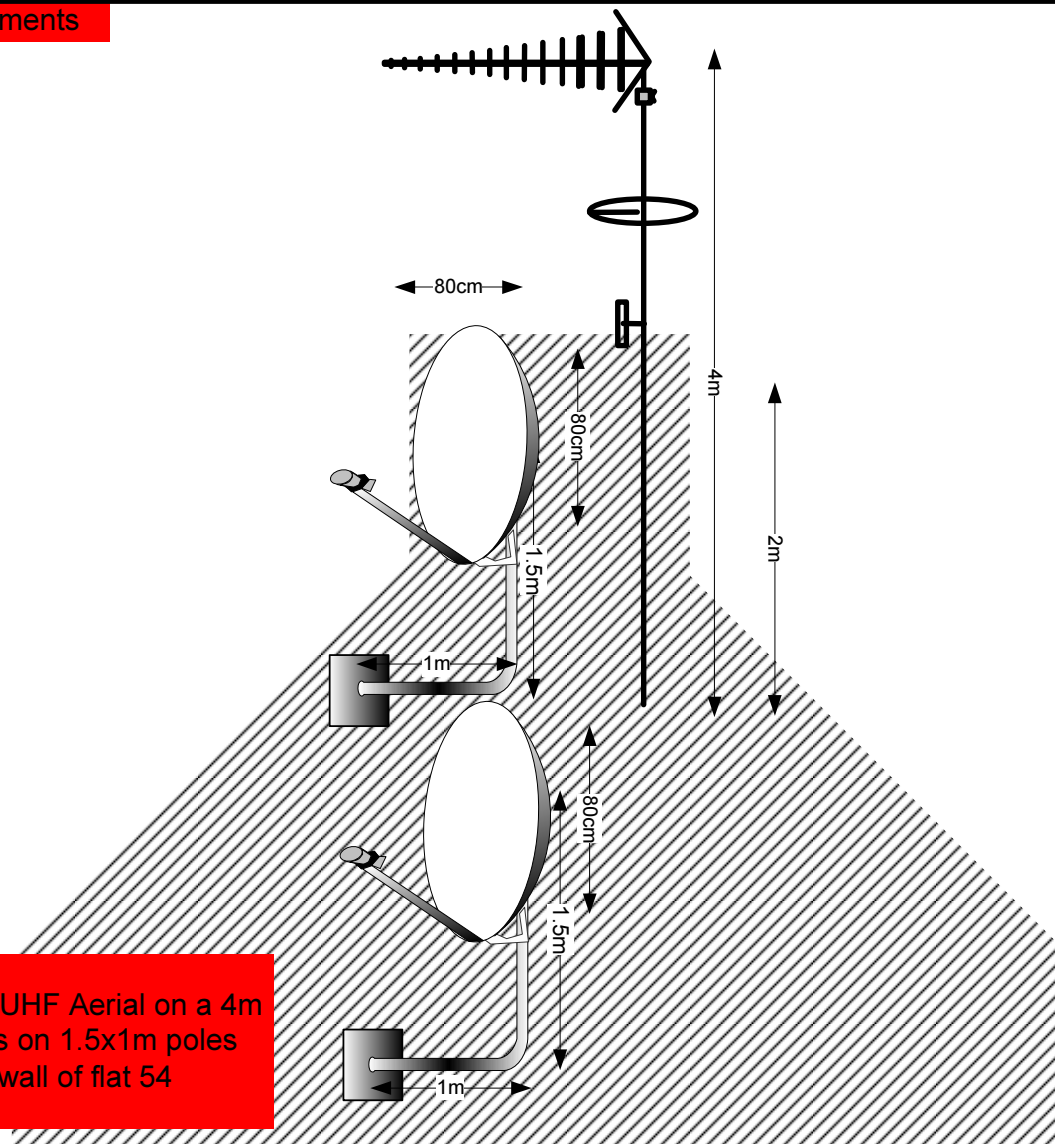

Form No. SCC 013 SCC International – 1 Fieldings Road, Cheshunt, Herts, EN8 9TL, . Tel: 01992 642255. Website: www.scci.co.uk

Drawing No. E14053/08 Site Address: 46-54 ST ALBANS ROAD, CAMDEN LONDON NW5 1RH

Date: 10/10/2011 Site Ref: LBC 0582.0 Surveyed By: G. Henebery

Number of Points: 6 System Type: 9Wire IRS Sky Plus Drawn By: W. Kisala



Please consider the environment before printing this document – Recycle Wherever Possible

