
00. INDEX


Drawing Number	Drawing Title	Description
E14054/00	Index	Index of Drawings.
E14054/01	Location Plan	Scale 1:1250 at A4.
E14054/02	Block Plan	Photo of Site from above.
E14054/03	Roof Plan	Drawing of block from above, showing equipment positions.
E14054/04	East Elevation	Description and location of the antenna and dishes + mounting and measurements.
E14054/05	South Elevation 1	Description of Cable routes, loom sizes and entry points.
E14054/06	South Elevation 2	Description of Cable routes, loom sizes and entry points.
E14054/07	Existing Equipments	Description, location and view of the existing equipment on site before install.
E14054/08	Antenna, Dish Sizes & Typical Mounting Heights	Antenna and Dishes description + mounting, position and height.

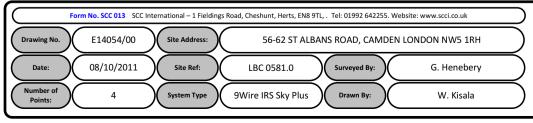







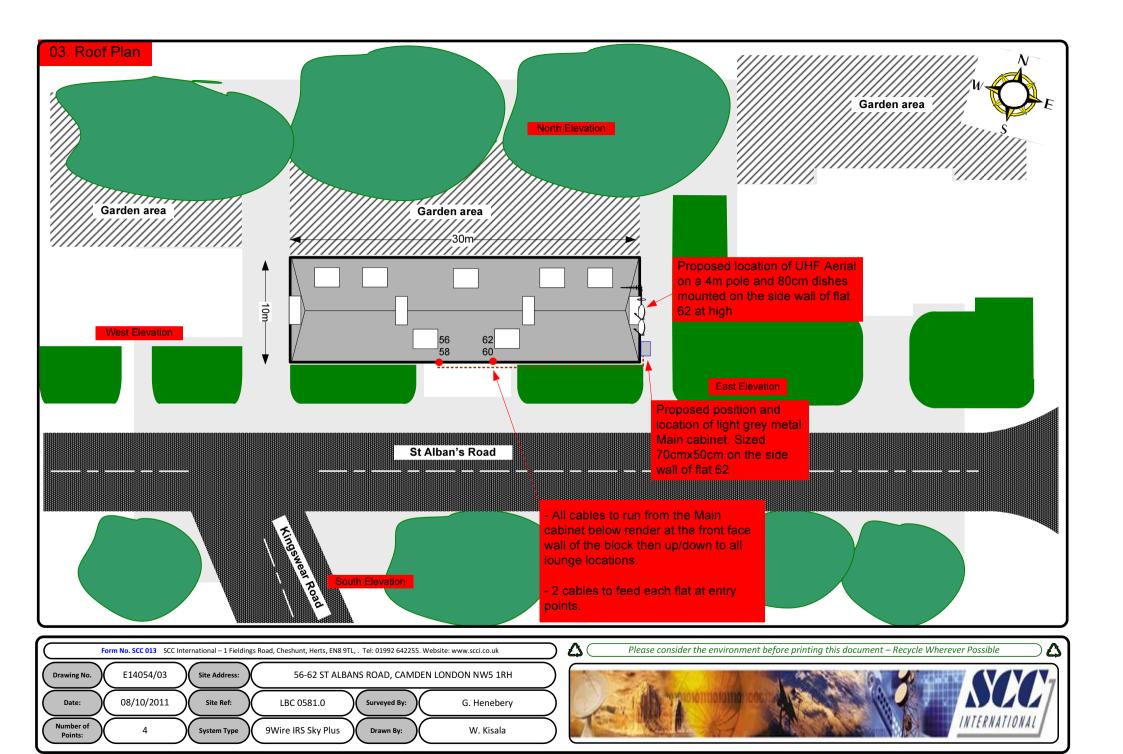

Cable Harness sizes

2-4 cables = 15mm

6-8 cables = 20mm


10-14 cables = 30mm

16-18 Cables = 35mm


20 cables = 40mm

40 cables = 65mm

60 cables = 90mm

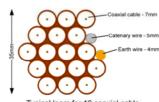

Typical loom for 16 coaxial cable + 1 earth wire, + 1 catenary wire

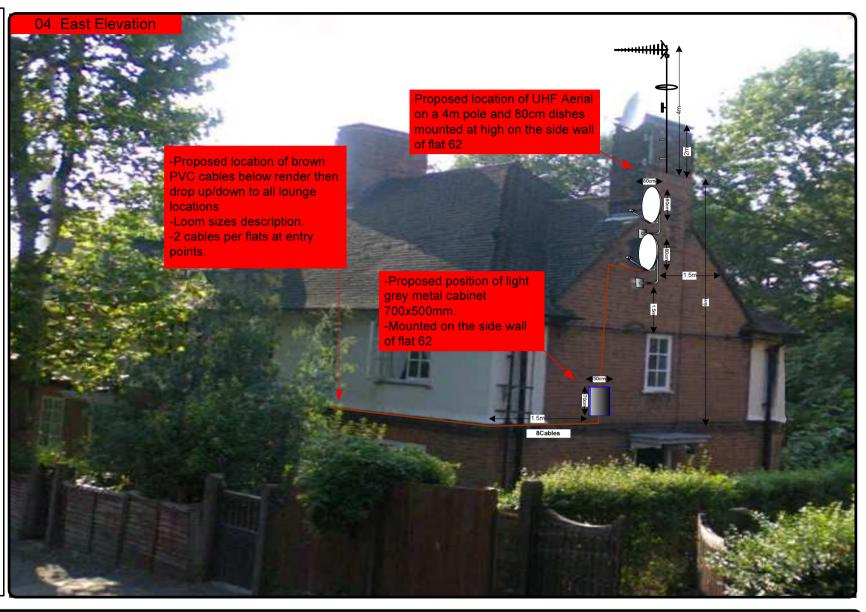





Cable Harness sizes

2-4 cables = 15mm

6-8 cables = 20mm


10-14 cables = 30mm

16-18 Cables = 35mm


20 cables = 40mm

40 cables = 65mm

60 cables = 90mm

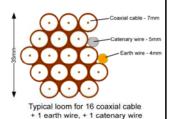



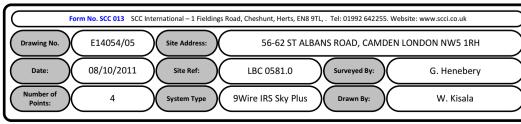



Cable Harness sizes

2-4 cables = 15mm

6-8 cables = 20mm


10-14 cables = 30mm

16-18 Cables = 35mm

20 cables = 40mm


40 cables = 65mm

60 cables = 90mm

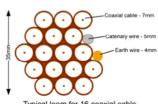

Typical loom for 16 coaxial cable + 1 earth wire, + 1 catenary wire



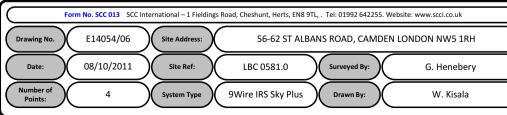



Cable Harness sizes

2-4 cables = 15mm

6-8 cables = 20mm


10-14 cables = 30mm

16-18 Cables = 35mm

20 cables = 40mm

40 cables = 65mm

60 cables = 90mm

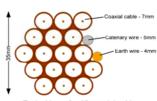

Typical loom for 16 coaxial cable + 1 earth wire, + 1 catenary wire



