

00. INDEX

Drawing Number	Drawing Title	Description
E14054/00	Index	Index of Drawings.
E14054/01	Location Plan	Scale 1:1250 at A4.
E14054/02	Block Plan	Photo of Site from above.
E14054/03	Roof Plan	Drawing of block from above, showing equipment positions.
E14054/04	East Elevation	Description and location of the antenna and dishes + mounting and measurements.
E14054/05	South Elevation 1	Description of Cable routes, loom sizes and entry points.
E14054/06	South Elevation 2	Description of Cable routes, loom sizes and entry points.
E14054/07	Existing Equipments	Description, location and view of the existing equipment on site before install.
E14054/08	Antenna, Dish Sizes & Typical Mounting Heights	Antenna and Dishes description + mounting, position and height.

Form No. SCC 013 SCC International – 1 Fieldings Road, Cheshunt, Herts, EN8 9TL, . Tel: 01992 642255. Website: www.scci.co.uk

Drawing No.	E14054/00	Site Address:	56-62 ST ALBANS ROAD, CAMDEN LONDON NW5 1RH		
Date:	08/10/2011	Site Ref:	LBC 0581.0	Surveyed By:	G. Henebery
Number of Points:	4	System Type	9Wire IRS Sky Plus	Drawn By:	W. Kisala



Please consider the environment before printing this document – Recycle Wherever Possible



02. Block Plan



Form No. SCC 013 SCC International – 1 Fieldings Road, Cheshunt, Herts, EN8 9TL, . Tel: 01992 642255. Website: www.scci.co.uk

Drawing No. E14054/02 Site Address: 56-62 ST ALBANS ROAD, CAMDEN LONDON NW5 1RH

Date: 08/10/2011 Site Ref: LBC 0581.0 Surveyed By: G. Henebery


Number of Points: 4 System Type: 9Wire IRS Sky Plus Drawn By: W. Kisala



Please consider the environment before printing this document – Recycle Wherever Possible



03. Roof Plan

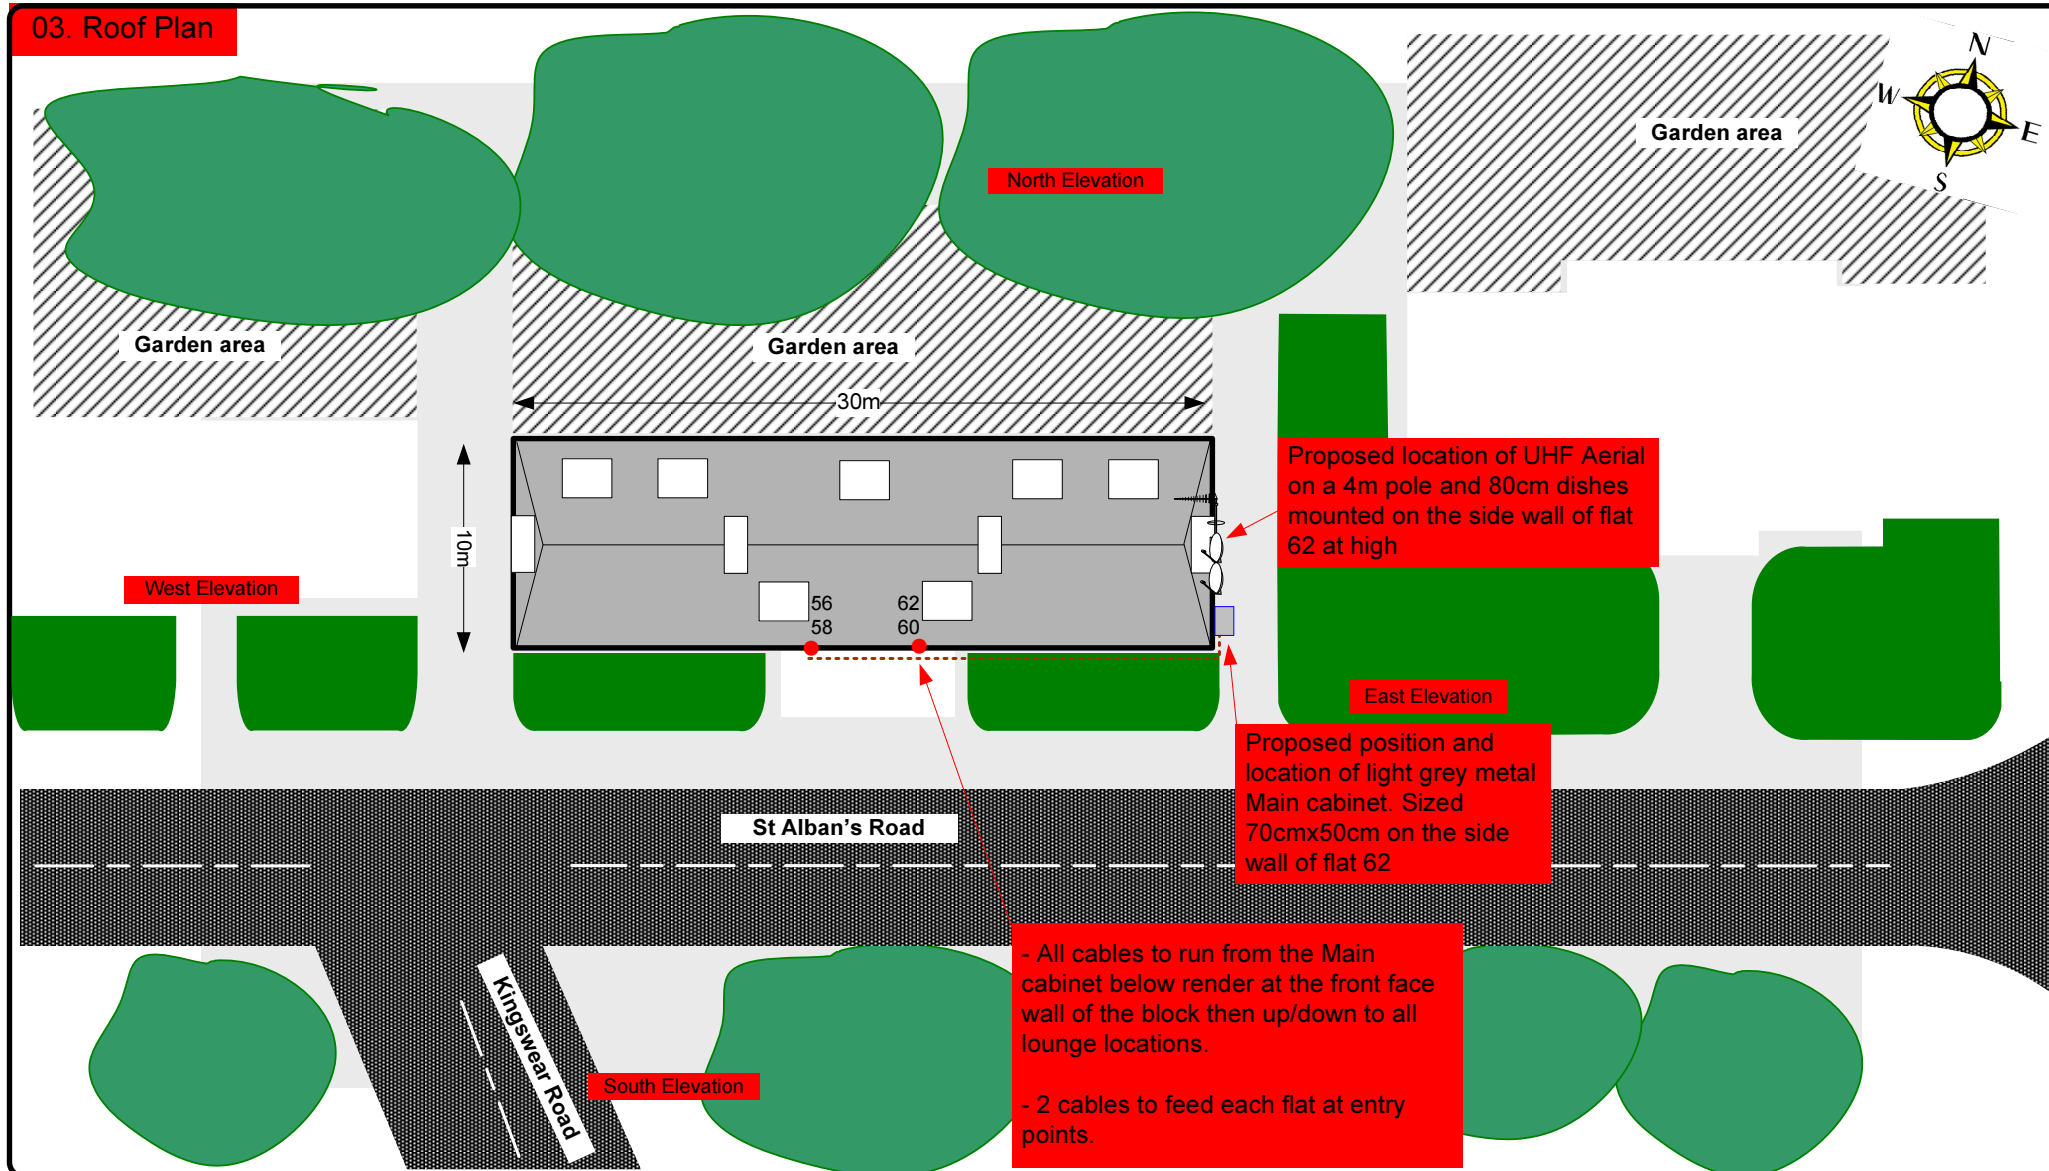

Form No. SCC 013 SCC International – 1 Fieldings Road, Cheshunt, Herts, EN8 9TL, . Tel: 01992 642255. Website: www.scci.co.uk

Drawing No. E14054/03 Site Address: 56-62 ST ALBANS ROAD, CAMDEN LONDON NW5 1RH

Date: 08/10/2011 Site Ref: LBC 0581.0 Surveyed By: G. Henebery

Number of Points: 4 System Type: 9Wire IRS Sky Plus Drawn By: W. Kisala



Please consider the environment before printing this document – Recycle Wherever Possible



Each property will have two cables to lounge position.

Cable Harness sizes

2-4 cables = 15mm

6-8 cables = 20mm


10-14 cables = 30mm

16-18 Cables = 35mm

20 cables = 40mm

40 cables = 65mm

60 cables = 90mm

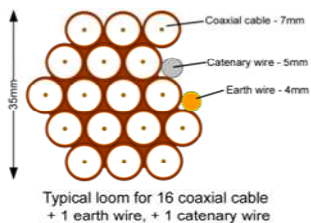

04. East Elevation



Form No. SCC 013 SCC International – 1 Fieldings Road, Cheshunt, Herts, EN8 9TL, . Tel: 01992 642255. Website: www.scci.co.uk



Please consider the environment before printing this document – Recycle Wherever Possible



Drawing No. E14054/04 Site Address: 56-62 ST ALBANS ROAD, CAMDEN LONDON NW5 1RH

Date: 08/10/2011 Site Ref: LBC 0581.0 Surveyed By: G. Henebery

Number of Points: 4 System Type: 9Wire IRS Sky Plus Drawn By: W. Kisala



Each property will have two cables to lounge position.

Cable Harness sizes

2-4 cables = 15mm

6-8 cables = 20mm


10-14 cables = 30mm

16-18 Cables = 35mm

20 cables = 40mm

40 cables = 65mm

60 cables = 90mm

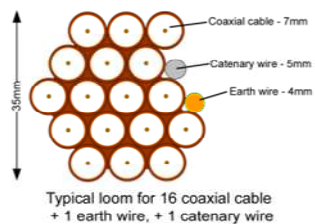

05.South Elevation 1



Form No. SCC 013 SCC International – 1 Fieldings Road, Cheshunt, Herts, EN8 9TL, . Tel: 01992 642255. Website: www.scci.co.uk

Drawing No. E14054/05 Site Address: 56-62 ST ALBANS ROAD, CAMDEN LONDON NW5 1RH

Date: 08/10/2011 Site Ref: LBC 0581.0 Surveyed By: G. Henebery

Number of Points: 4 System Type: 9Wire IRS Sky Plus Drawn By: W. Kisala



Please consider the environment before printing this document – Recycle Wherever Possible



Each property will have two cables to lounge position.

Cable Harness sizes

2-4 cables = 15mm

6-8 cables = 20mm


10-14 cables = 30mm

16-18 Cables = 35mm

20 cables = 40mm

40 cables = 65mm

60 cables = 90mm

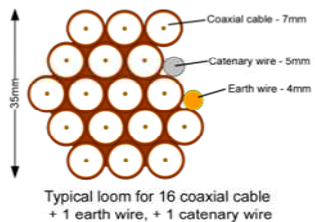

06. South Elevation 2

Proposed Brown cables to run below render then up/down to feed flats.

2 cables per flat at entry points



Form No. SCC 013 SCC International – 1 Fieldings Road, Cheshunt, Herts, EN8 9TL, . Tel: 01992 642255. Website: www.scci.co.uk

Drawing No. E14054/06 Site Address: 56-62 ST ALBANS ROAD, CAMDEN LONDON NW5 1RH

Date: 08/10/2011 Site Ref: LBC 0581.0 Surveyed By: G. Henebery

Number of Points: 4 System Type: 9Wire IRS Sky Plus Drawn By: W. Kisala



Please consider the environment before printing this document – Recycle Wherever Possible



Each property will have two cables to lounge position.

Cable Harness sizes

2-4 cables = 15mm

6-8 cables = 20mm


10-14 cables = 30mm

16-18 Cables = 35mm

20 cables = 40mm

40 cables = 65mm


60 cables = 90mm

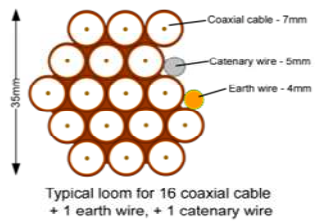

07. Existing Equipments



South West Elevation

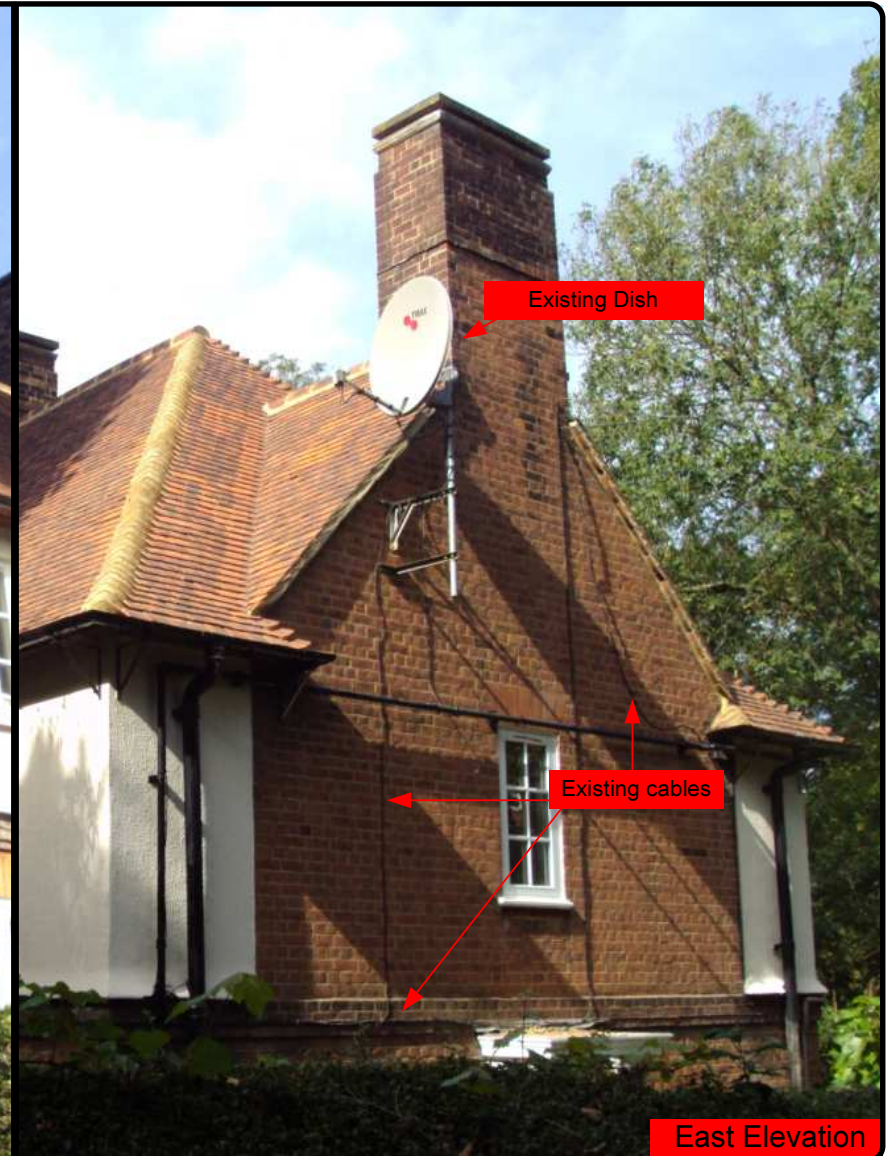

East Elevation

Form No. SCC 013 SCC International – 1 Fieldings Road, Cheshunt, Herts, EN8 9TL, . Tel: 01992 642255. Website: www.scci.co.uk

Drawing No.	E14054/07	Site Address:	56-62 ST ALBANS ROAD, CAMDEN LONDON NW5 1RH
Date:	08/10/2011	Site Ref:	LBC 0581.0
Number of Points:	4	System Type	9Wire IRS Sky Plus
		Surveyed By:	G. Henebery
		Drawn By:	W. Kisala




Please consider the environment before printing this document – Recycle Wherever Possible



08. Antenna and Dishes Measurements

Proposed location of UHF Aerial on a 4m pole and 80cm dishes on 1.5x1m poles mounted on the side wall of flat 62

Digital TV,
FM & DAB Radio
Aerials

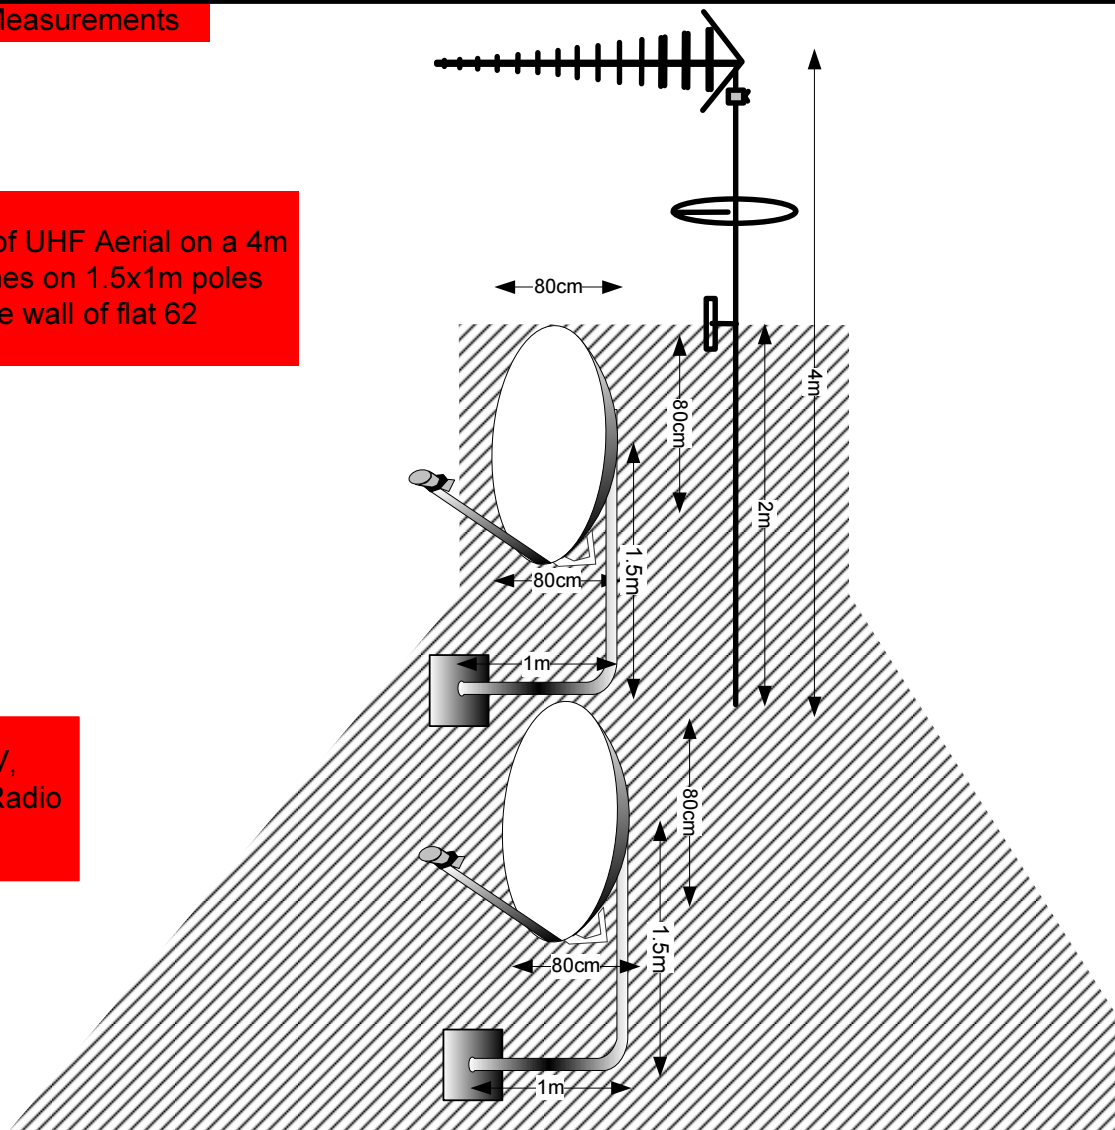

Form No. SCC 013 SCC International – 1 Fieldings Road, Cheshunt, Herts, EN8 9TL, . Tel: 01992 642255. Website: www.scci.co.uk

Drawing No.	E14054/08	Site Address:	56-62 ST ALBANS ROAD, CAMDEN LONDON NW5 1RH
Date:	08/10/2011	Site Ref:	LBC 0581.0
Number of Points:	4	System Type	9Wire IRS Sky Plus
		Surveyed By:	G. Henebery
		Drawn By:	W. Kisala



Please consider the environment before printing this document – Recycle Wherever Possible

