

00. INDEX

| Drawing Number | Drawing Title | Description |
|----------------|--|---|
| E00013/00 | Index | Index of Drawings. |
| E00013/01 | Location Plan | Scale 1:1250 at A4. |
| E00013/02 | Block Plan | Photo of Site from above. |
| E00013/03 | Roof Plan | Drawing of block from above, showing equipment positions. |
| E00013/04 | South West Elevation 1 | Description of cable routes, colour and loom sizes per flats at entry points for each drops |
| E00013/05 | South West Elevation 2 | Description of cable routes, colour and loom sizes per flats at entry points for each drops |
| E00013/06 | South West Elevation 3 | Description of cable routes, colour and loom sizes per flats at entry points for each drops |
| E00013/07 | Roof Elevation | Description and location of the antenna, dishes and main cabinet + mounting |
| E00013/08 | Cable Routes | Description of cable routes and loom per drops |
| E00013/09 | Existing Equipments | View and location of existing equipment on site |
| E00013/10 | Antenna, Dish Sizes & Typical Mounting Heights | Antenna and Dishes description, mounting, position, height and measurements. |

Form No. SCC 013 SCC International – 1 Fieldings Road, Cheshunt, Herts, EN8 9TL, . Tel: 01992 642255. Website: www.scci.co.uk


| | | | | | |
|-------------------|------------|---------------|--|--------------|-------------|
| Drawing No. | E00013/00 | Site Address: | 1-72 CECIL RHODES HOUSE, GOLDINGTON STREET, BARNET LONDON NW1 1NG | | |
| Date: | 18/10/2011 | Site Ref: | LBC143.0 | Surveyed By: | G. Henebery |
| Number of Points: | 72 | System Type | 9Wire IRS Sky Plus | Drawn By: | W. Kisala |



Please consider the environment before printing this document – Recycle Wherever Possible



02. Block Plan

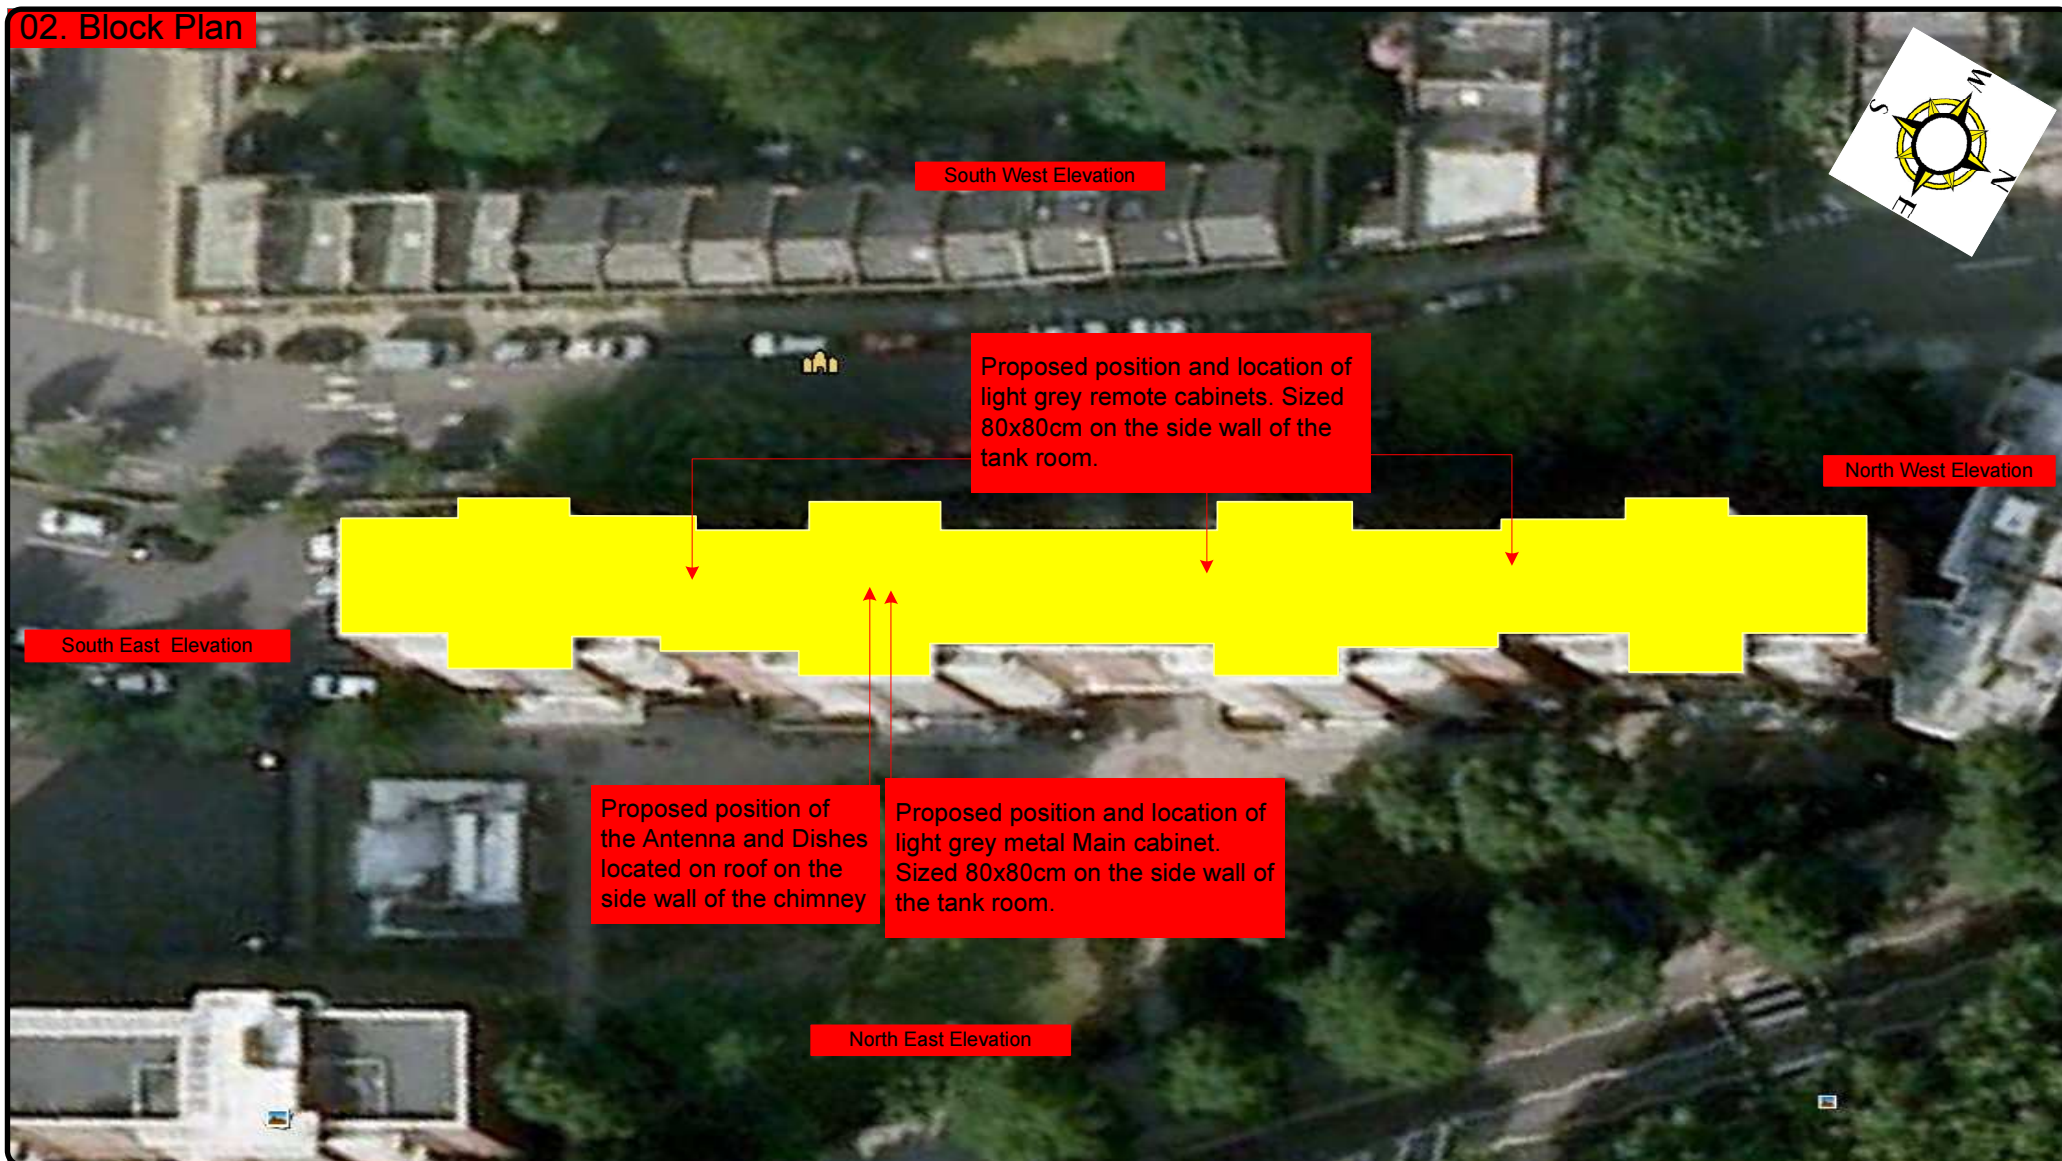

Form No. SCC 013 SCC International – 1 Fieldings Road, Cheshunt, Herts, EN8 9TL, . Tel: 01992 642255. Website: www.scci.co.uk



Please consider the environment before printing this document – Recycle Wherever Possible



Drawing No.

E00013/02

Site Address:

1-72 CECIL RHODES HOUSE, GOLDINGTON STREET, BARNET LONDON
NW1 1NG

Date:

18/10/2011

Site Ref:

LBC143.0

Surveyed By:

G. Henebery

Number of
Points:

72

System Type

9Wire IRS Sky Plus

Drawn By:

W. Kisala




03. Roof Plan

- All cables (brown) to run from the Main cabinet (located on the side wall of the tank room on roof) secured on tray and the face of parapet, linked to remotes then over the parapet edge vertically down to all lounge points of the building.
- 2 cables to feed each flat at entry points.

South West Elevation

Goldington Street

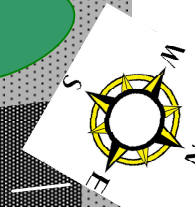


Proposed position and location of light grey remote cabinets. Sized 80x80cm on the side wall of the tank room.

Power located in the tank room on roof

North West Elevation

South East Elevation

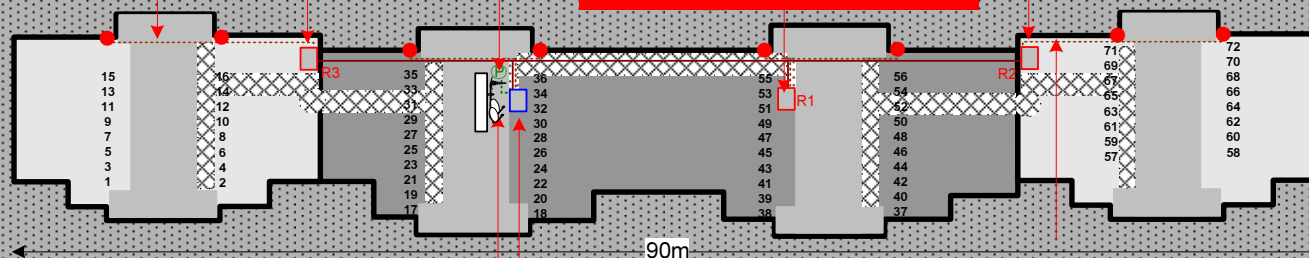

Proposed position of the Antenna and Dishes located on roof on the side wall of the chimney

Proposed position and location of light grey metal Main cabinet. Sized 80x80cm on the side wall of the tank room.

North East Elevation

Form No. SCC 013 SCC International – 1 Fieldings Road, Cheshunt, Herts, EN8 9TL . Tel: 01992 642255. Website: www.scci.co.uk



Please consider the environment before printing this document – Recycle Wherever Possible



| | | | | | |
|-------------------|------------|---------------|---|--------------|-------------|
| Drawing No. | E00013/03 | Site Address: | 1-72 CECIL RHODES HOUSE, GOLDINGTON STREET, BARNET LONDON NW1 1NG | | |
| Date: | 18/10/2011 | Site Ref: | LBC143.0 | Surveyed By: | G. Henebery |
| Number of Points: | 72 | System Type | 9Wire IRS Sky Plus | Drawn By: | W. Kisala |



Each property will have two cables to lounge position.

Cable Harness sizes

2-4 cables = 15mm

6-8 cables = 20mm


10-14 cables = 30mm

16-18 Cables = 35mm

20 cables = 40mm

40 cables = 65mm

60 cables = 90mm

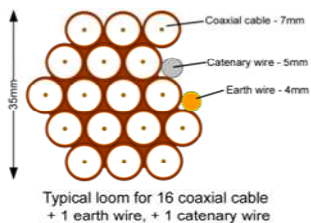

04. South West Elevation 1

Loom of 40 cables to exit the Main cabinet (H/E) then over the edge of the parapet on the high rise part of the building to feed flats at the rear wall of the block

Loom of 32 cables to exit the remote cabinet (R3) then over the edge of the parapet on the low rise part of the building to feed flats at the rear wall of the block



Form No. SCC 013 SCC International – 1 Fieldings Road, Cheshunt, Herts, EN8 9TL, . Tel: 01992 642255. Website: www.scci.co.uk

| | | | |
|-------------------|------------|---------------|---|
| Drawing No. | E00013/04 | Site Address: | 1-72 CECIL RHODES HOUSE, GOLDINGTON STREET, BARNET LONDON NW1 1NG |
| Date: | 18/10/2011 | Site Ref: | LBC143.0 |
| Number of Points: | 72 | System Type | 9Wire IRS Sky Plus |
| | | Surveyed By: | G. Henebery |
| | | Drawn By: | W. Kisala |



Please consider the environment before printing this document – Recycle Wherever Possible



Each property will have two cables to lounge position.

Cable Harness sizes

2-4 cables = 15mm

6-8 cables = 20mm


10-14 cables = 30mm

16-18 Cables = 35mm

20 cables = 40mm


40 cables = 65mm

60 cables = 90mm

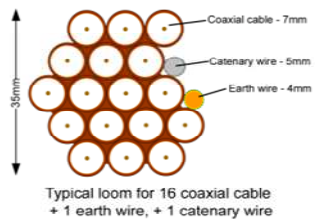

05. South West Elevation 2

- All cables (brown) to drop over the parapet wall then vertically down and French bolted to the wall and feed all lounge points of the block.
- 2 cables to feed each flat at entry points.

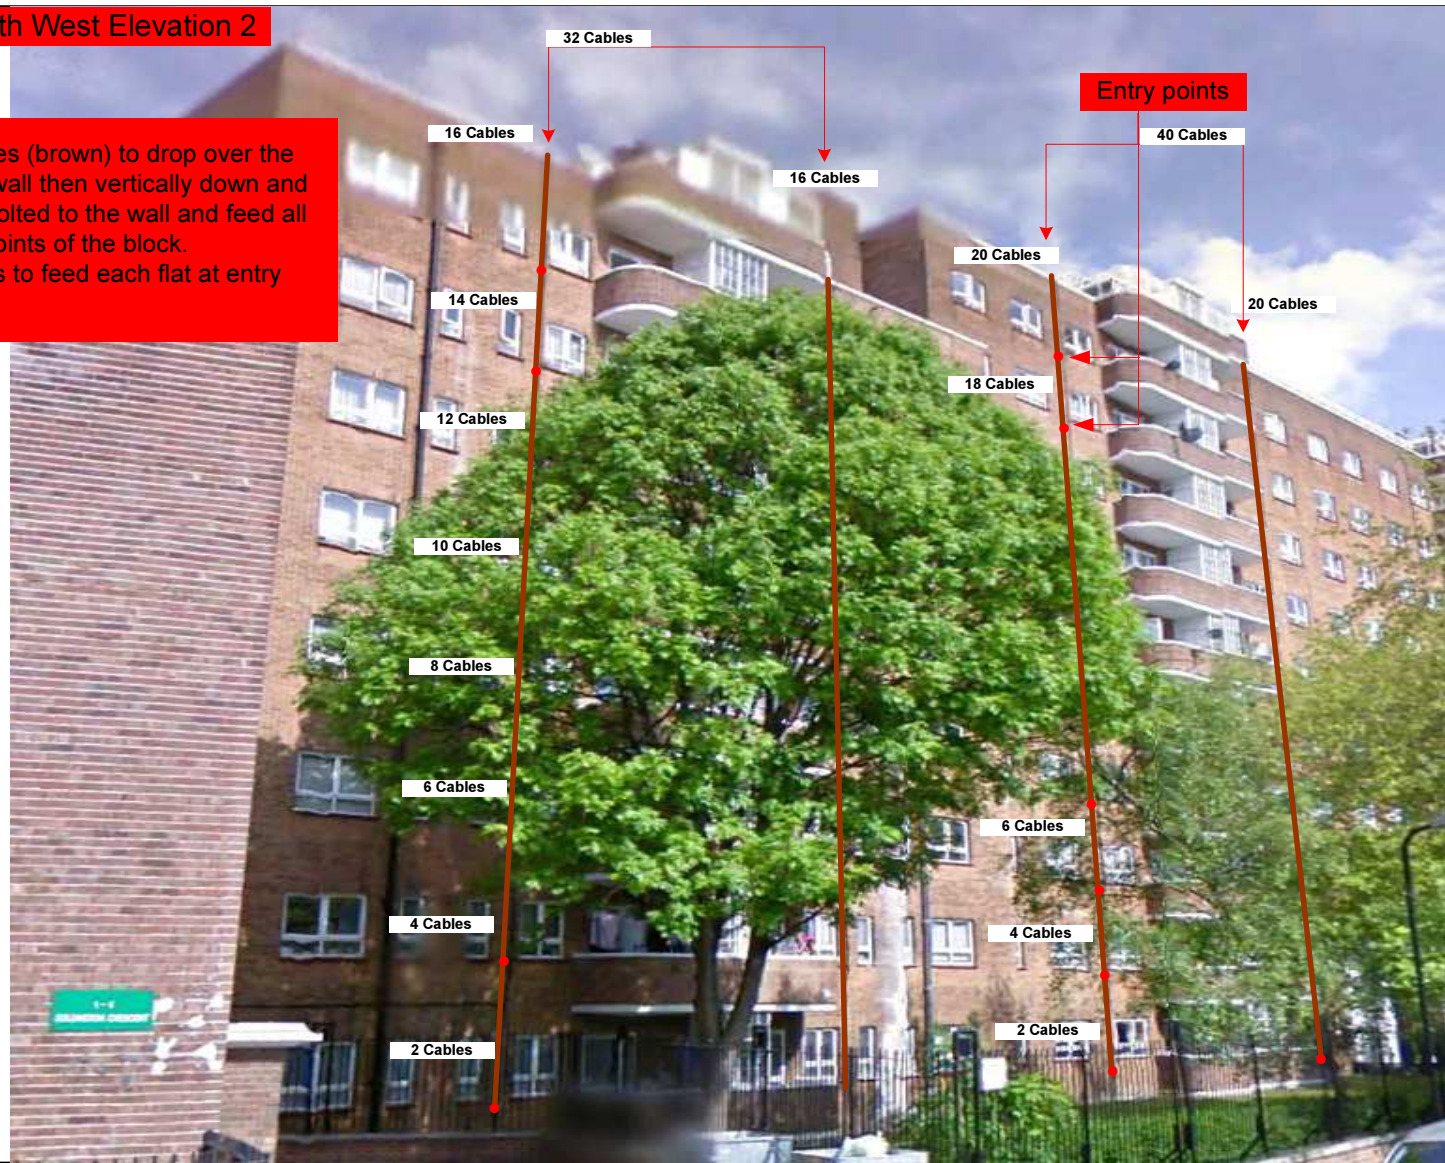

Form No. SCC 013 SCC International – 1 Fieldings Road, Cheshunt, Herts, EN8 9TL, . Tel: 01992 642255. Website: www.scci.co.uk

| | | | | |
|-------------------|------------|---------------|---|--------------------------|
| Drawing No. | E00013/05 | Site Address: | 1-72 CECIL RHODES HOUSE, GOLDINGTON STREET, BARNET LONDON NW1 1NG | |
| Date: | 18/10/2011 | Site Ref: | LBC143.0 | Surveyed By: G. Henebery |
| Number of Points: | 72 | System Type | 9Wire IRS Sky Plus | Drawn By: W. Kisala |



Please consider the environment before printing this document – Recycle Wherever Possible



Each property will have two cables to lounge position.

Cable Harness sizes

2-4 cables = 15mm

6-8 cables = 20mm


10-14 cables = 30mm

16-18 Cables = 35mm

20 cables = 40mm

40 cables = 65mm

60 cables = 90mm

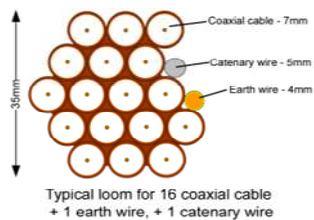

06. South West Elevation 3



Form No. SCC 013 SCC International – 1 Fieldings Road, Cheshunt, Herts, EN8 9TL, . Tel: 01992 642255. Website: www.scci.co.uk

| | | | | | |
|-------------------|------------|---------------|---|--------------|-------------|
| Drawing No. | E00013/06 | Site Address: | 1-72 CECIL RHODES HOUSE, GOLDINGTON STREET, BARNET LONDON NW1 1NG | | |
| Date: | 18/10/2011 | Site Ref: | LBC143.0 | Surveyed By: | G. Henebery |
| Number of Points: | 72 | System Type | 9Wire IRS Sky Plus | Drawn By: | W. Kisala |



Please consider the environment before printing this document – Recycle Wherever Possible



Each property will have two cables to lounge position.

Cable Harness sizes

2-4 cables = 15mm

6-8 cables = 20mm


10-14 cables = 30mm

16-18 Cables = 35mm

20 cables = 40mm

40 cables = 65mm


60 cables = 90mm

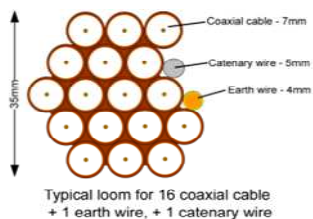

07. Roof elevation

Proposed location of UHF Aerial on a 3.5m pole mounted using wall bracket and 80cm dishes mounted using lashing kits. all installed on the side wall the chimney above tank room on roof.

Proposed position and location of light grey metal Main cabinet. Sized 80x80cm on the side wall of the tank room on roof.

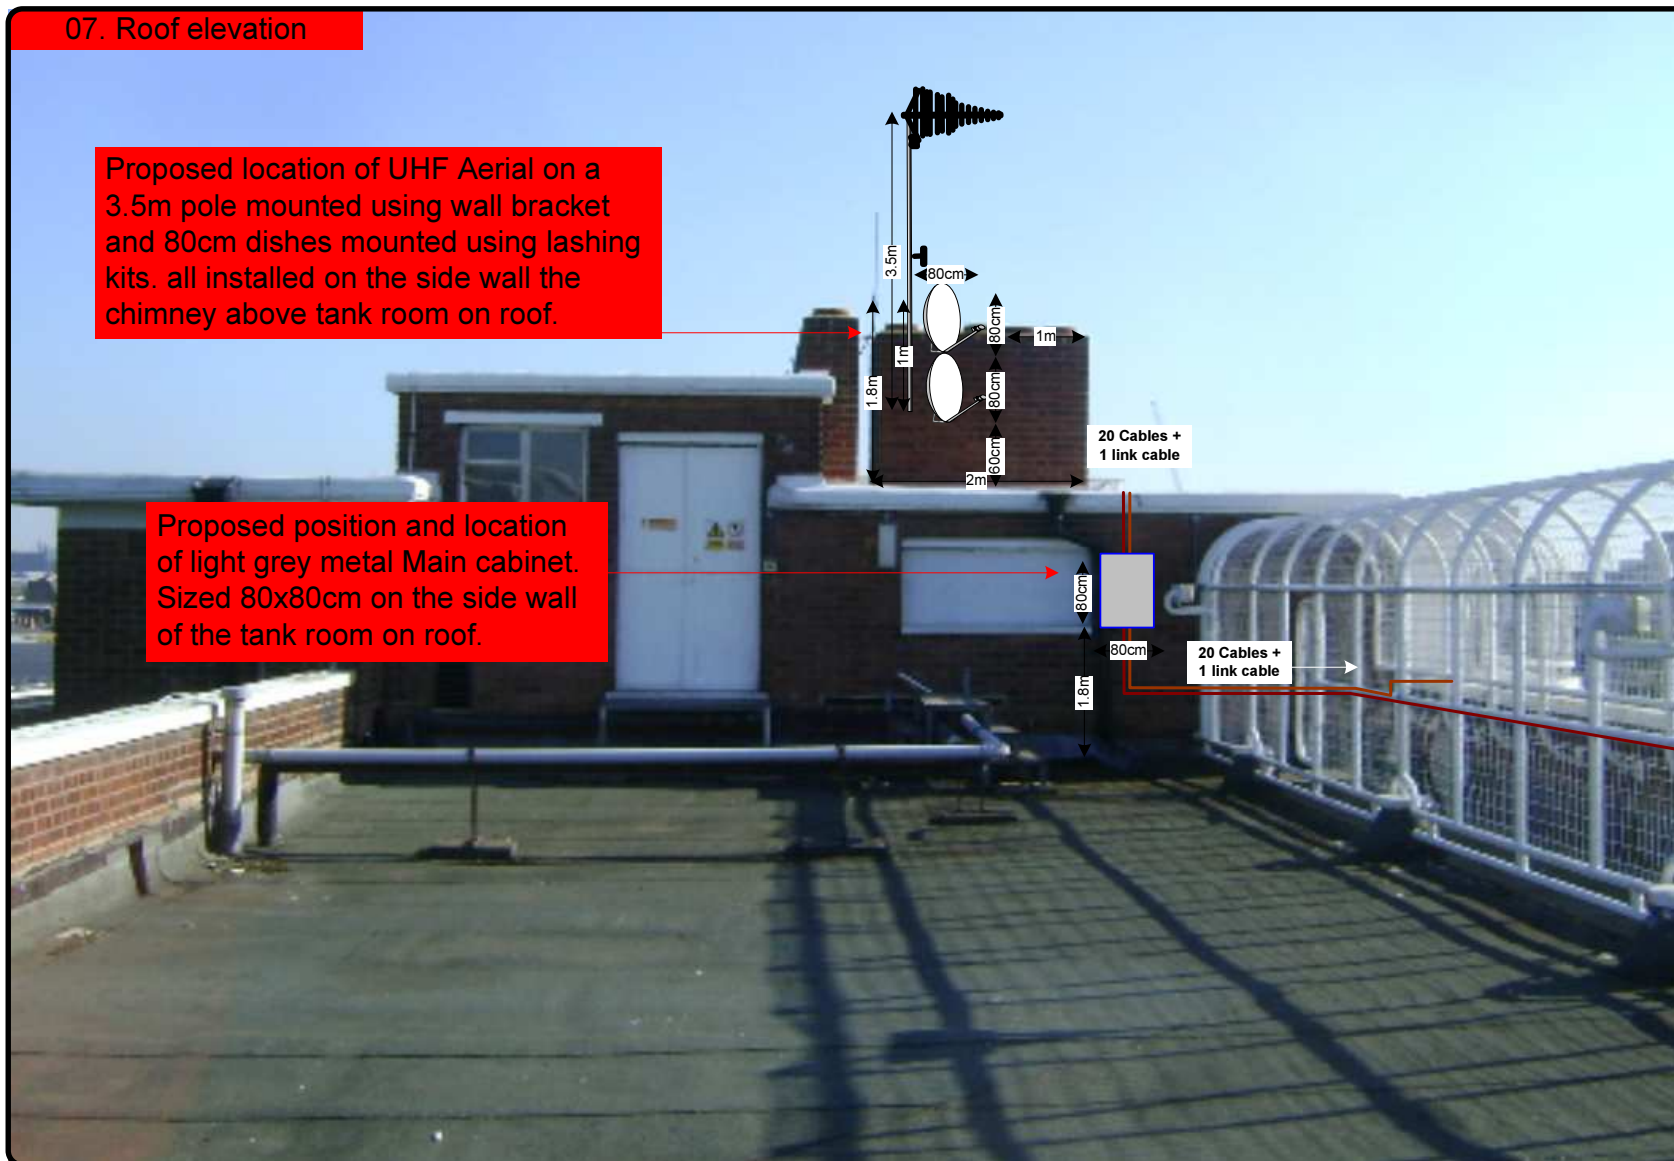

Form No. SCC 013 SCC International – 1 Fieldings Road, Cheshunt, Herts, EN8 9TL, . Tel: 01992 642255. Website: www.scci.co.uk

| | | | | | |
|-------------------|------------|---------------|---|--------------|-------------|
| Drawing No. | E00013/07 | Site Address: | 1-72 CECIL RHODES HOUSE, GOLDINGTON STREET, BARNET LONDON NW1 1NG | | |
| Date: | 18/10/2011 | Site Ref: | LBC143.0 | Surveyed By: | G. Henebery |
| Number of Points: | 72 | System Type | 9Wire IRS Sky Plus | Drawn By: | W. Kisala |



Please consider the environment before printing this document – Recycle Wherever Possible



Each property will have two cables to lounge position.

Cable Harness sizes

2-4 cables = 15mm

6-8 cables = 20mm


10-14 cables = 30mm

16-18 Cables = 35mm

20 cables = 40mm

40 cables = 65mm

60 cables = 90mm

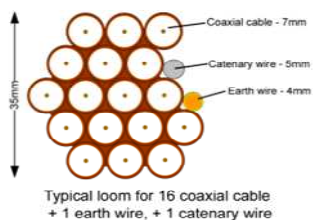

08. Cable Routes

-Proposed description of how would cables run over the edge of the parapet wall on the low rise part of the building.

- Loom of 16 cables to drop from this end and feed flats at entry points.

- 2 cables per flats.

16 Cables

Roof elevation

-Proposed description of link + sub cables on the parapet wall of the high rise part of the building.

- Loom of 20+ link cable to exit main cabinet and drop over the parapet wall to lounge positions.

- Loom of 20 to exit the Remote cabinet (R1) and over the parapet wall down to feed flats at entry points.

- 2 cables per flats.

20 Cables

20 Cables

From Remote Cabinet (R1)

From Main Cabinet

Link cable

Roof elevation

Form No. SCC 013 SCC International – 1 Fieldings Road, Cheshunt, Herts, EN8 9TL, . Tel: 01992 642255. Website: www.scci.co.uk

| | | | |
|-------------------|------------|---------------|---|
| Drawing No. | E00013/08 | Site Address: | 1-72 CECIL RHODES HOUSE, GOLDINGTON STREET, BARNET LONDON NW1 1NG |
| Date: | 18/10/2011 | Site Ref: | LBC143.0 |
| Number of Points: | 72 | System Type | 9Wire IRS Sky Plus |
| | | Surveyed By: | G. Henebery |
| | | Drawn By: | W. Kisala |



Please consider the environment before printing this document – Recycle Wherever Possible



Each property will have two cables to lounge position.

Cable Harness sizes

2-4 cables = 15mm

6-8 cables = 20mm


10-14 cables = 30mm

16-18 Cables = 35mm

20 cables = 40mm

40 cables = 65mm


60 cables = 90mm

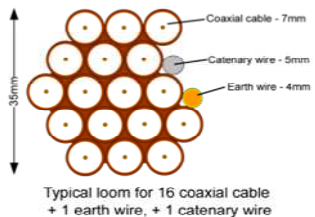

09. Existing Equipments



South Elevation

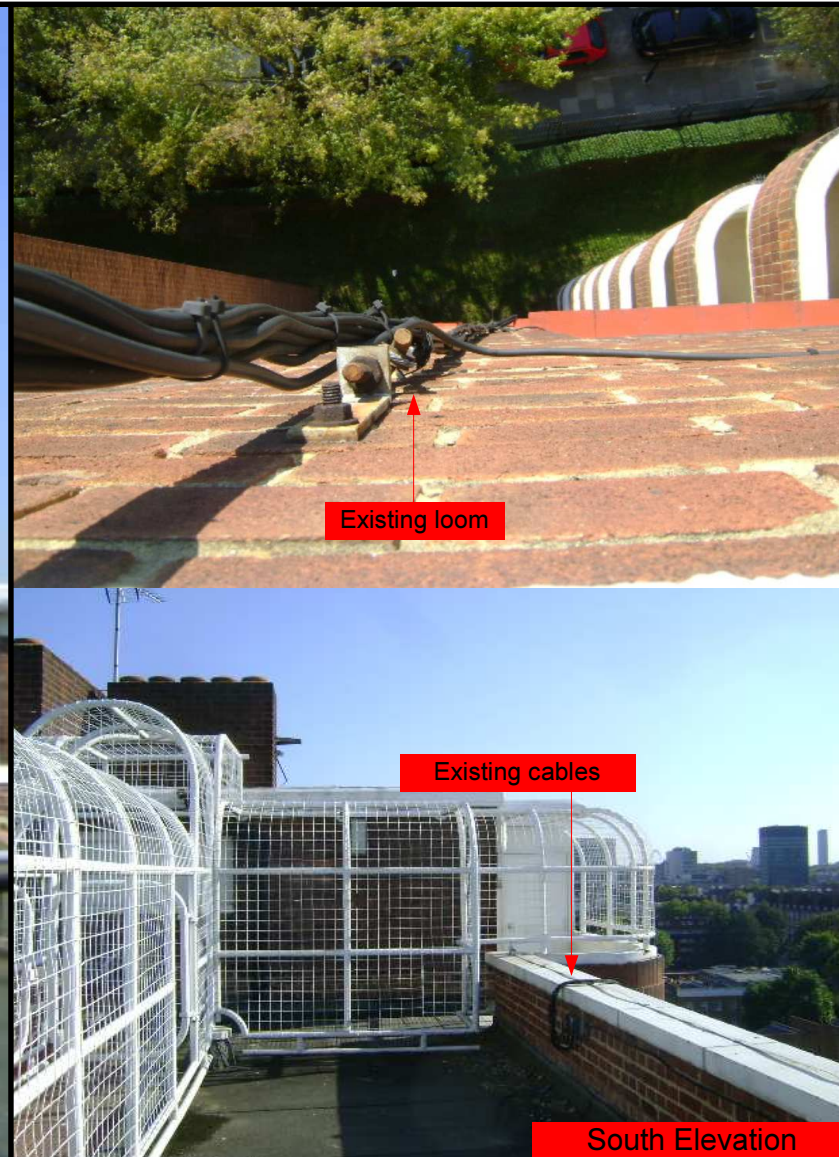

South Elevation

Form No. SCC 013 SCC International – 1 Fieldings Road, Cheshunt, Herts, EN8 9TL, . Tel: 01992 642255. Website: www.scci.co.uk

| | | | | | |
|-------------------|------------|---------------|---|--------------|-------------|
| Drawing No. | E00013/09 | Site Address: | 1-72 CECIL RHODES HOUSE, GOLDINGTON STREET, BARNET LONDON NW1 1NG | | |
| Date: | 18/10/2011 | Site Ref: | LBC143.0 | Surveyed By: | G. Henebery |
| Number of Points: | 72 | System Type | 9Wire IRS Sky Plus | Drawn By: | W. Kisala |




Please consider the environment before printing this document – Recycle Wherever Possible



10. Antenna and Dishes Measurements

Digital TV,
FM & DAB Radio
Aerials

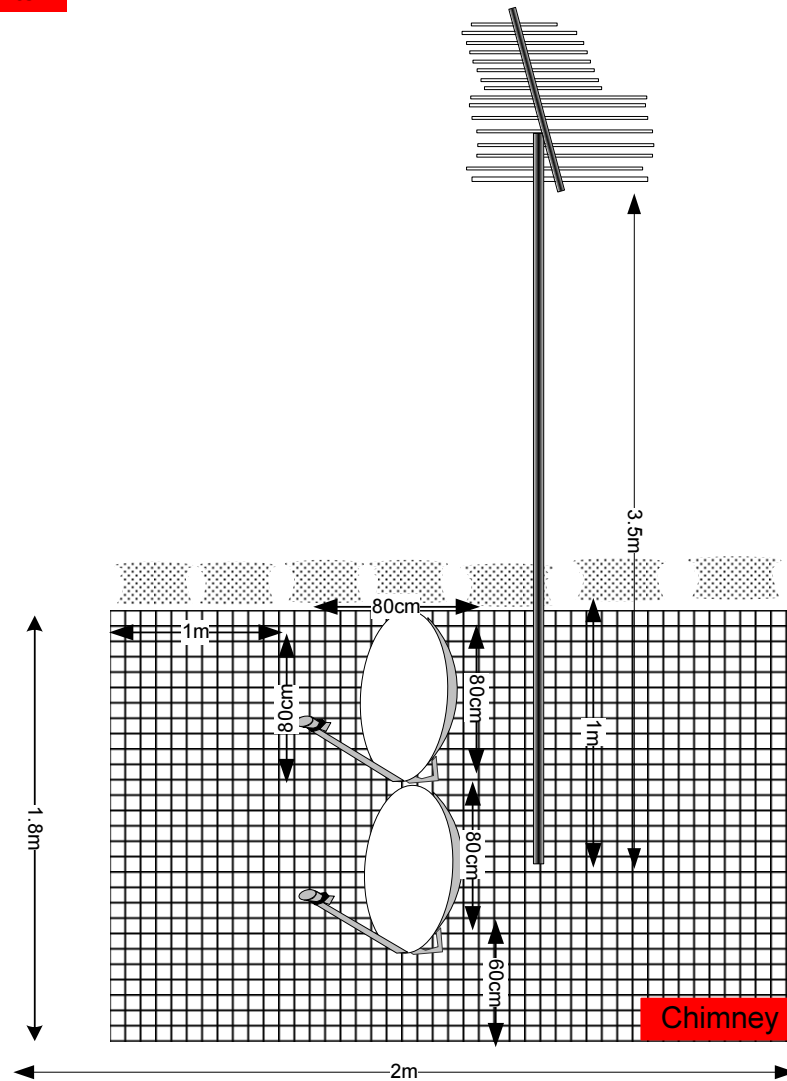

Proposed location of UHF Aerial on a 3m pole mounted using wall bracket and 80cm dishes mounted using lashing kits. all installed on the side of the chimney above the tank room

Form No. SCC 013 SCC International – 1 Fieldings Road, Cheshunt, Herts, EN8 9TL. . Tel: 01992 642255. Website: www.scci.co.uk

| | | | |
|-------------------|------------|---------------|---|
| Drawing No. | E00013/10 | Site Address: | 1-72 CECIL RHODES HOUSE, GOLDINGTON STREET, BARNET LONDON NW1 1NG |
| Date: | 18/10/2011 | Site Ref: | LBC143.0 |
| Number of Points: | 72 | System Type | 9Wire IRS Sky Plus |
| | | Drawn By: | W. Kisala |



Please consider the environment before printing this document – Recycle Wherever Possible

