

00. INDEX


Drawing Number	Drawing Title	Description
E13013/00	Index	Index of Drawings.
E13013/02	Location Plan	Scale 1:1250 at A4.
E13013/03	Block Plan	Photo of Site from above.
E13013/04	Roof Plan	Drawing of block from above, showing equipment positions.
E13013/05	West Elevation	Description of Cable routes, loom sizes and entry points and Description and location of the antenna and dishes + mounting and measurements.
E13013/06	South & East Elevation	Description of Cable routes, loom sizes and entry points.
E13013/07	North & East Elevation	Description of Cable routes, loom sizes and entry points.
E13013/08	Inside Elevation	Description and location of the Main cabinet size, colour + measurements.
E13013/09	Existing Equipments	Description, location and view of the existing equipment on site before install.
E13013/010	Antenna, Dish Sizes & Typical Mounting Heights	Sketch of the Antenna and Dishes + mounting, position and height.

Form No. SCC 013 SCC International – 1 Fieldings Road, Cheshunt, Herts, EN8 9TL, . Tel: 01992 642255. Website: www.scci.co.uk


Drawing No.	E13013/00	Site Address:	1-10 Cranley Buildings, Dorrington Street, Camden, London, EC1N 7SY		
Date:	14 th Oct 11	Site Ref:	LBC0429.0	Surveyed By:	Danny Varleigh
Number of Points:	10	System Type	9Wire IRS Sky Plus	Drawn By:	James Schroder



Please consider the environment before printing this document – Recycle Wherever Possible

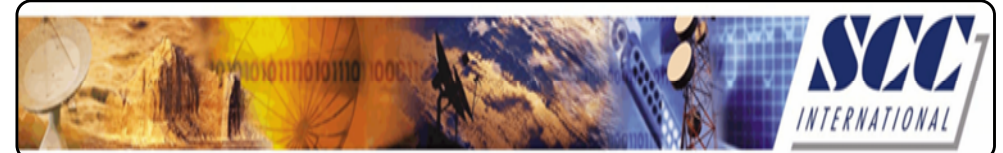

02. Block Plan

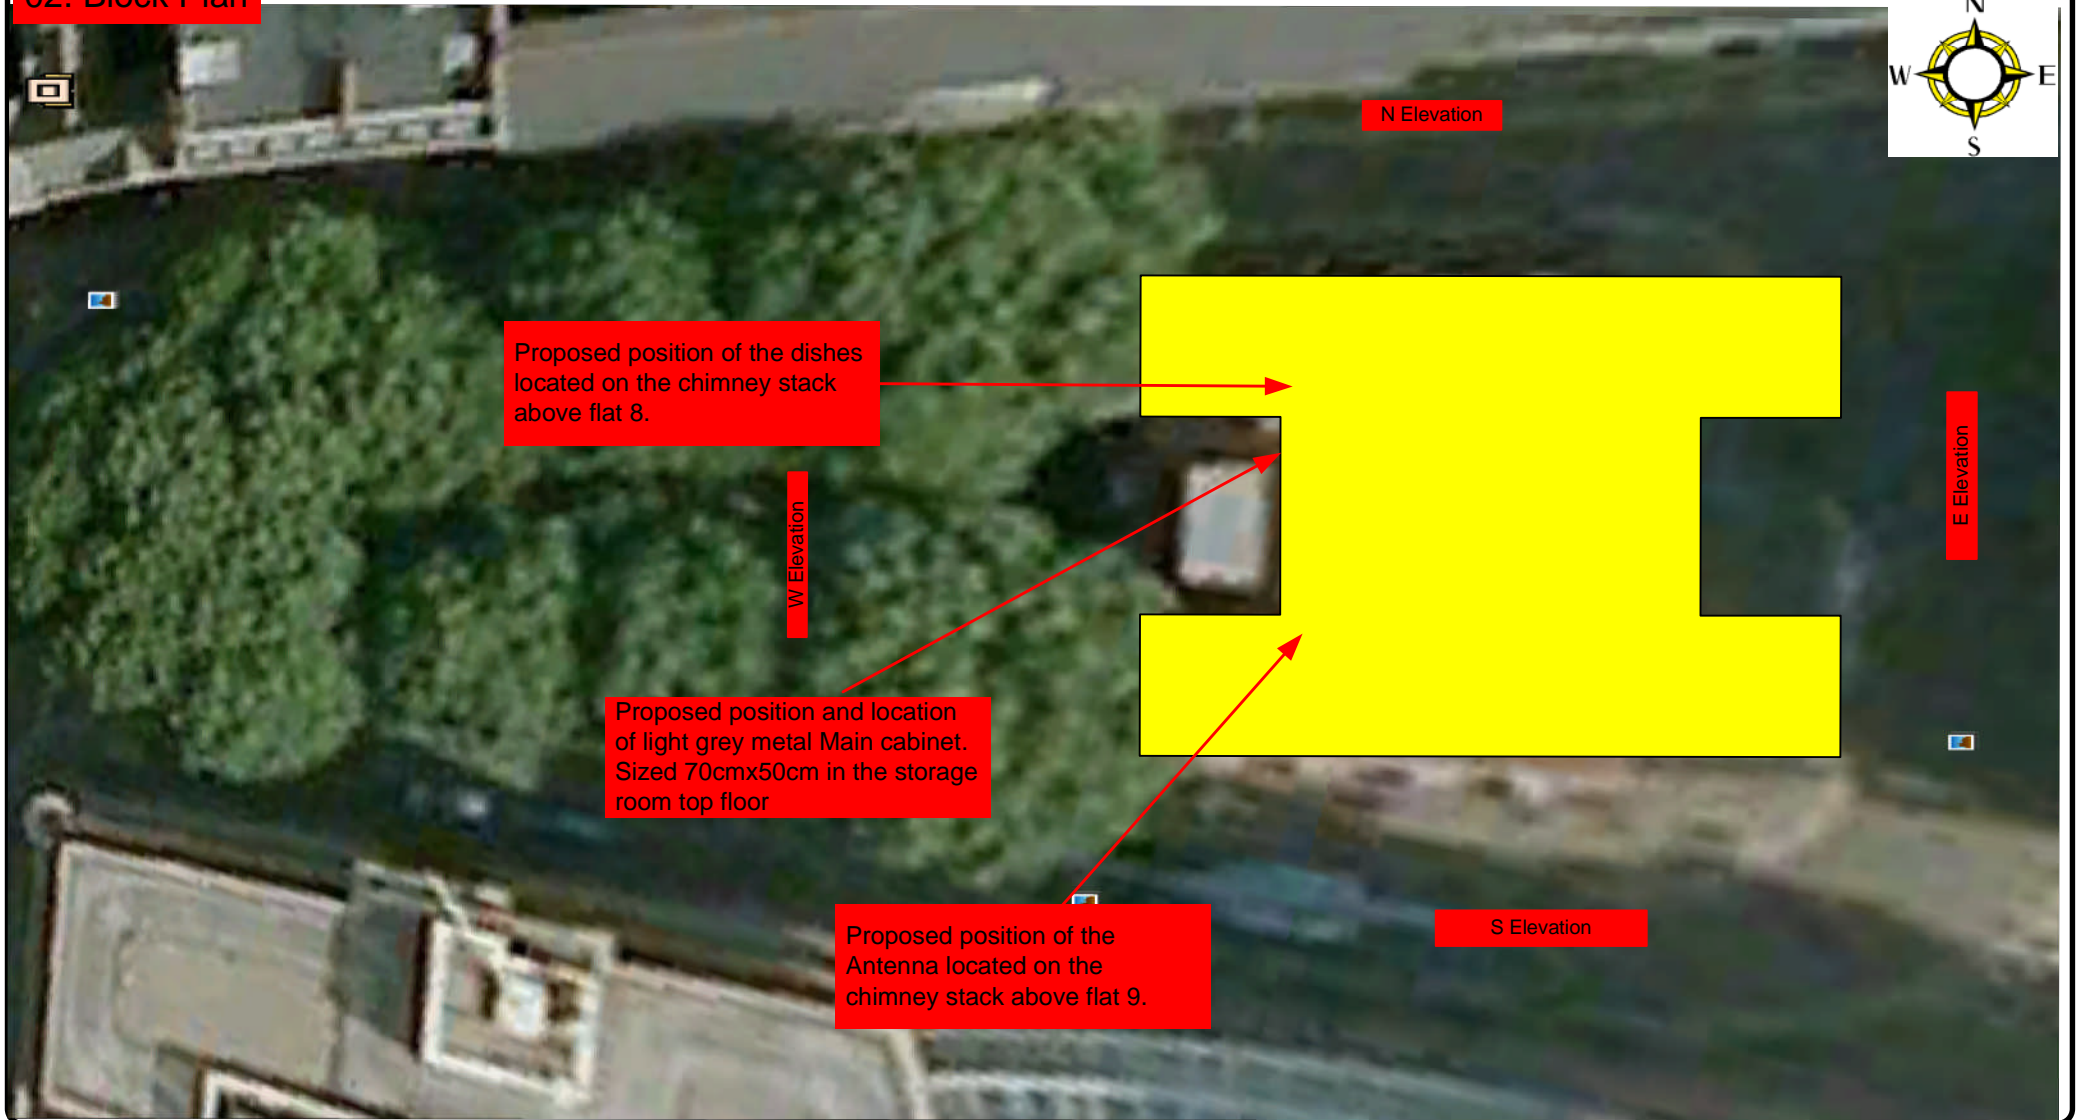

Form No. SCC 013 SCC International – 1 Fieldings Road, Cheshunt, Herts, EN8 9TL, . Tel: 01992 642255. Website: www.scci.co.uk



Please consider the environment before printing this document – Recycle Wherever Possible



Drawing No.	E13013/02	Site Address:	1-10 Cranley Buildings, Dorrington Street, Camden, London, EC1N 7SY		
Date:	14 th Oct 11	Site Ref:	LBC0429.0	Surveyed By:	Danny Varleigh
Number of Points:	10	System Type	9Wire IRS Sky Plus	Drawn By:	James Schroder




03. Roof Plan

Proposed position and location of light grey metal Main cabinet. Sized 70cmx50cm in the storage room top floor

Dorrington Street

Proposed position of the Antenna located on the chimney stack above flat 9 and Dishes located on the chimney stack above flat 8.

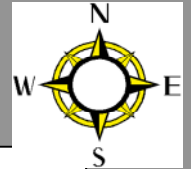

N Elevation

Intake cupboard for the power is located in the hallway ground floor.

E Elevation

Brooke's Market

Public Square

W Elevation

S Elevation

Beauchamp Street

-Loom work from H/E in storage room on the top floor Brown PVC cables to exit the H/E and run under the soffit at high level. To feed flats at rear wall of the building.
-2 cables per flat at entry points.

Form No. SCC 013 SCC International – 1 Fieldings Road, Cheshunt, Herts, EN8 9TL. . Tel: 01992 642255. Website: www.scci.co.uk

Please consider the environment before printing this document – Recycle Wherever Possible

Drawing No.	E13013/03	Site Address:	1-10 Cranley Buildings, Dorington Street, Camden, London, EC1N 7SY
Date:	14 th Oct 11	Site Ref:	LBC0429.0
Number of Points:	10	System Type	9Wire IRS Sky Plus
		Surveyed By:	Danny Varleigh
		Drawn By:	James Schroder



Each property will have two cables to lounge position.

Cable Harness sizes

2-4 cables = 15mm

6-8 cables = 20mm


10-14 cables = 30mm

16-18 Cables = 35mm


20 cables = 40mm

40 cables = 65mm

60 cables = 90mm

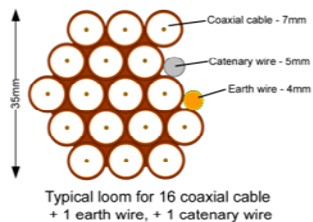

04. West Elevation.

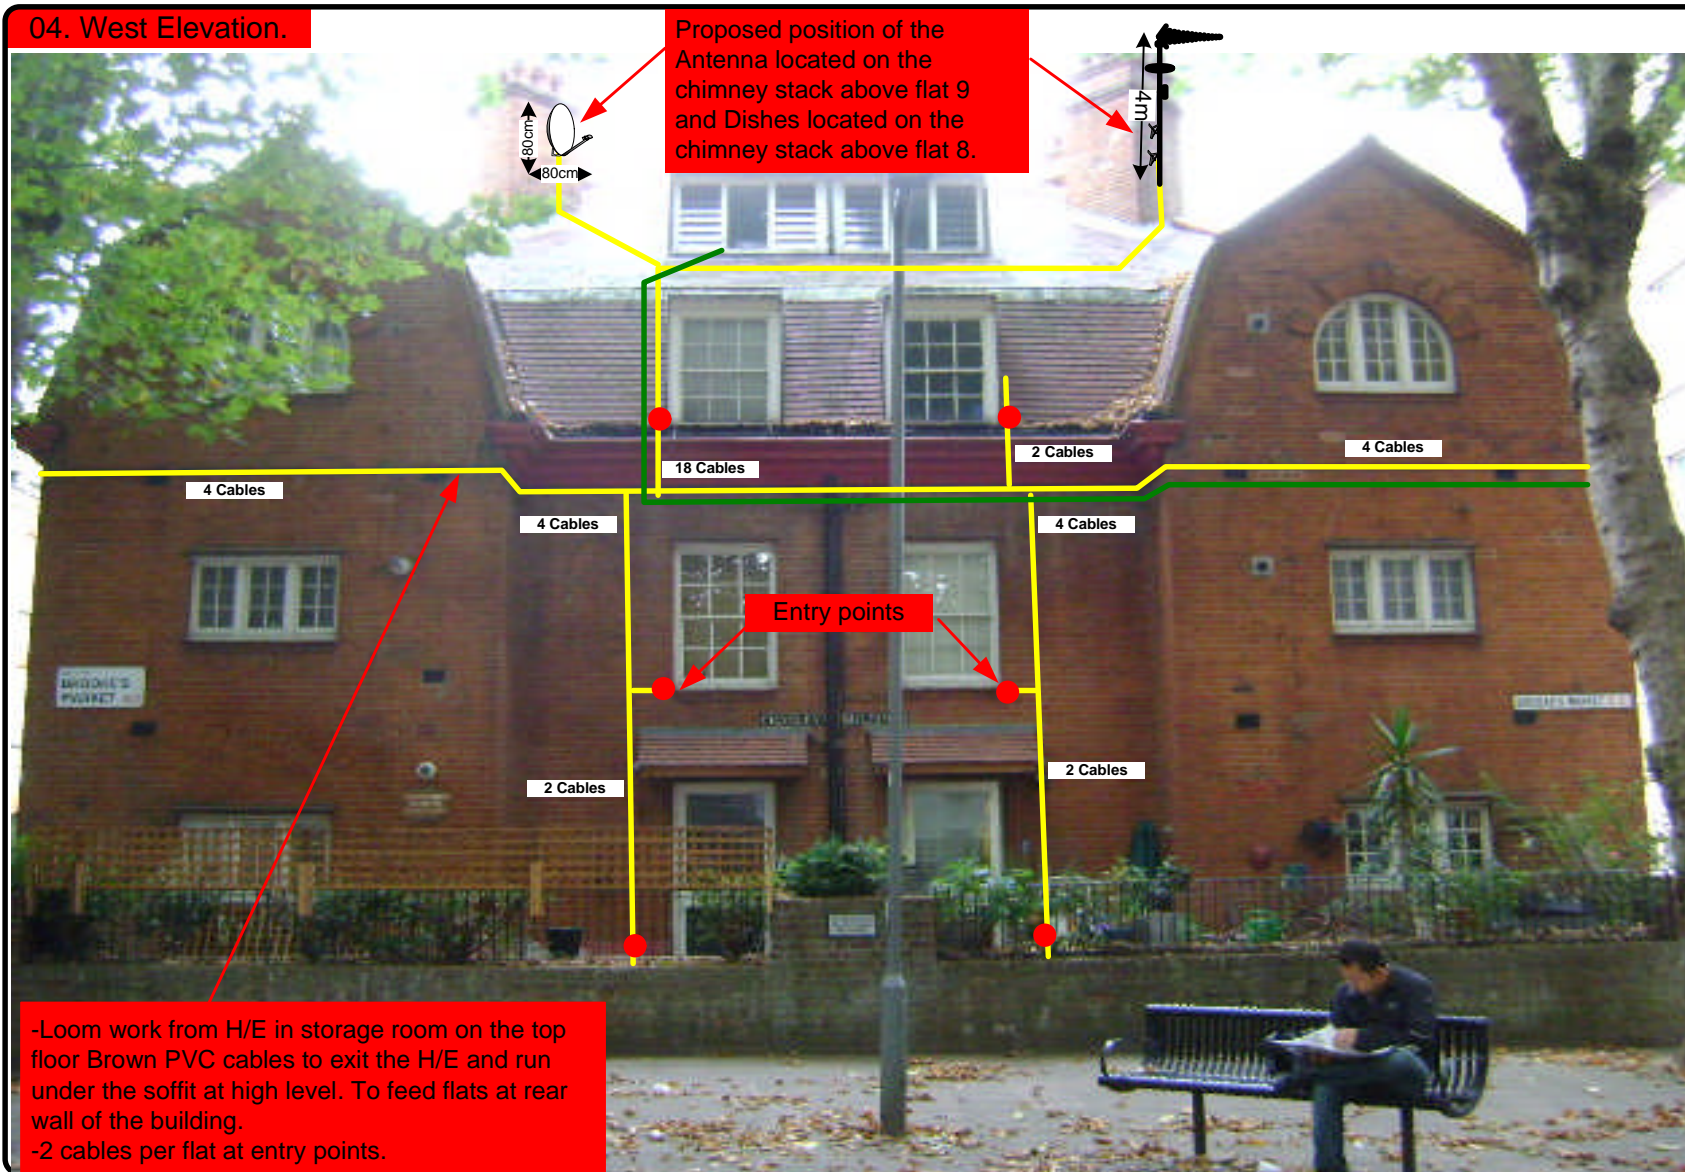

Form No. SCC 013 SCC International – 1 Fieldings Road, Cheshunt, Herts, EN8 9TL, . Tel: 01992 642255. Website: www.scci.co.uk



Please consider the environment before printing this document – Recycle Wherever Possible



Drawing No.	E13013/04	Site Address:	1-10 Cranley Buildings, Dorrington Street, Camden, London, EC1N 7SY
Date:	14 th Oct 11	Site Ref:	LBC0429.0
Number of Points:	10	System Type	9Wire IRS Sky Plus
		Surveyed By:	Danny Varleigh
		Drawn By:	James Schroder



Each property will have two cables to lounge position.

Cable Harness sizes

2-4 cables = 15mm

6-8 cables = 20mm


10-14 cables = 30mm

16-18 Cables = 35mm

20 cables = 40mm

40 cables = 65mm

60 cables = 90mm

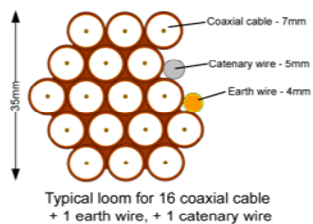

05. South & east Elevation

-Loom work from H/E in storage room on the top floor Brown PVC cables to exit the H/E and run under the soffit at high level. To feed flats at rear wall of the building.
-2 cables per flat at entry points.



Form No. SCC 013 SCC International – 1 Fieldings Road, Cheshunt, Herts, EN8 9TL, . Tel: 01992 642255. Website: www.scci.co.uk



Please consider the environment before printing this document – Recycle Wherever Possible



Drawing No.	E13013/05	Site Address:	1-10 Cranley Buildings, Dorrington Street, Camden, London, EC1N 7SY
Date:	14 th Oct 11	Site Ref:	LBC0429.0
Number of Points:	10	System Type	9Wire IRS Sky Plus
		Surveyed By:	Danny Varleigh
		Drawn By:	James Schroder



Each property will have two cables to lounge position.

Cable Harness sizes

2-4 cables = 15mm

6-8 cables = 20mm


10-14 cables = 30mm

16-18 Cables = 35mm

20 cables = 40mm

40 cables = 65mm

60 cables = 90mm

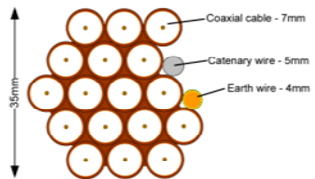

Typical loom for 16 coaxial cable
+ 1 earth wire, + 1 catenary wire

06. North & East Elevation

-Loom work from H/E in storage room on the top floor Brown PVC cables to exit the H/E and run under the soffit at high level. To feed flats at rear wall of the building.
-2 cables per flat at entry points.



Form No. SCC 013 SCC International – 1 Fieldings Road, Cheshunt, Herts, EN8 9TL. - Tel: 01992 642255. Website: www.scci.co.uk

Drawing No.	E13013/06	Site Address:	1-10 Cranley Buildings, Dorrington Street, Camden, London, EC1N 7SY		
Date:	14 th Oct 11	Site Ref:	LBC0429.0	Surveyed By:	Danny Varleigh
Number of Points:	10	System Type	9Wire IRS Sky Plus	Drawn By:	James Schroder



Please consider the environment before printing this document – Recycle Wherever Possible



Each property will have two cables to lounge position.

Cable Harness sizes

2-4 cables = 15mm

6-8 cables = 20mm


10-14 cables = 30mm

16-18 Cables = 35mm

20 cables = 40mm

40 cables = 65mm


60 cables = 90mm

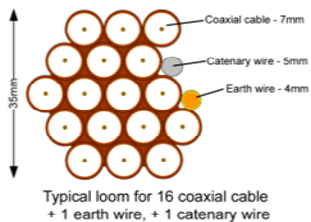

07. Inside Elevation

Proposed position and location of light grey metal Main cabinet. Sized 70cmx50cm in the storage room top floor.

-Loom work from H/E in top floor storage room. Brown PVC cables to exit the H/E and out of the building and under soffits at height.. To feed flats at rear and sides of the building.
-2 cables per flat at entry points.

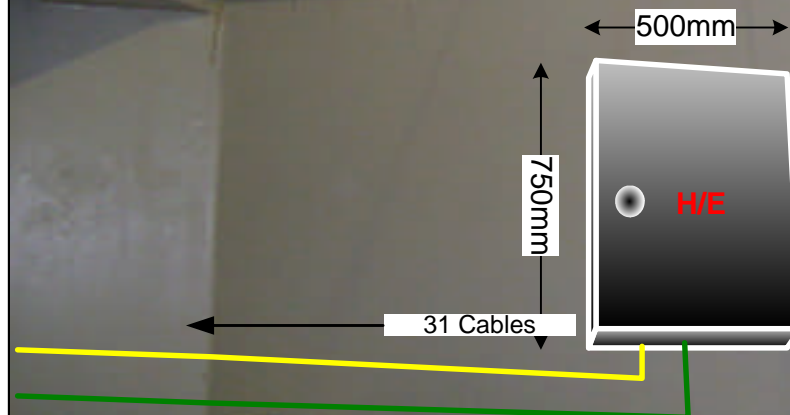

Form No. SCC 013 SCC International – 1 Fieldings Road, Cheshunt, Herts, EN8 9TL, . Tel: 01992 642255. Website: www.scci.co.uk



Please consider the environment before printing this document – Recycle Wherever Possible



Drawing No.	E13013/07	Site Address:	1-10 Cranley Buildings, Dorrington Street, Camden, London, EC1N 7SY
Date:	14 th Oct 11	Site Ref:	LBC0429.0
Number of Points:	10	System Type	9Wire IRS Sky Plus
		Surveyed By:	Danny Varleigh
		Drawn By:	James Schroder



Each property will have two cables to lounge position.

Cable Harness sizes

2-4 cables = 15mm

6-8 cables = 20mm


10-14 cables = 30mm

16-18 Cables = 35mm

20 cables = 40mm

40 cables = 65mm

60 cables = 90mm

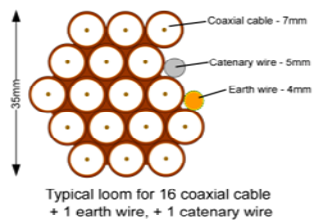

08. Existing Equipments

West Elevation.



Form No. SCC 013 SCC International – 1 Fieldings Road, Cheshunt, Herts, EN8 9TL . Tel: 01992 642255. Website: www.scci.co.uk

Drawing No.	E13013/08	Site Address:	1-10 Cranley Buildings, Dorrington Street, Camden, London, EC1N 7SY		
Date:	14 th Oct 11	Site Ref:	LBC0429.0	Surveyed By:	Danny Varleigh
Number of Points:	10	System Type	9Wire IRS Sky Plus	Drawn By:	James Schroder




Please consider the environment before printing this document – Recycle Wherever Possible




09. Antenna and Dishes Measurements

Digital TV,
FM & DAB Radio
Aerials

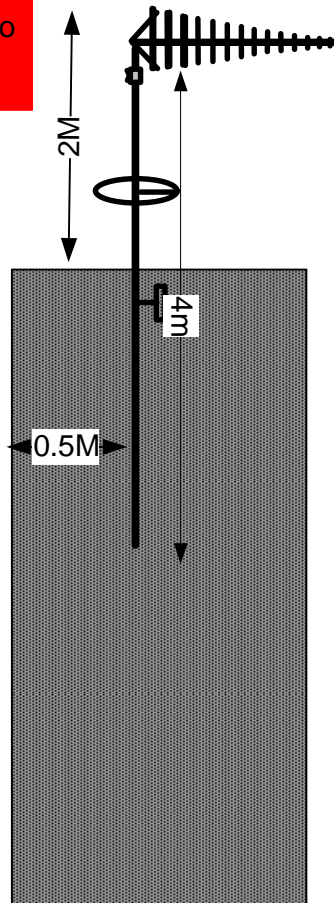

Proposed location of UHF Aerial on a 4m pole located on the chimney stack above flat 9 and 80cm dishes mounted using a lashing kit located on the chimney stack above flat 8.

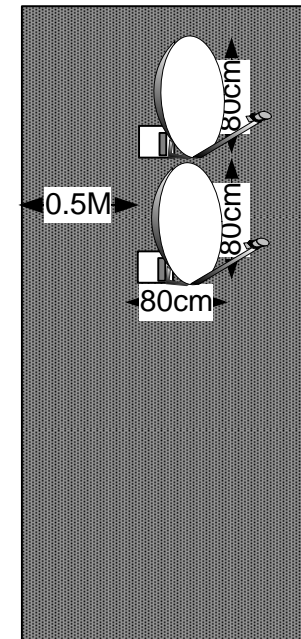

Form No. SCC 013 SCC International – 1 Fieldings Road, Cheshunt, Herts, EN8 9TL, . Tel: 01992 642255. Website: www.scci.co.uk

Drawing No.	E13013/09	Site Address:	1-10 Cranley Buildings, Dorrington Street, Camden, London, EC1N 7SY		
Date:	14 th Oct 11	Site Ref:	LBC0429.0	Surveyed By:	Danny Varleigh
Number of Points:	10	System Type	9Wire IRS Sky Plus	Drawn By:	James Schroder



Please consider the environment before printing this document – Recycle Wherever Possible

