
Client: UCLH Charities	Drawing title: Existing & Proposed Huntley Street Rear Elevations	Date: 11-10-24	Scale: 1:100 @ /	43
Project title:		Project number:	Drawing number:	Revision:
56 Huntley Street		104300	PA - ELEV - 002	-

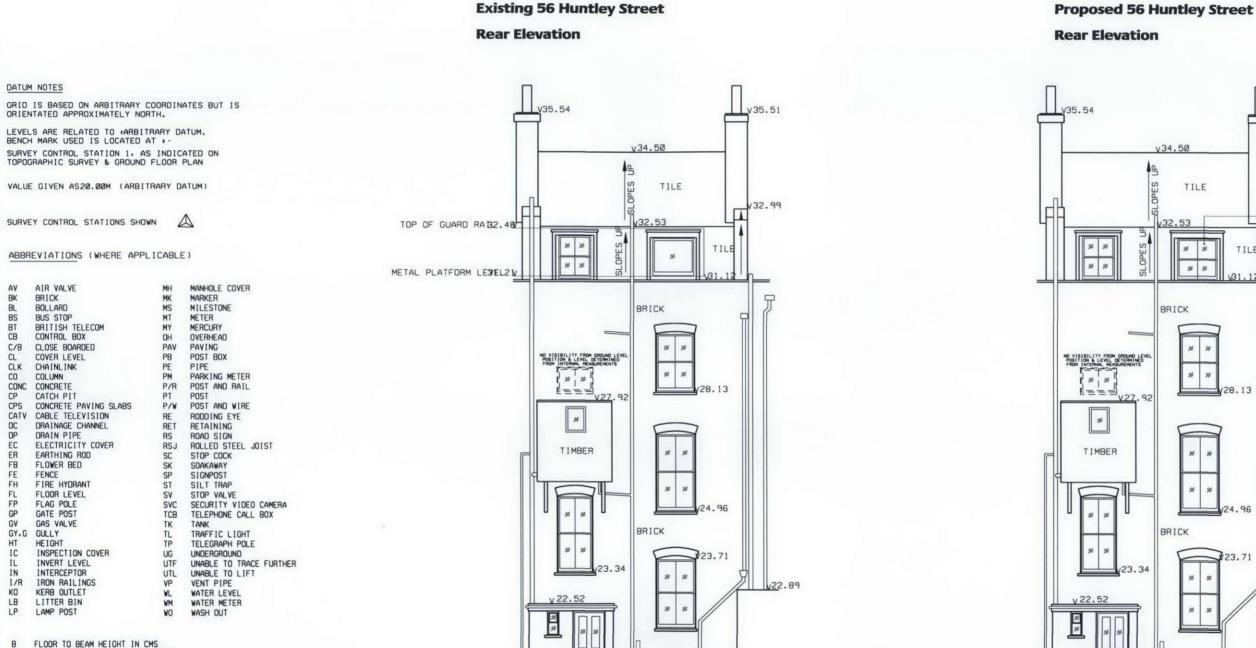

# 0

BASEMENT GROUND LEVEL

/20.11

18.28

BRICK

- FLOOR TO BEAM HEIGHT IN CMS FLOOR TO CEILING HEIGHT IN CMS В
- CR. FLOOR TO CROWN HEIGHT IN CMS
- FLOOR TO DOOR HEAD HEIGHT IN CMS FLOOR TO FALSE CEILING HEIGHT IN CMS D FC
- FF FALSE FLOOR LEVEL

AV BK BL BS BT CB

CATV

DC DP EC ER

FB

FE FH

FL FP GP GV GY.G HT IC IL

IN I/R

KO

LB LP

- FLOOR TO HEAD HEIGHT IN CMS
- SPR. FLOOR TO SPRINGER HEIGHT IN CMS

## NOTES

DRAINAGE PIPE SIZES (WHERE SHOWN) HAVE BEEN GAUGED FROM THE SURFACE FOR SAFETY REASONS AND SHOULD BE REGARDED AS APPROXIMATE ONLY.

TREE SPECIES (WHER SHOWN) SHOULD BE TREATED WITH CAUTION AND EXPERT IDENTIFICATION IS ADVISED. • ALTHOUGH THIS IS A DIGITAL SURVEY THE ACCURACY AND ANOUNT OF DETAIL SHOWN IS ONLY COMMENSURATE WITH THE GRAPHICAL SCALE OF MAPPING AS SPECIFIED, CARE SHOULD BE EXERCISED WHEN WORKING TO LARGER SCALES.

VISIBLE FEATURES IN THE VICINITY OF THE BOUNDARIES AS SHOWN ABOVE, MAY NOT REPRESENT THE EXTENT OF LEGALLY CONVEYED OWNERSHIP.


WHILST EVERY EFFORT HAS BEEN MADE TO ACHIEVE ACCURACY ON THIS PLAN. CRUCIAL CLEARANCE DIMENSIONS, LEVELS AND INVERT LEVELS SHOULD BE CHECKED PRIOR TO DESIGN AND CONSTRUCTION.

• KERB LEVELS HAVE BEEN TAKEN IN THE BOTTOM OF THE CHANNEL. • AREAS OF DEMSE UNDERGROWTH CANNOT BE SURVEYED IN DETAIL. THESE AREAS WILL BE SHOWN IN OUTLINE ONLY AND MARKED AS 'DENSE UNDERGROWTH' ON THE PLAN.

DATUM LINE VALUE: 20.00M

DATUM LINE VALUE: 20.00M



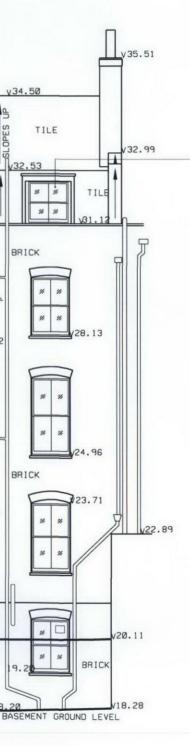

**Existing window to** be replaced and new window frame & glazing added to match existing.