

00. INDEX


Drawing Number	Drawing Title	Description	
E03007/00	Index	Index of Drawings.	
E03007/01	Location Plan	Scale 1:1250 at A4	
E03007/02	Block Plan	Photo of Site from above.	
E03007/03	Roof Plan	Drawing of block from above, showing equipment positions.	
E03007/04	S Elevation	Rear view of the building and descriptions of looms descending per flats	
E03007/05	Equipments Location 1	View of proposed Aerial, dishes and Main Cabinet positions and locations	
E03007/06	Equipments Location 2	View of proposed Remote Cabinet location	
E03007/07	N Elevation	Frontal view of the building and descriptions of looms descending per flats	
E03007/08	Dish Sizes & Typical Mounting Heights	Measurement of Dishes mounting position / height.	
E03007/09	Equipments Description	Description of all equipments to be used on site.	
E03007/10	Equipments Description	Description of all equipments to be used on site.	

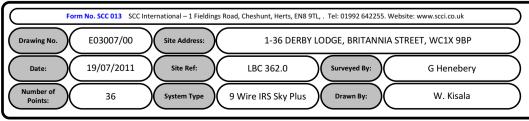



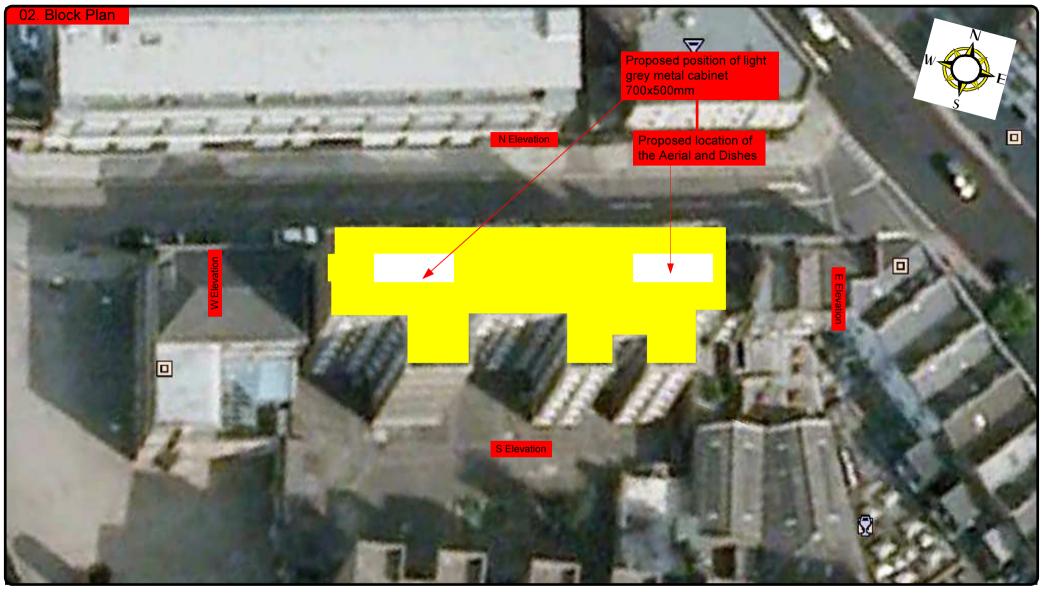



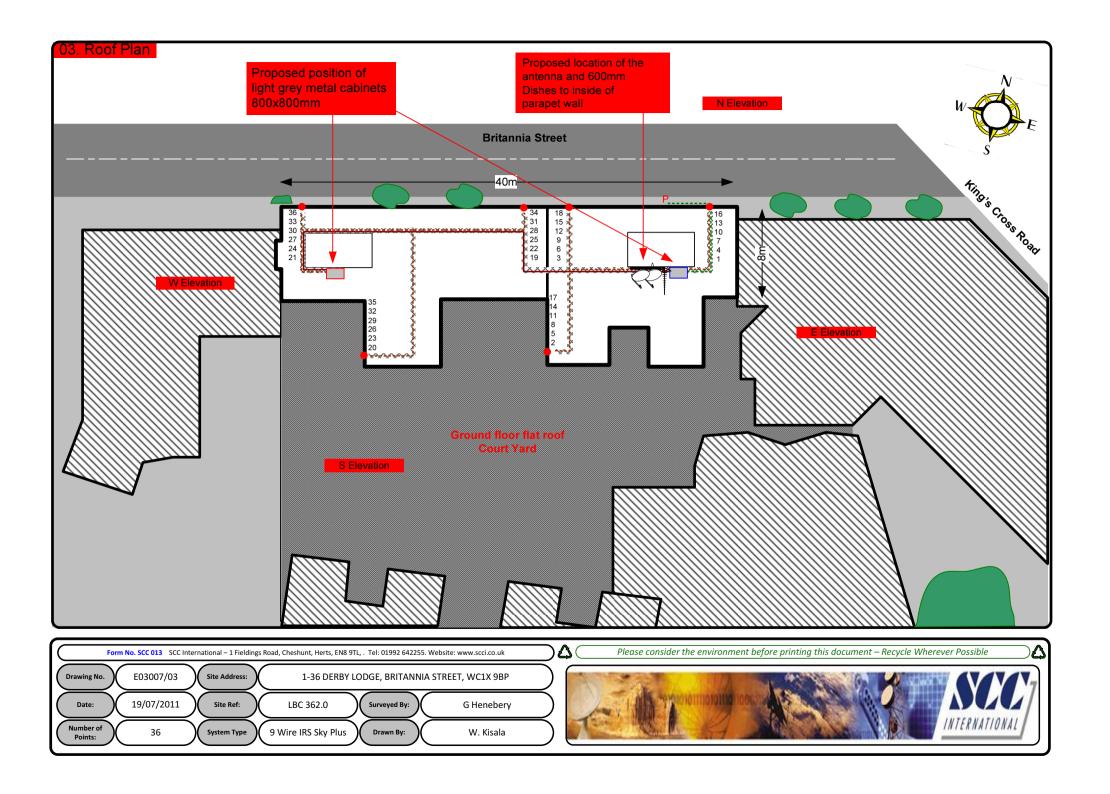

Cable Harness sizes

2-4 cables = 15mm

6-8 cables = 20mm


10-14 cables = 30mm

16-18 Cables = 35mm

20 cables = 40mm


40 cables = 65mm

60 cables = 90mm

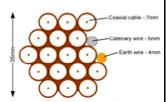

Typical loom for 16 coaxial cable + 1 earth wire, + 1 catenary wire



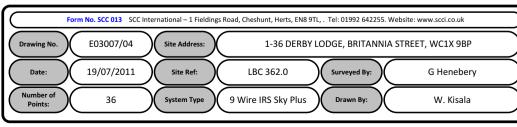



Cable Harness sizes

2-4 cables = 15mm

6-8 cables = 20mm


10-14 cables = 30mm


16-18 Cables = 35mm


20 cables = 40 mm

40 cables = 65mm

60 cables = 90mm

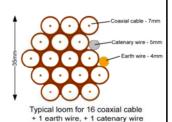

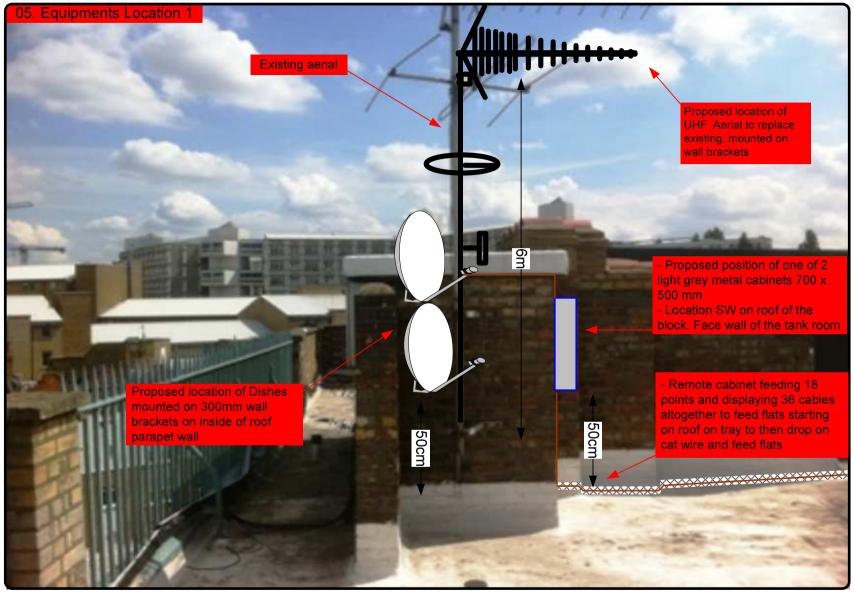

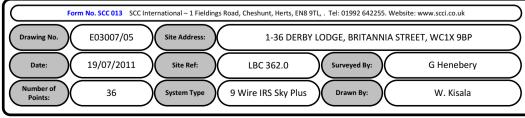



Cable Harness sizes

2-4 cables = 15mm

6-8 cables = 20mm


10-14 cables = 30mm

16-18 Cables = 35mm


20 cables = 40mm


40 cables = 65mm

60 cables = 90mm

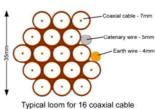

Typical loom for 16 coaxial cable + 1 earth wire, + 1 catenary wire

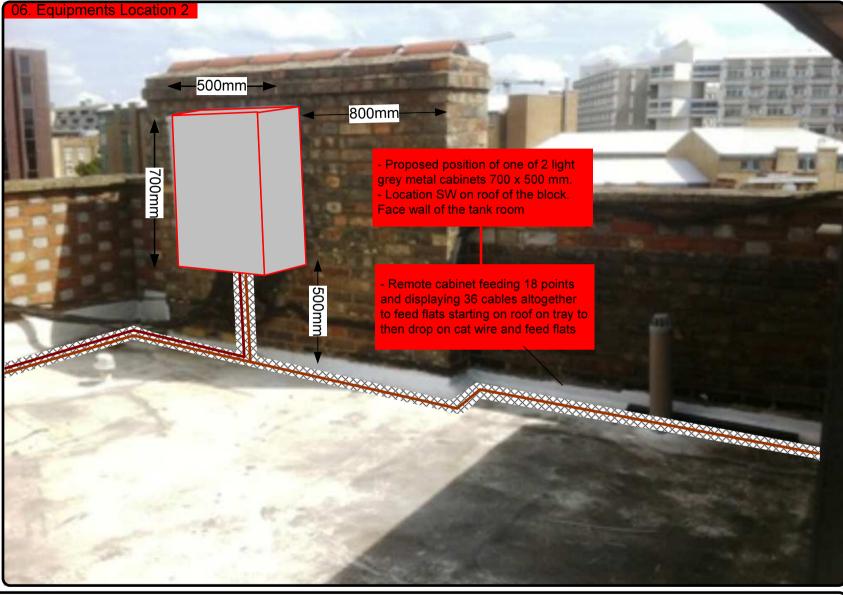

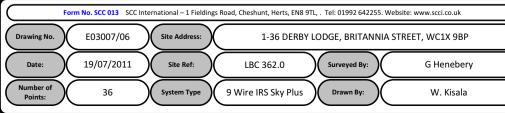



Cable Harness sizes

2-4 cables = 15mm

6-8 cables = 20mm


10-14 cables = 30mm

16-18 Cables = 35mm


20 cables = 40mm

40 cables = 65mm


60 cables = 90mm

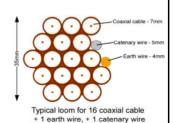



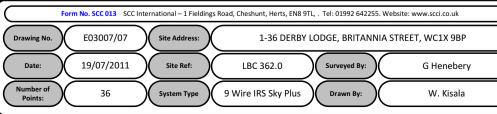



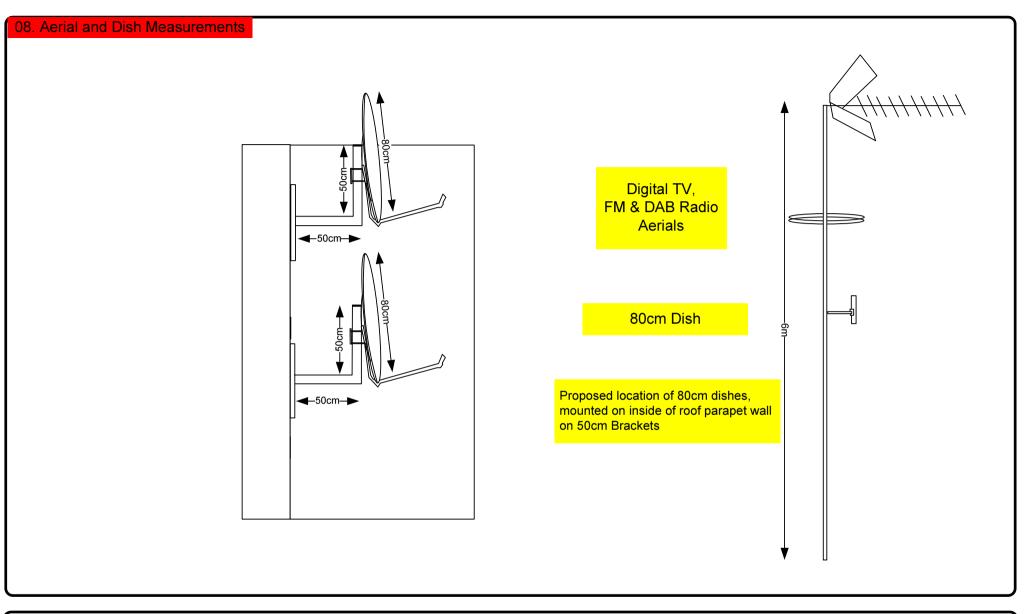



Cable Harness sizes

2-4 cables = 15mm

6-8 cables = 20mm

10-14 cables = 30mm

16-18 Cables = 35mm

20 cables = 40mm

40 cables = 65mm

60 cables = 90mm







Digital aerial








Coaxial cable - 7mm

Catenary wire - 5mm

Earth wire - 4mm

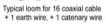







Form No. SCC 013 SCC International – 1 Fieldings Road, Cheshunt, Herts, EN8 9TL, . Tel: 01992 642255. Website: www.scci.co.uk						
Drawing No.	E03007/09	Site Address:	1-32 DERBY LODGE, BRITANNIA STREET, WC1X 9LG			
Date:	19/07/2011	Site Ref:	LBC 362.0 Surveyed By:	G Henebery		
Number of Points:	36	System Type	9 Wire IRS Sky Plus Drawn By:	W. Kisala		

