

00. INDEX

Drawing Number	Drawing Title	Description
B04138-39/00	Index	Index of Drawings.
B04138-39/01	Location Plan	Scale 1:1250 at A4
B04138-39/02	Roof Plan	Drawing of block from above, showing equipment positions.
B04138-39/03	Roof Elevations	Roof view, cable routes and equipments mounting and measurements
B04138-39/04	North Elevation	Elevation view, cable routes, colour, loom sizes at entry point per flat
B04138-39/05	South Elevation 1	Elevation view, cable routes, colour, loom sizes at entry point per flat
B04138-39/06	South Elevation 2	Elevation view, cable routes, colour, loom sizes at entry point per flat
B04138-39/07	Existing Equipment	Location and Description of existing equipments on site before install
B04138-39/08	Antenna, Dish Sizes & Typical Mounting Heights	Measurement of the Antenna and Dishes mounting, position and height.


Form No. SCC 013 SCC International – 1 Fieldings Road, Cheshunt, Herts, EN8 9TL, . Tel: 01992 642255. Website: www.scci.co.uk



Please consider the environment before printing this document – Recycle Wherever Possible



Site Reference:	B04138-39/00	Site Address:	FLATS 65-88 LANGBOURNE MANSIONS, CAMDEN LONDON N6 6PU
Date:	17/11/2011	Client:	LBC0754.0/0755.0
Number of Points:	24	System Type:	9WIRE IRS SKY+
		Surveyed By:	G. Henebery
		Drawn By:	W. Kisala

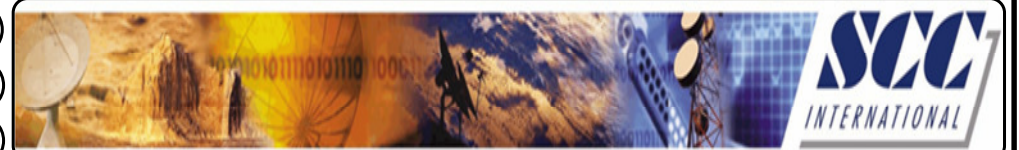

Each property will have two cables to lounge position.

Cable Harness sizes

2-4 cables = 15mm

6-8 cables = 20mm


10-14 cables = 30mm

16-18 Cables = 35mm


20 cables = 40mm

40 cables = 65mm

60 cables = 90mm

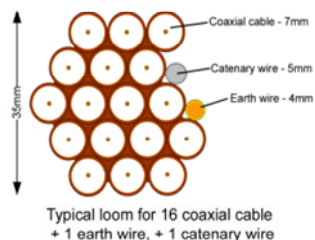

02. Roof Plan

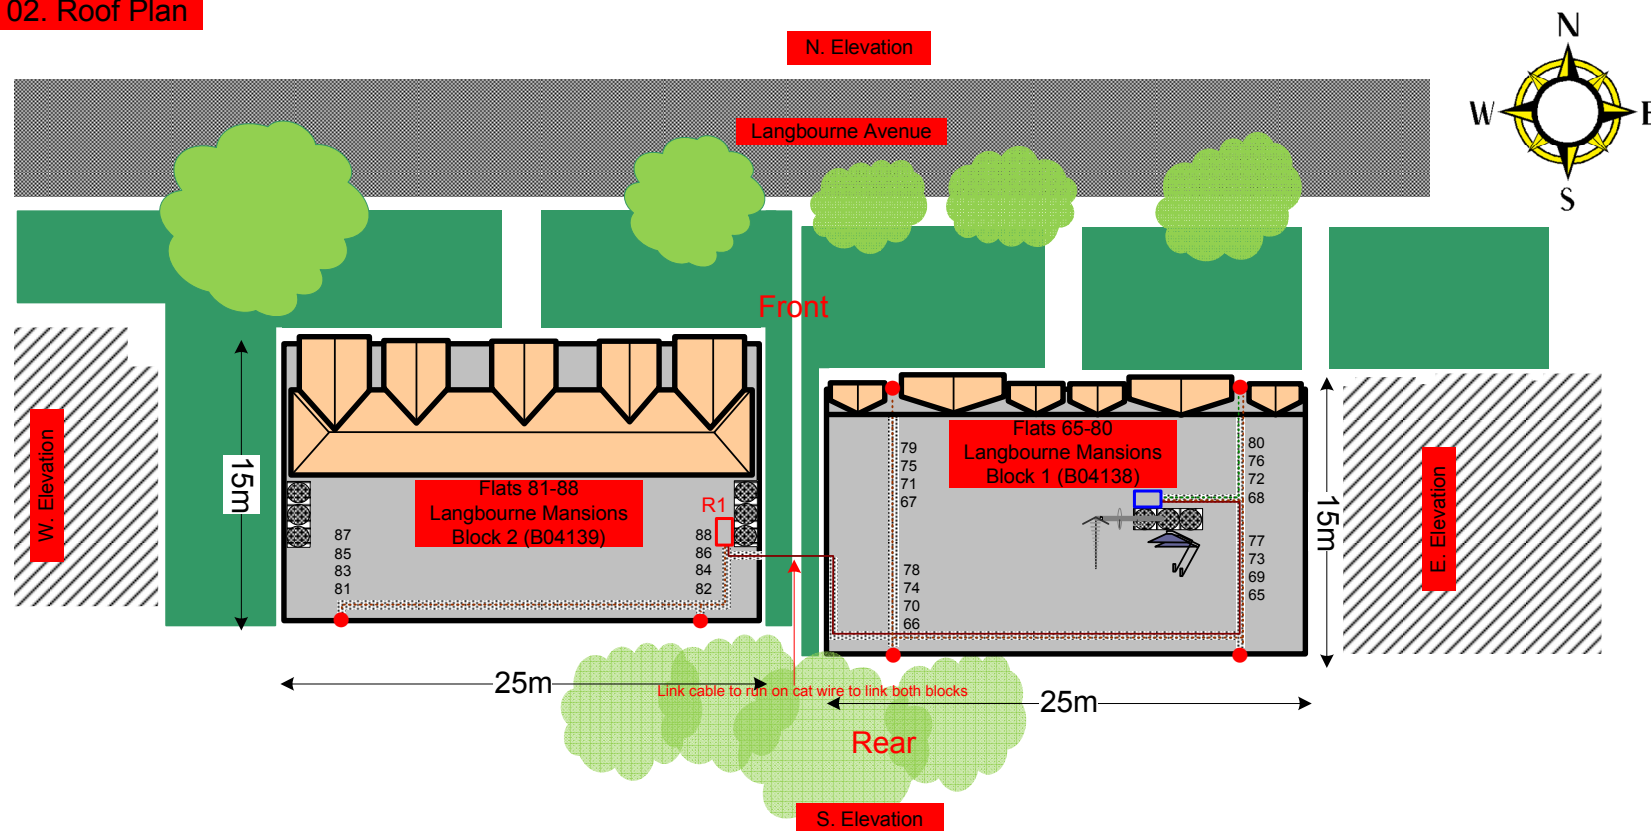

Rig, Dishes and H/E + R1 all located on roof sidewall of the chimney, Power is located in the hallway entrance to flats block 65-80. All cables to run on tray on roof. Link cable to run on cat wire to link the 2 blocks. Drop cables to run over the edge of the block then down to all lounge locations at the front and rear of the block. Note that White cable will be dropped at rear wall of the buildings. Black cables will be dropped at the front face of the buildings


Form No. SCC 013 SCC International – 1 Fieldings Road, Cheshunt, Herts, EN8 9TL, . Tel: 01992 642255. Website: www.scci.co.uk



Please consider the environment before printing this document – Recycle Wherever Possible



Site Reference:	B04138-39/02	Site Address:	FLATS 65-88 LANGBOURNE MANSIONS, CAMDEN LONDON N6 6PU
Date:	17/11/2011	Client:	LBC0754.0/0755.0
Number of Points:	24	System Type:	9WIRE IRS SKY+
		Surveyed By:	G. Henebery
		Drawn By:	W. Kisala

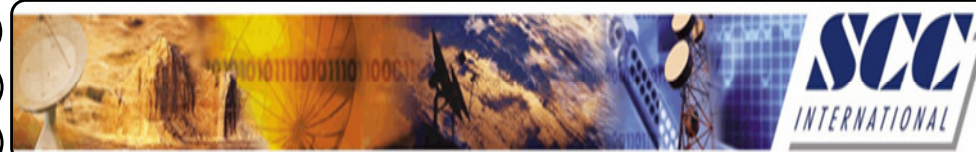

03. Building Elevations 1

Location of 80cm dishes on the sidewall of the Chimney mount on roof of block 65-80 Langbourne Mansions



Flats 65-80
Langbourne Mansions
Block 1 (B04138)

Roof Elevation

Roof Elevation



Flats 81-88
Langbourne Mansions
Block 2 (B04139)

- Cable on tray on roof then to drop white cables only at rear face of the block to feed flats
- Black cables to be dropped at the front face to feed flats.
- Both buildings will be linked with a cat wire to run the system through.

Location of the remote cabinet.
Sized 60x60x20cm on the sidewall of the chimney mount on roof of block 81-88 Langbourne Mansions (other side of the chimney)

Form No. SCC 013 SCC International – 1 Fieldings Road, Cheshunt, Herts, EN8 9TL. . Tel: 01992 642255. Website: www.scci.co.uk					
Site Reference:	B04138-39/03	Site Address:	FLATS 65-88 LANGBOURNE MANSIONS, CAMDEN LONDON N6 6PU		
Date:	17/11/2011	Client:	LBC0754.0/0755.0	Surveyed By:	G. Henebery
Number of Points:	24	System Type	9WIRE IRS SKY+	Drawn By:	W. Kisala

Please consider the environment before printing this document – Recycle Wherever Possible

Each property will have two cables to lounge position.

Cable Harness sizes

2-4 cables = 15mm

6-8 cables = 20mm


10-14 cables = 30mm

16-18 Cables = 35mm

20 cables = 40mm

40 cables = 65mm

60 cables = 90mm

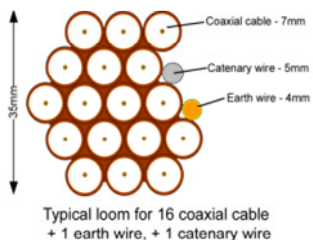

04. North Elevation

Flats 65-80
Langbourne
Mansions
Block 1 (B04138)



Black cables to drop at the front face of the block then clipped to the wall to then feed flats with 2 cables each at entry point

Form No. SCC 013 SCC International – 1 Fieldings Road, Cheshunt, Herts, EN8 9TL, . Tel: 01992 642255. Website: www.scci.co.uk



Please consider the environment before printing this document – Recycle Wherever Possible



Site Reference:	B04138-39/04	Site Address:	FLATS 65-88 LANGBOURNE MANSIONS, CAMDEN LONDON N6 6PU		
Date:	17/11/2011	Client:	LBC0754.0/0755.0	Surveyed By:	G. Henebery
Number of Points:	24	System Type:	9WIRE IRS SKY+	Drawn By:	W. Kisala



Each property will have two cables to lounge position.

Cable Harness sizes

2-4 cables = 15mm

6-8 cables = 20mm


10-14 cables = 30mm

16-18 Cables = 35mm

20 cables = 40mm

40 cables = 65mm

60 cables = 90mm

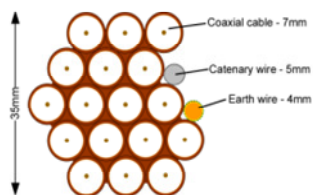

Typical loom for 16 coaxial cable
+ 1 earth wire, + 1 catenary wire

05. South Elevation 1

Flats 81-88
Langbourne Mansions
Block 2 (B04139)



White cables to drop at rear face of the block
then clipped to the wall to then feed flats with 2
cables each at entry point

Form No. SCC 013 SCC International – 1 Fieldings Road, Cheshunt, Herts, EN8 9TL, . Tel: 01992 642255. Website: www.scci.co.uk



Please consider the environment before printing this document – Recycle Wherever Possible



Site Reference:	B04138-39/05	Site Address:	FLATS 65-88 LANGBOURNE MANSIONS, CAMDEN LONDON N6 6PU
Date:	17/11/2011	Client:	LBC0754.0/0755.0
Number of Points:	24	System Type	9WIRE IRS SKY+
		Surveyed By:	G. Henebery
		Drawn By:	W. Kisala



Each property will have two cables to lounge position.

Cable Harness sizes

2-4 cables = 15mm

6-8 cables = 20mm


10-14 cables = 30mm

16-18 Cables = 35mm

20 cables = 40mm

40 cables = 65mm

60 cables = 90mm

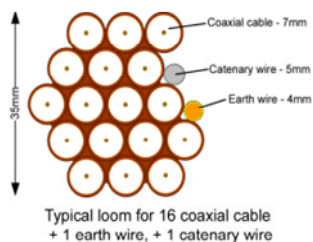

06. South Elevation 2

Flats 65-80
Langbourne
Mansions
Block 1 (B04138)



White cables to drop at rear face of the block then clipped to the wall to then feed flats with 2 cables each at entry point

Form No. SCC 013 SCC International – 1 Fieldings Road, Cheshunt, Herts, EN8 9TL, . Tel: 01992 642255. Website: www.scci.co.uk



Please consider the environment before printing this document – Recycle Wherever Possible



Site Reference:	B04138-39/06	Site Address:	FLATS 65-88 LANGBOURNE MANSIONS, CAMDEN LONDON N6 6PU
Date:	17/11/2011	Client:	LBC0754.0/0755.0
Number of Points:	24	System Type	9WIRE IRS SKY+
		Surveyed By:	G. Henebery
		Drawn By:	W. Kisala



Each property will have two cables to lounge position.

Cable Harness sizes

2-4 cables = 15mm

6-8 cables = 20mm


10-14 cables = 30mm

16-18 Cables = 35mm

20 cables = 40mm

40 cables = 65mm

60 cables = 90mm

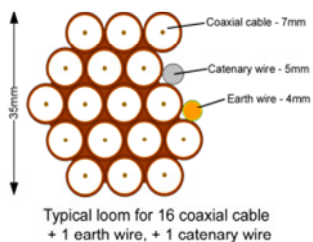

07. Existing Equipments



South Elevation



Roof Elevation

Form No. SCC 013 SCC International – 1 Fieldings Road, Cheshunt, Herts, EN8 9TL, . Tel: 01992 642255. Website: www.scci.co.uk



Please consider the environment before printing this document – Recycle Wherever Possible



Site Reference:	B04138-39/07	Site Address:	FLATS 65-88 LANGBOURNE MANSIONS, CAMDEN LONDON N6 6PU
Date:	17/11/2011	Client:	LBC0754.0/0755.0
Number of Points:	24	System Type:	9WIRE IRS SKY+
		Surveyed By:	G. Henebery
		Drawn By:	W. Kisala



Each property will have two cables to lounge position.

Cable Harness sizes

2-4 cables = 15mm

6-8 cables = 20mm


10-14 cables = 30mm

16-18 Cables = 35mm

20 cables = 40mm

40 cables = 65mm

60 cables = 90mm

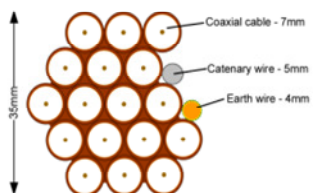


Typical loom for 16 coaxial cable
+ 1 earth wire, + 1 catenary wire

08. Antenna and Dishes Measurements

Proposed location of UHF Aerial on a 4m pole mounted using wall bracket and 80cm dishes mounted using lashing kits. all installed on the sidewall of the chimney on roof

Digital TV,
FM & DAB Radio
Aerials

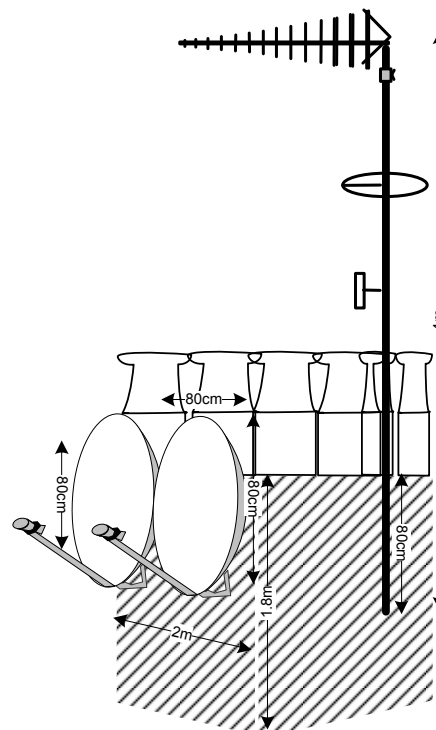

Form No. SCC 013 SCC International – 1 Fieldings Road, Cheshunt, Herts, EN8 9TL, . Tel: 01992 642255. Website: www.scci.co.uk

Site Reference:	B04138-39/08	Site Address:	FLATS 65-88 LANGBOURNE MANSIONS, CAMDEN LONDON N6 6PU
Date:	17/11/2011	Client:	LBC0754.0/0755.0
Number of Points:	24	System Type:	9WIRE IRS SKY+
		Surveyed By:	G. Henebery
		Drawn By:	W. Kisala

Please consider the environment before printing this document – Recycle Wherever Possible

