

Drawing Number	Drawing Title	Description
B04138-39/00	Index	Index of Drawings.
B04138-39/01	Location Plan	Scale 1:1250 at A4
B04138-39/02	Roof Plan	Drawing of block from above, showing equipment positions.
B04138-39/03	Roof Elevations	Roof view, cable routes and equipments mounting and measurements
B04138-39/04	North Elevation	Elevation view, cable routes, colour, loom sizes at entry point per flat
B04138-39/05	South Elevation 1	Elevation view, cable routes, colour, loom sizes at entry point per flat
B04138-39/06	South Elevation 2	Elevation view, cable routes, colour, loom sizes at entry point per flat
B04138-39/07	Existing Equipment	Location and Description of existing equipments on site before install
B04138-39/08	Antenna, Dish Sizes & Typical Mounting Heights	Measurement of the Antenna and Dishes mounting, position and height.

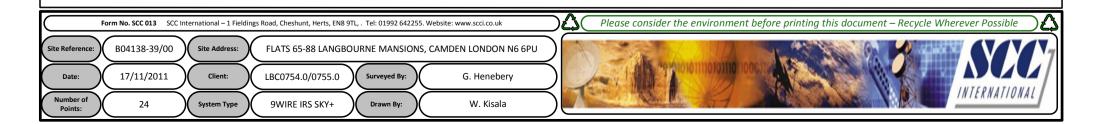

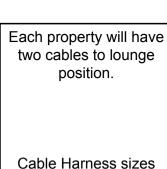

2-4 cables = 15mm

6-8 cables = 20mm


10-14 cables = 30mm

16-18 Cables = 35mm


20 cables = 40mm

40 cables = 65mm

60 cables = 90 mm

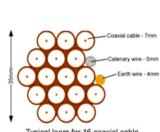

Typical loom for 16 coaxial cable + 1 earth wire, + 1 catenary wire

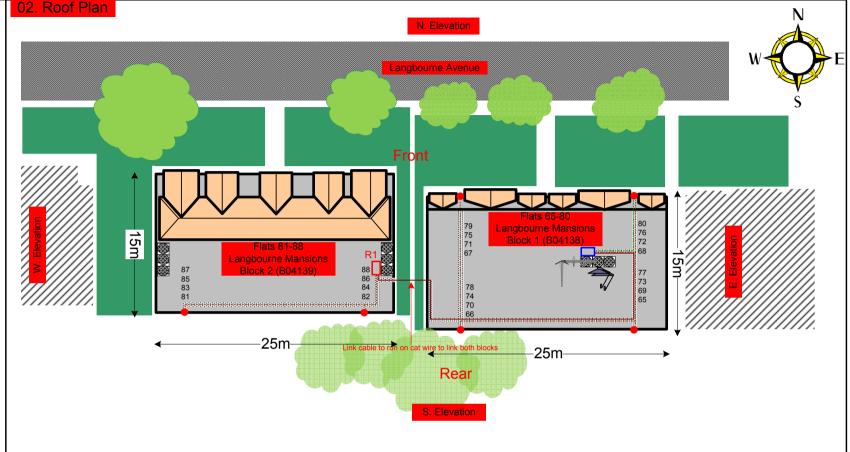

Rig. Dishes and H/E + R1 all located on roof sidewall of the chimney. Power is located in the hallway entrance to flats block 65-80. All cables to run on tray on roof. Link cable to run on cat wire to link the 2 blocks. Drop cables to run over the edge of the block then down to all lounge locations at the front and rear of the block. Note that White cable will be dropped at rear wall of the buildings. Black cables will be dropped at the front face of the buildings



03. Building Elevations 1

Location of 80cm dishes on the sidewall of the Chimney mount on roof of block 65-80 Langbourne Mansions





-Cable on tray on roof then to drop white cables only at rear face of the block to feed flats

-Black cables to be dropped at the front face to feed flats.

-Both buildings will be linked with a cat wire to run the system through.

Location of the remote cabinet. Sized 60x60x20cm on the sidewall of the chimney mount on roof of block 81-88 Langbourne Mansions (other side of the chimney)

Form No. SCC 013 SCC International – 1 Fieldings Road, Cheshunt, Herts, EN8 9TL, . Tel: 01992 642255. Website: www.scci.co.uk B04138-39/03 Site Address: FLATS 65-88 LANGBOURNE MANSIONS, CAMDEN LONDON N6 6PU 17/11/2011 Date: Client: LBC0754.0/0755.0 Surveyed By: G. Henebery umber of 9WIRE IRS SKY+ 24 W. Kisala System Type Drawn By:



Cable Harness sizes

2-4 cables = 15mm

6-8 cables = 20mm


10-14 cables = 30mm


16-18 Cables = 35mm

20 cables = 40mm


40 cables = 65mm

60 cables = 90mm

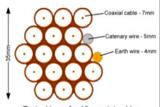

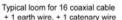



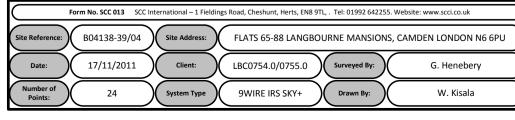



Cable Harness sizes

2-4 cables = 15mm

6-8 cables = 20mm


10-14 cables = 30mm

16-18 Cables = 35mm

20 cables = 40mm


40 cables = 65mm

60 cables = 90mm

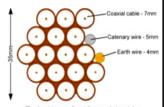

Typical loom for 16 coaxial cable + 1 earth wire, + 1 catenary wire



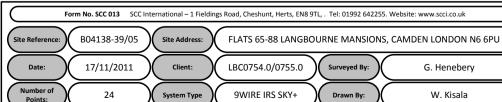



Cable Harness sizes

2-4 cables = 15mm

6-8 cables = 20mm


10-14 cables = 30mm

16-18 Cables = 35mm

20 cables = 40mm

40 cables = 65mm

60 cables = 90mm

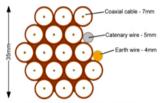

Typical loom for 16 coaxial cable + 1 earth wire, + 1 catenary wire

06. South Elevation 2

Flats 65-80 Langbourne Mansions Block 1 (B04138)



Form No. SCC 013 SCC International – 1 Fieldings Road, Cheshunt, Herts, EN8 9TL, . Tel: 01992 642255. Website: www.scci.co.uk B04138-39/06 Site Address: FLATS 65-88 LANGBOURNE MANSIONS, CAMDEN LONDON N6 6PU Site Reference: 17/11/2011 LBC0754.0/0755.0 G. Henebery

Number of

9WIRE IRS SKY+

W. Kisala

Please consider the environment before printing this document – Recycle Wherever Possible



cables each at entry point

Cable Harness sizes

2-4 cables = 15mm

6-8 cables = 20mm


10-14 cables = 30mm

16-18 Cables = 35mm

20 cables = 40mm

40 cables = 65mm


60 cables = 90mm

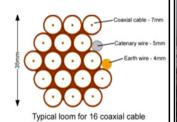







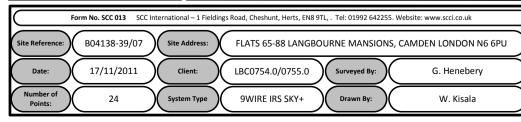



Cable Harness sizes

2-4 cables = 15mm

6-8 cables = 20mm


10-14 cables = 30mm

16-18 Cables = 35mm

20 cables = 40mm

40 cables = 65mm

60 cables = 90mm

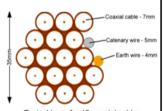

Typical loom for 16 coaxial cable + 1 earth wire, + 1 catenary wire

08. Antenna and Dishes Measurements

Proposed location of UHF Aerial on a 4m pole mounted using wall bracket and 80cm dishes mounted using lashing kits. all installed on the sidewall of the chimny on roof

Digital TV, FM & DAB Radio Aerials

