

00. INDEX

Drawing Number	Drawing Title	Description
E04019/00	Index	Index of Drawings.
E04019/01	Location Plan	Scale 1:1250 at A4.
E04019/02	Roof Plan	Drawing of block from above, showing equipment positions.
E04019/03	Roof Elevation	Description and location of the antenna and dishes + mounting and measurements.
E04019/04	South Elevation 1	Description of Cable routes, loom sizes and entry points.
E04019/05	South Elevation 2	Description of Cable routes, loom sizes and entry points.
E04019/06	South Elevation 3	Description of Cable routes, loom sizes and entry points.
E04019/07	Existing Equipments	Description, location and view of the existing equipment on site before install.
E04019/08	Antenna, Dish Sizes & Typical Mounting Heights	Sketch of the Antenna and Dishes + mounting, position and height.

Form No. SCC 013 SCC International – 1 Fieldings Road, Cheshunt, Herts, EN8 9TL, . Tel: 01992 642255. Website: www.scci.co.uk



Please consider the environment before printing this document – Recycle Wherever Possible




Drawing No.	E04019/00	Site Address:	1-36 Langbourne Mansions , London, N6 6PR		
Date:	18 th Nov 11	Site Ref:	LBC 0748.0	Surveyed By:	Paul Kenney
Number of Points:	36	System Type	9Wire IRS Sky Plus	Drawn By:	James Schroder



02. Roof Plan

-Loom work from H/E to run on the roof then down the block to the lounge locations. Black PVC cables to exit the H/E and run above ground floor. To feed flats at front wall of the building.
-2 cables per flat at entry points.

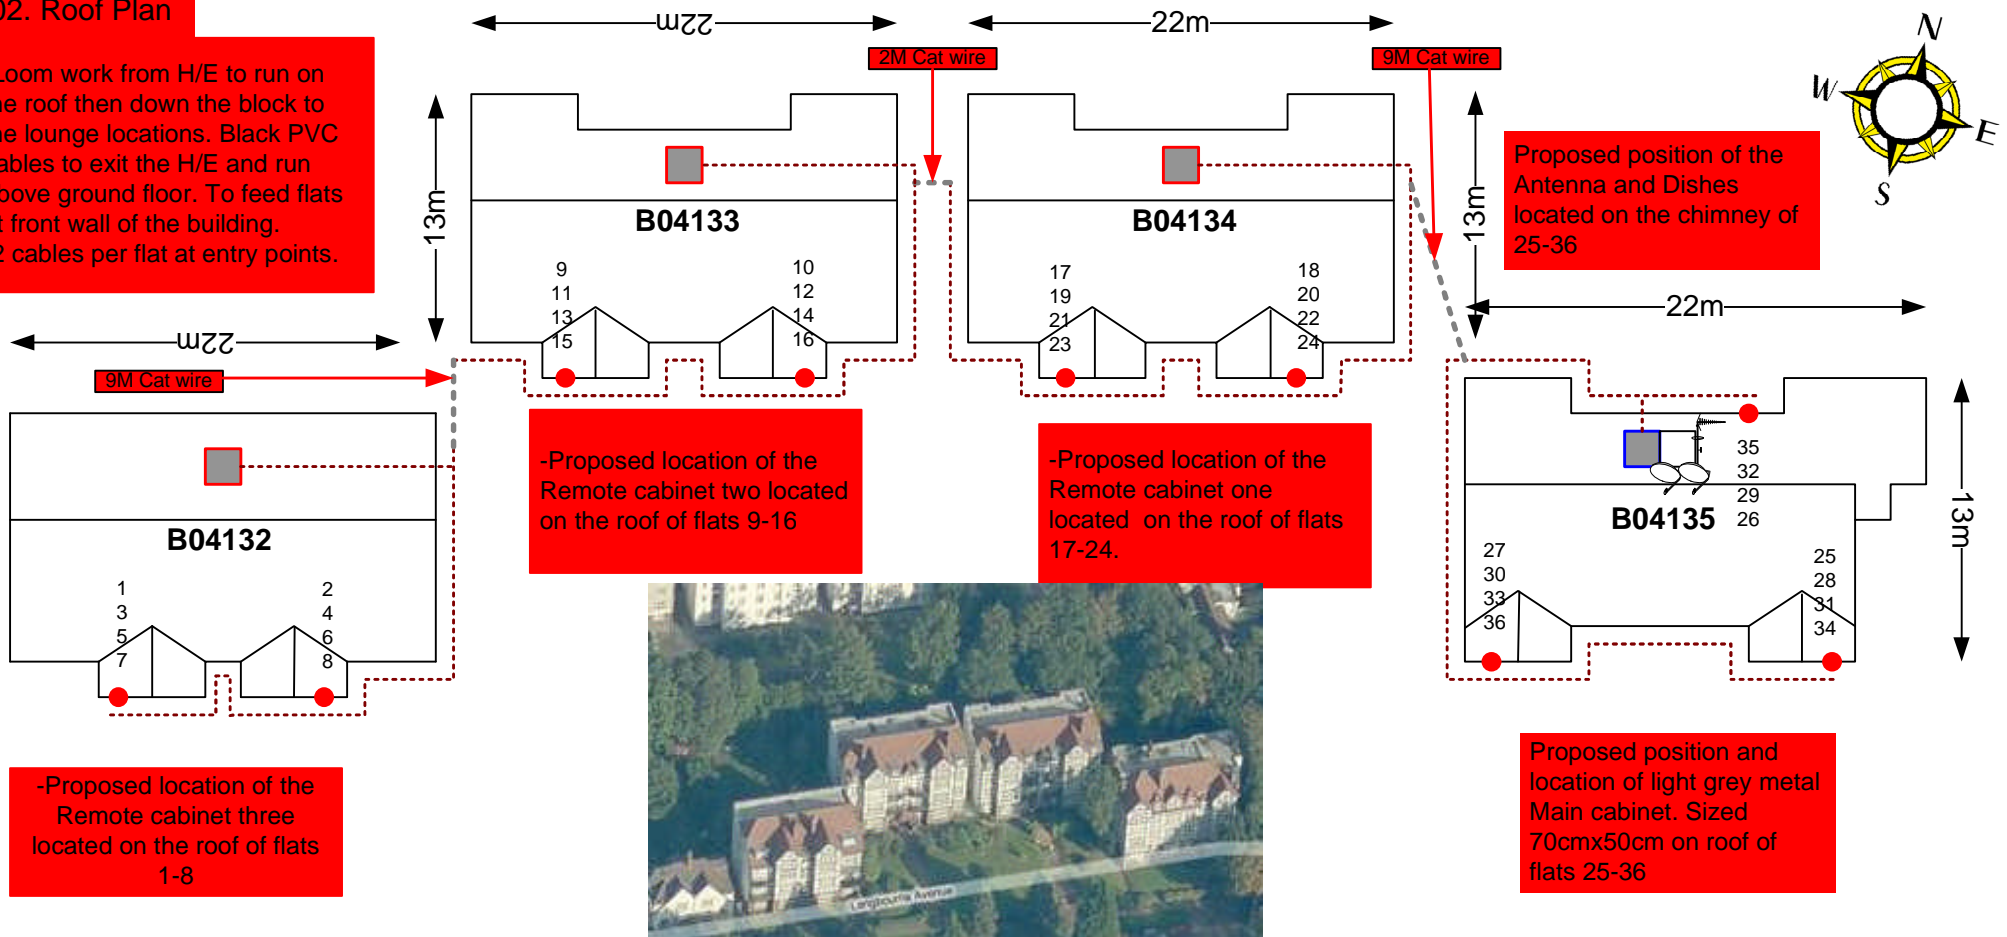

Langbourne Avenue

Form No. SCC 013 SCC International – 1 Fieldings Road, Cheshunt, Herts, EN8 9TL. Tel: 01992 642255. Website: www.scci.co.uk



Please consider the environment before printing this document – Recycle Wherever Possible



Drawing No.	E04019/02	Site Address:	1-36 Langbourne Mansions, London, N6 6PR
Date:	18 th Nov 11	Site Ref:	LBC 0748.0
Number of Points:	36	System Type	9Wire IRS Sky Plus
		Surveyed By:	Paul Kenney
		Drawn By:	James Schroder



Each property will have two cables to lounge position.

Cable Harness sizes

2-4 cables = 15mm

6-8 cables = 20mm


10-14 cables = 30mm

16-18 Cables = 35mm


20 cables = 40mm

40 cables = 65mm

60 cables = 90mm

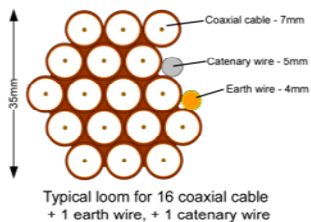

03. Roof Elevation.

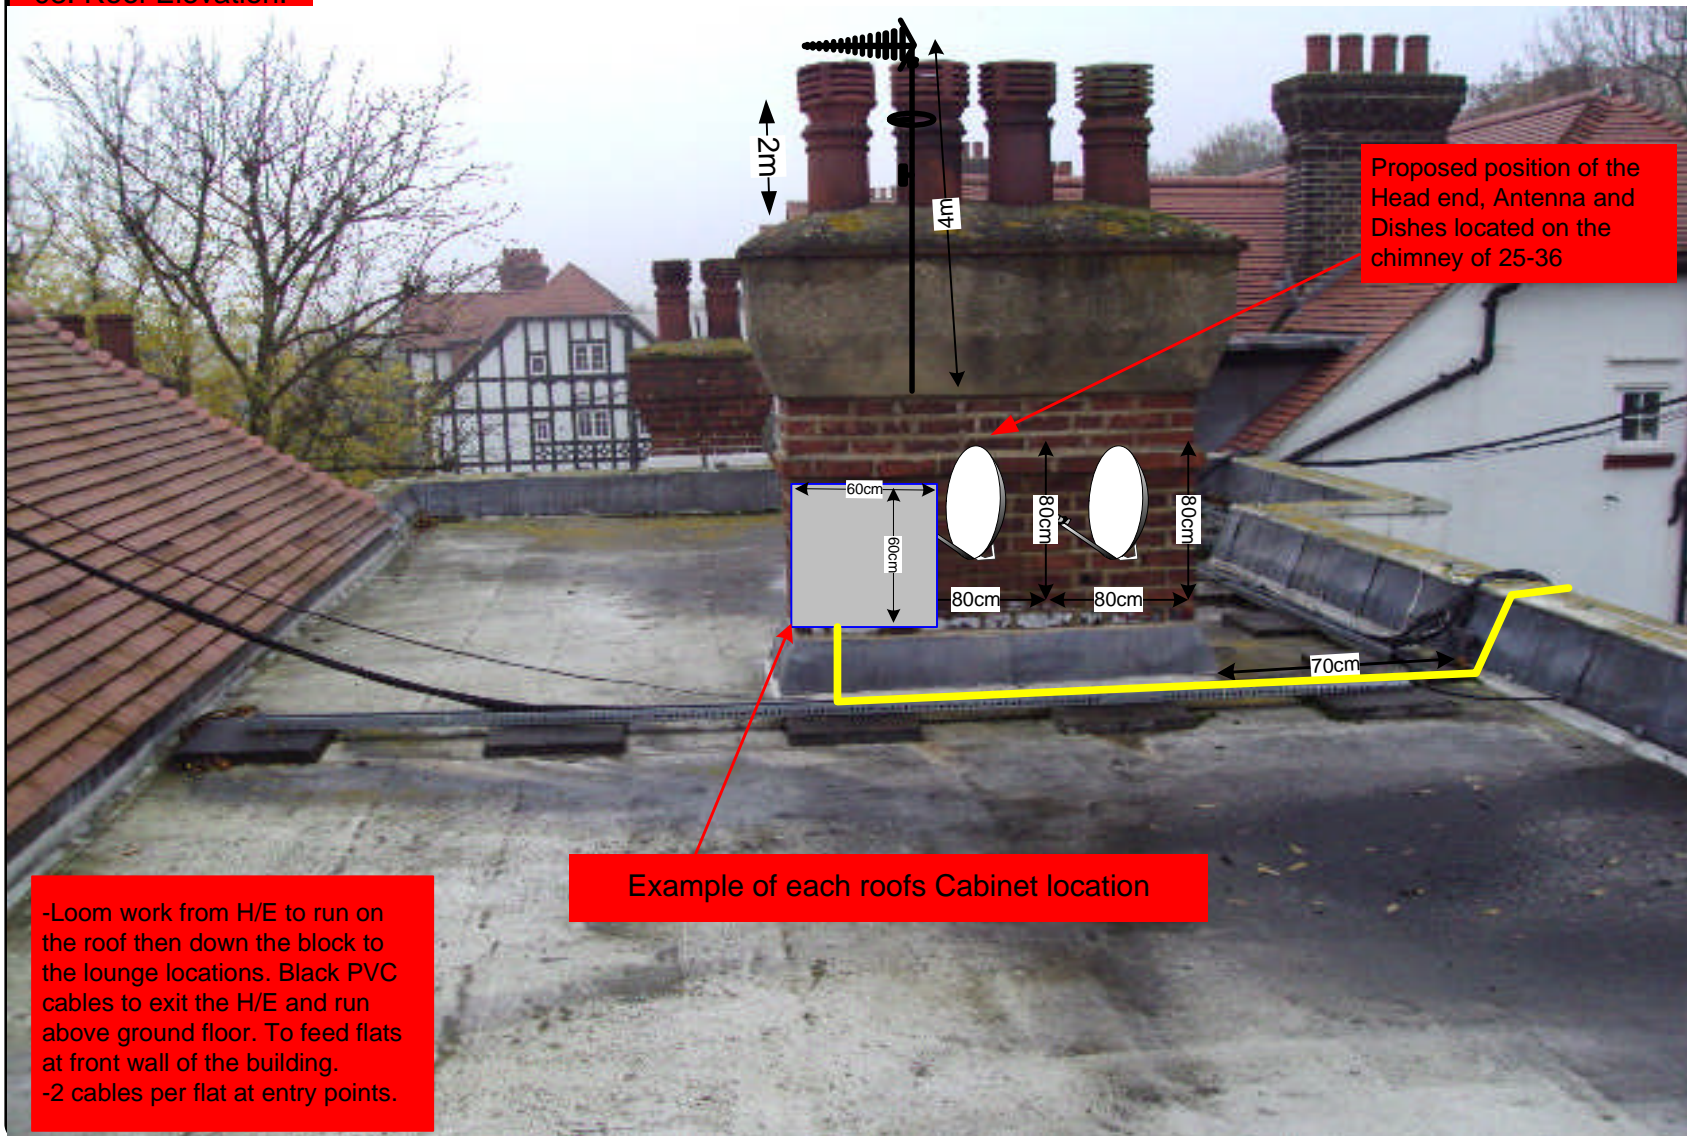

Form No. SCC 013 SCC International – 1 Fieldings Road, Cheshunt, Herts, EN8 9TL, . Tel: 01992 642255. Website: www.scci.co.uk

Drawing No.	E04019/03	Site Address:	1-36 Langbourne Mansions , London, N6 6PR
Date:	18 th Nov 11	Site Ref:	LBC 0748.0
Number of Points:	36	System Type	9Wire IRS Sky Plus
		Surveyed By:	Paul Kenney
		Drawn By:	James Schroder



Please consider the environment before printing this document – Recycle Wherever Possible



Each property will have two cables to lounge position.

Cable Harness sizes

2-4 cables = 15mm

6-8 cables = 20mm


10-14 cables = 30mm

16-18 Cables = 35mm

20 cables = 40mm

40 cables = 65mm

60 cables = 90mm

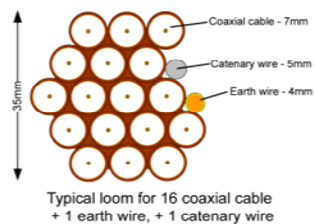

04. South Elevation 1



Form No. SCC 013 SCC International – 1 Fieldings Road, Cheshunt, Herts, EN8 9TL, . Tel: 01992 642255. Website: www.scci.co.uk



Please consider the environment before printing this document – Recycle Wherever Possible



Drawing No.	E04019/04	Site Address:	1-36 Langbourne Mansions , London, N6 6PR
Date:	18 th Nov 11	Site Ref:	LBC 0748.0
Number of Points:	36	System Type	9Wire IRS Sky Plus
		Surveyed By:	Paul Kenney
		Drawn By:	James Schroder



Each property will have two cables to lounge position.

Cable Harness sizes

2-4 cables = 15mm

6-8 cables = 20mm


10-14 cables = 30mm

16-18 Cables = 35mm

20 cables = 40mm

40 cables = 65mm

60 cables = 90mm

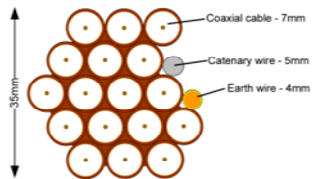

Typical loom for 16 coaxial cable
+ 1 earth wire, + 1 catenary wire

05. South Elevation 2



Form No. SCC 013 SCC International – 1 Fieldings Road, Cheshunt, Herts, EN8 9TL. . Tel: 01992 642255. Website: www.scci.co.uk

Drawing No.	E04019/05	Site Address:	1-36 Langbourne Mansions , London, N6 6PR	
Date:	18 th Nov 11	Site Ref:	LBC 0748.0	Surveyed By: Paul Kenney
Number of Points:	36	System Type	9Wire IRS Sky Plus	Drawn By: James Schroder



Please consider the environment before printing this document – Recycle Wherever Possible



Each property will have
two cables to lounge
position.

Cable Harness sizes

2-4 cables = 15mm

6-8 cables = 20mm


10-14 cables = 30mm

16-18 Cables = 35mm

20 cables = 40mm


40 cables = 65mm

60 cables = 90mm

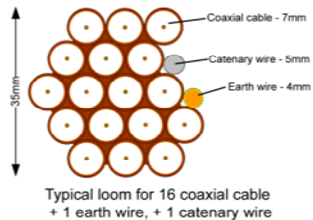

06. South Elevation 3

- Loom work from H/E cabinet and remote cabinet to run above ground floor level in black PVC cables to lounge locations. To feed flats at front wall of the building.
- 2 cables per flat at entry points.

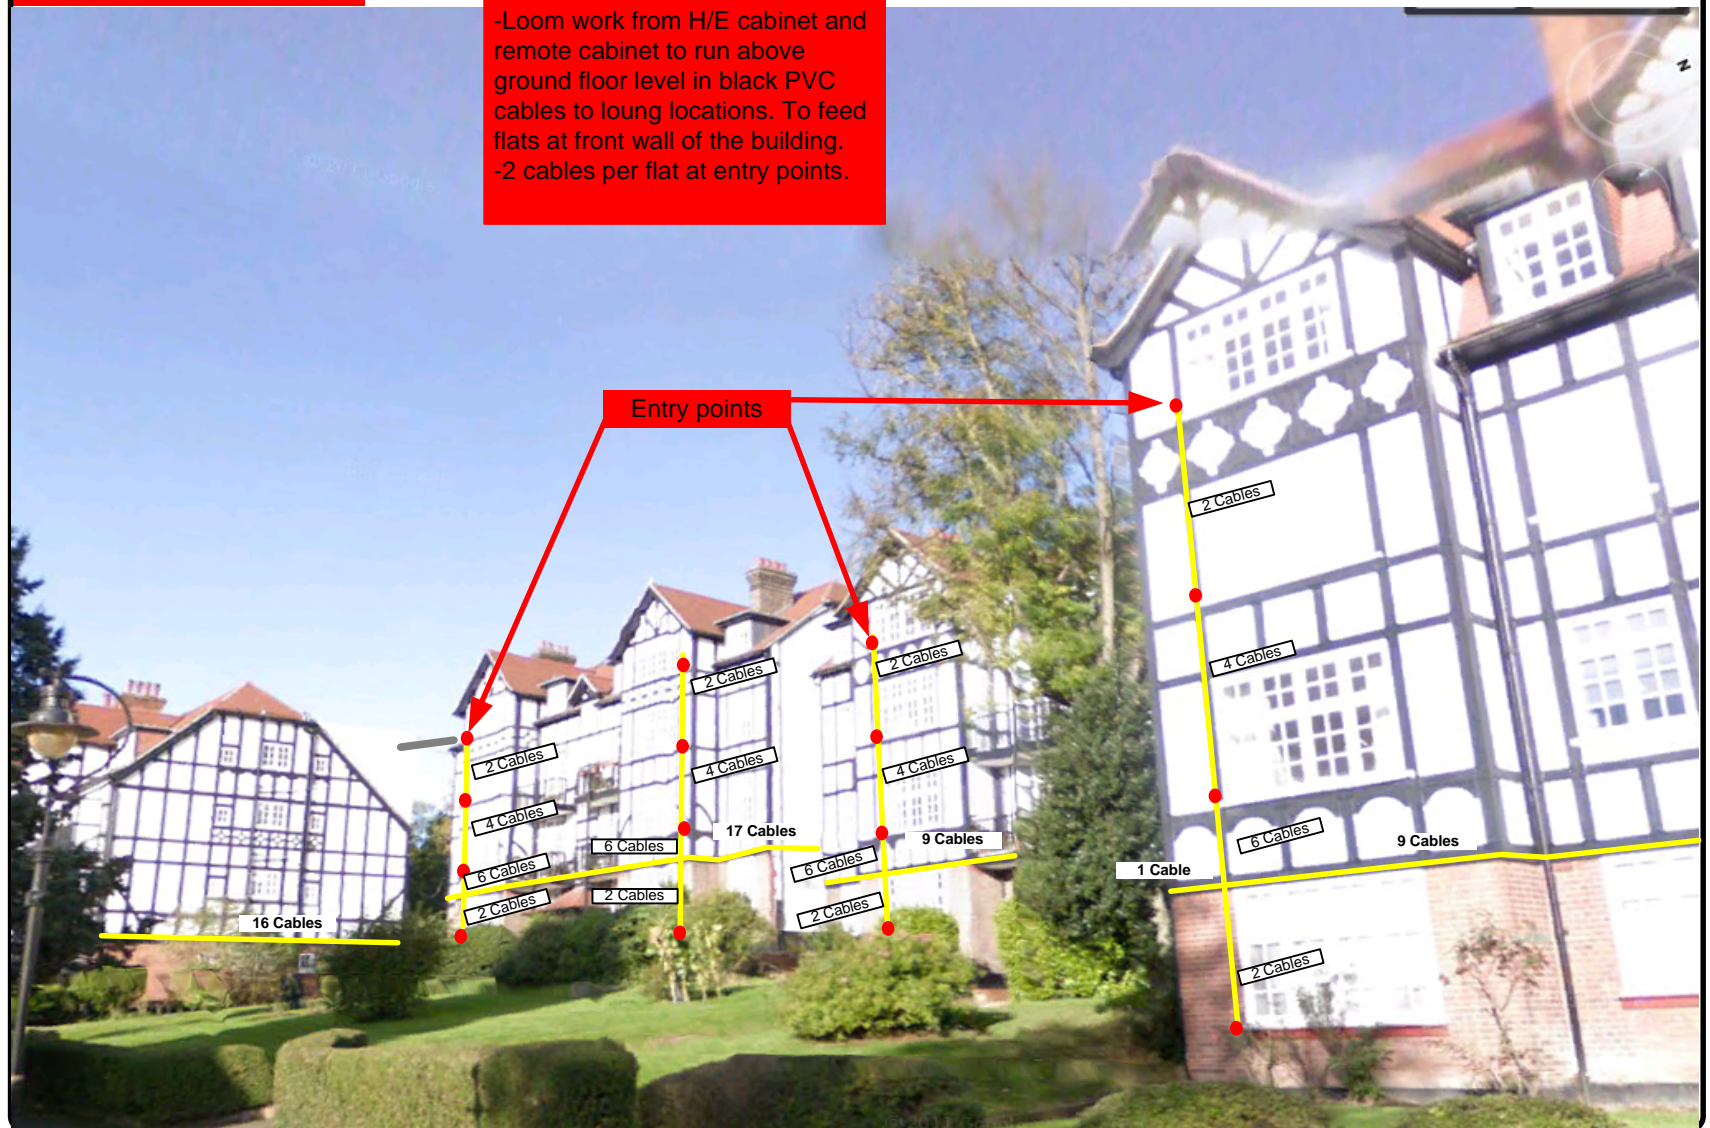

Each property will have two cables to lounge position.

Cable Harness sizes

2-4 cables = 15mm

6-8 cables = 20mm


10-14 cables = 30mm

16-18 Cables = 35mm

20 cables = 40mm

40 cables = 65mm

60 cables = 90mm

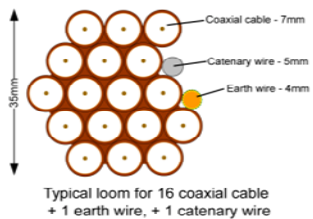

07. Existing Equipments

Roof Elevation



South Elevation



Form No. SCC 013 SCC International – 1 Fieldings Road, Cheshunt, Herts, EN8 9TL . Tel: 01992 642255. Website: www.scci.co.uk

Drawing No.	E04019/07	Site Address:	1-36 Langbourne Mansions , London, N6 6PR	
Date:	18 th Nov 11	Site Ref:	LBC 0748.0	Surveyed By: Paul Kenney
Number of Points:	36	System Type	9Wire IRS Sky Plus	Drawn By: James Schroder




Please consider the environment before printing this document – Recycle Wherever Possible



08. Antenna and Dishes Measurements

Digital TV,
FM & DAB Radio
Aerials

Proposed location of UHF Aerial on a 4m
pole and 80cm dishes mounted on roof
on the chimney stack

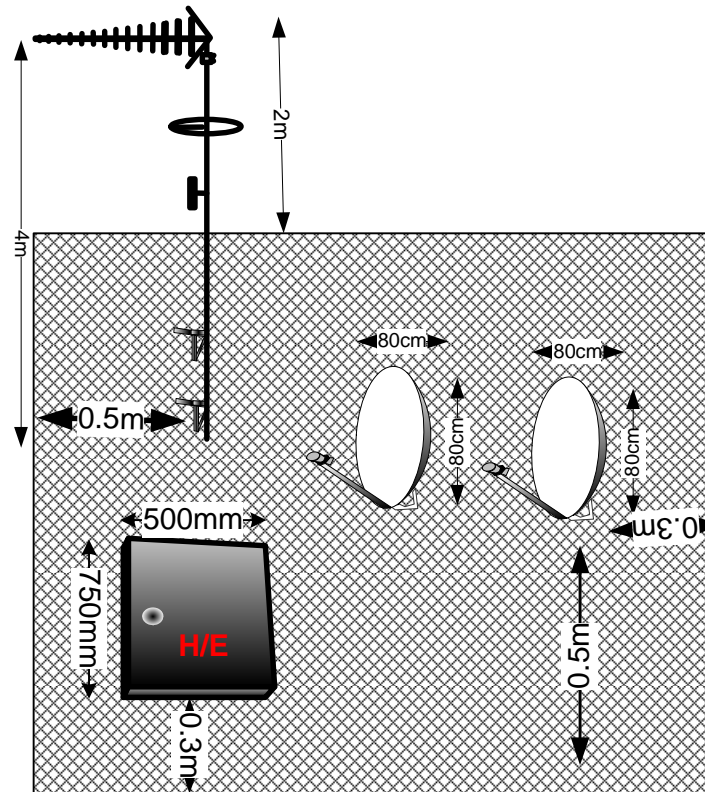

Form No. SCC 013 SCC International – 1 Fieldings Road, Cheshunt, Herts, EN8 9TL, . Tel: 01992 642255. Website: www.scci.co.uk

Drawing No.	E04019/08	Site Address:	1-36 Langbourne Mansions , London, N6 6PR	
Date:	18 th Nov 11	Site Ref:	LBC 0748.0	Surveyed By: Paul Kenney
Number of Points:	36	System Type	9Wire IRS Sky Plus	Drawn By: James Schroder



Please consider the environment before printing this document – Recycle Wherever Possible

