

## 00. INDEX

Drawing Number	Drawing Title	Description
E014025/00	Index	Index of Drawings.
E014025/01	Location Plan	Scale 1:1250 at A4
E014025/02	Block Plan	Photo of Site from above.
E014025/03	Roof Plan	Drawing of block from above, showing equipment positions.
E014025/04	S Elevation	Description of Black drop cables at the front face of the building + loom sizes
E014025/05	N Elevation	Description of White drop cables at the rear face of the building + loom sizes
E014025/06	Equipments Elevation	Rear View description of drop Cables and looms per flats
E014025/07	Main Cabinet Location	Location and description of the Main cabinet on roof + size and position
E014025/07	Tray Work Route	Description of cables running on tray on roof
E014025/07	Antenna, Dish Sizes & Typical Mounting Heights	Measurement of Dishes mounting position / height.




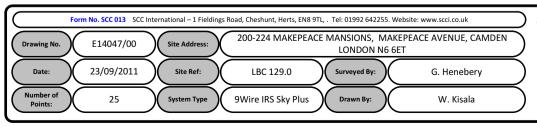

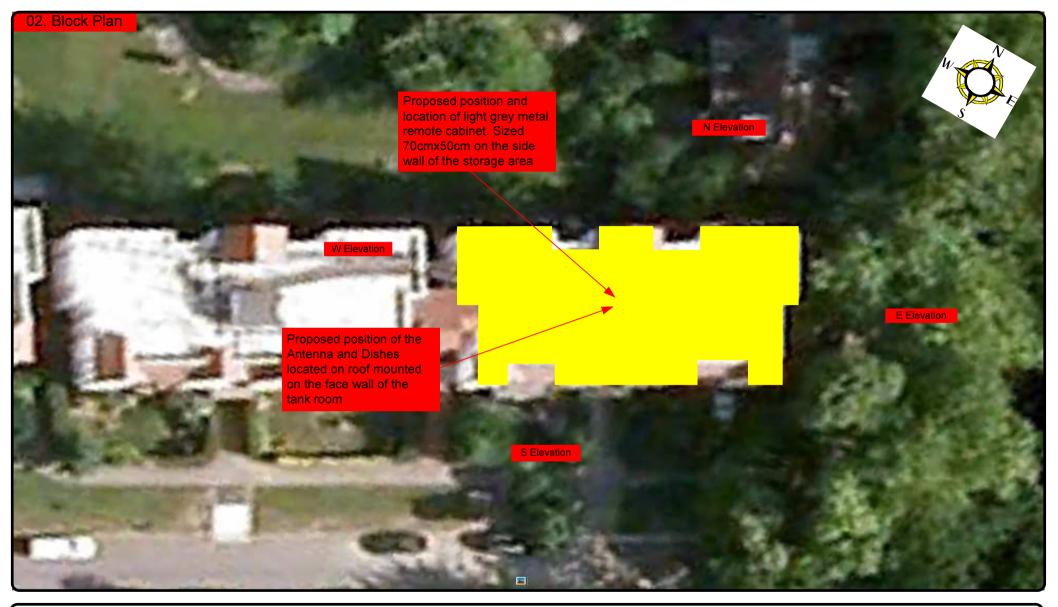





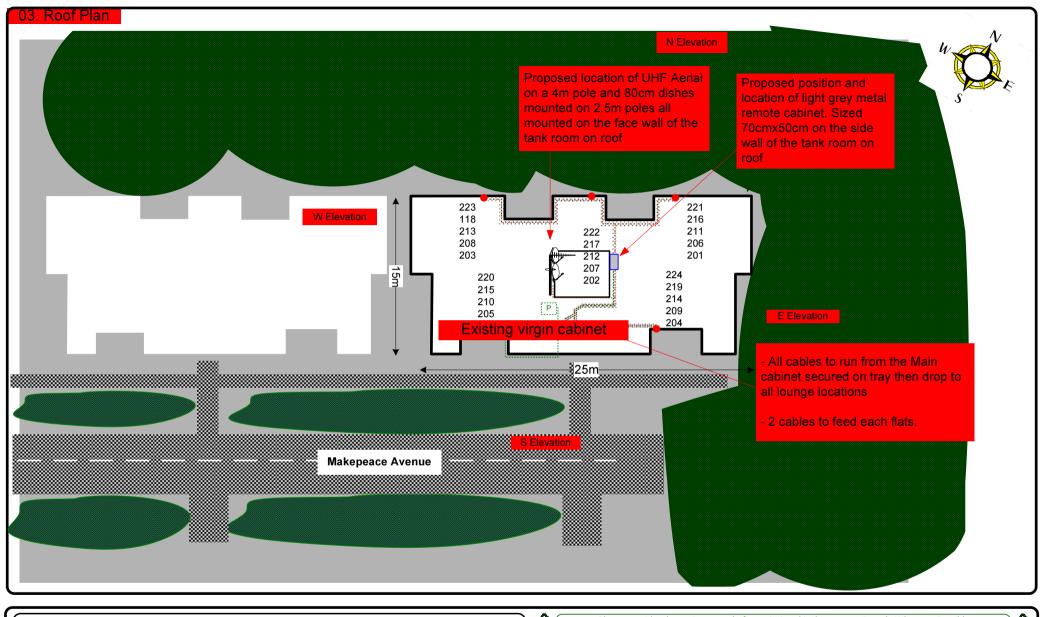



Cable Harness sizes

2-4 cables = 15mm

6-8 cables = 20mm


10-14 cables = 30mm

16-18 Cables = 35mm

20 cables = 40mm


40 cables = 65mm

60 cables = 90mm

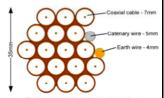

Typical loom for 16 coaxial cable + 1 earth wire, + 1 catenary wire



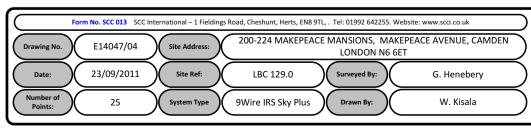



Cable Harness sizes

2-4 cables = 15mm


6-8 cables = 20mm


10-14 cables = 30mm


16-18 Cables = 35mm

20 cables = 40mm

40 cables = 65mm

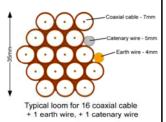

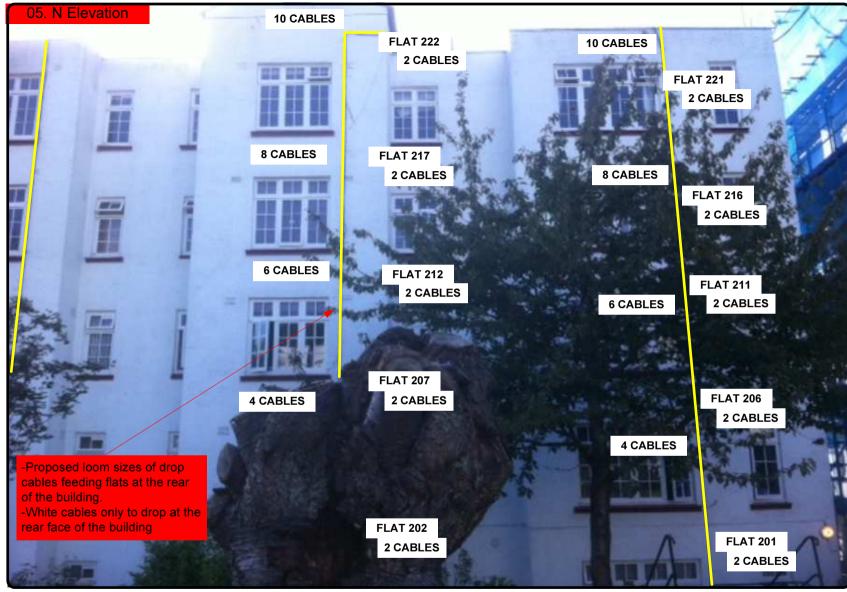

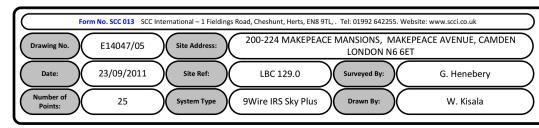



Cable Harness sizes

2-4 cables = 15mm


6-8 cables = 20mm


10-14 cables = 30mm


16-18 Cables = 35mm

20 cables = 40mm

40 cables = 65mm

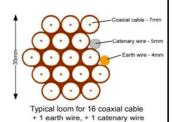

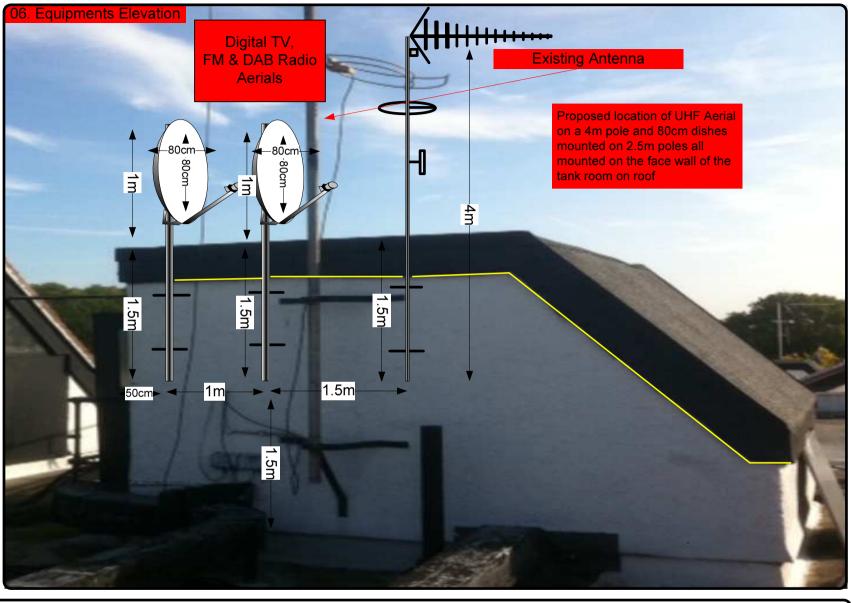

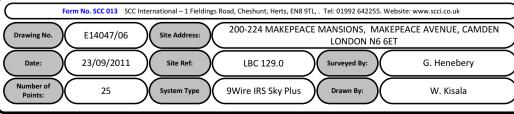



Cable Harness sizes

2-4 cables = 15mm


6-8 cables = 20mm


10-14 cables = 30mm


16-18 Cables = 35mm

20 cables = 40mm

40 cables = 65 mm

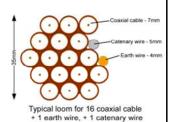

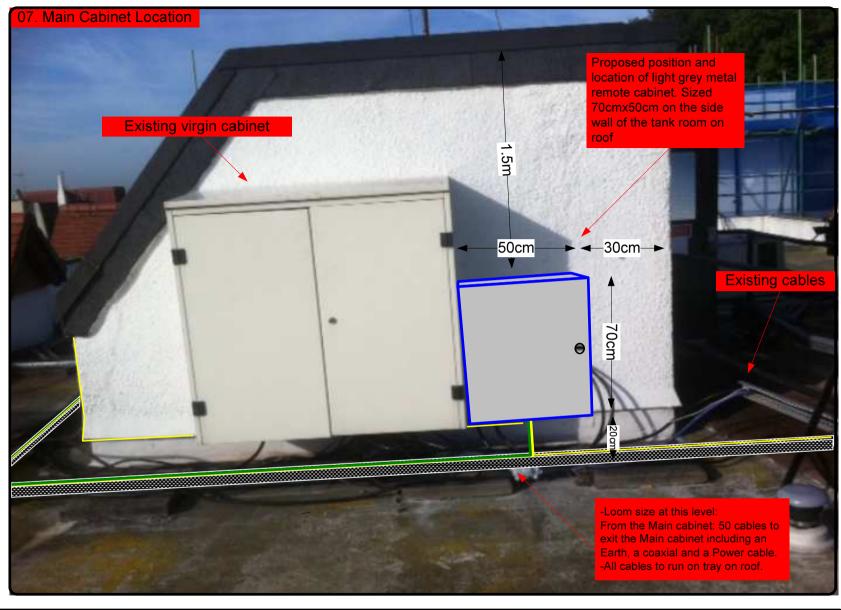

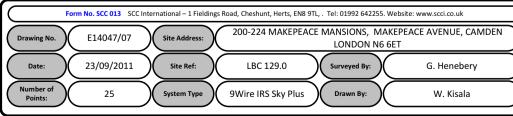



Cable Harness sizes

2-4 cables = 15mm

6-8 cables = 20mm

10-14 cables = 30mm

16-18 Cables = 35mm

20 cables = 40mm

40 cables = 65mm

