

Drawing Number	Drawing Title	Description
B04128/00	Index	Index of Drawings.
B04128/01	Location Plan	Scale 1:1250 at A4
B04128/02	Roof Plan	Drawing of block from above, showing equipment positions.
B04128/03	Roof Elevations	Roof view, cable routes and equipments mounting and measurements
B04128/04	North Elevation	Elevation view, cable routes, colour, loom sizes at entry point per flat
B04128/05	South Elevation	Elevation view, cable routes, colour, loom sizes at entry point per flat
B04128/06	Existing Equipment	Location and Descriptions of existing equipments on site before install.
B04128/07	Antenna, Dish Sizes & Typical Mounting Heights	Measurement of Dishes mounting position / height.

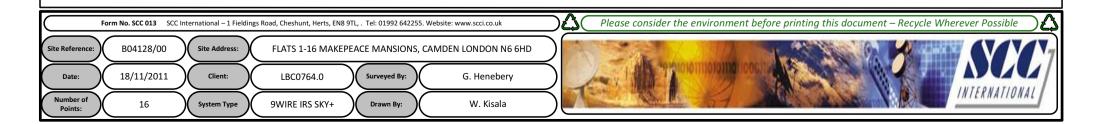

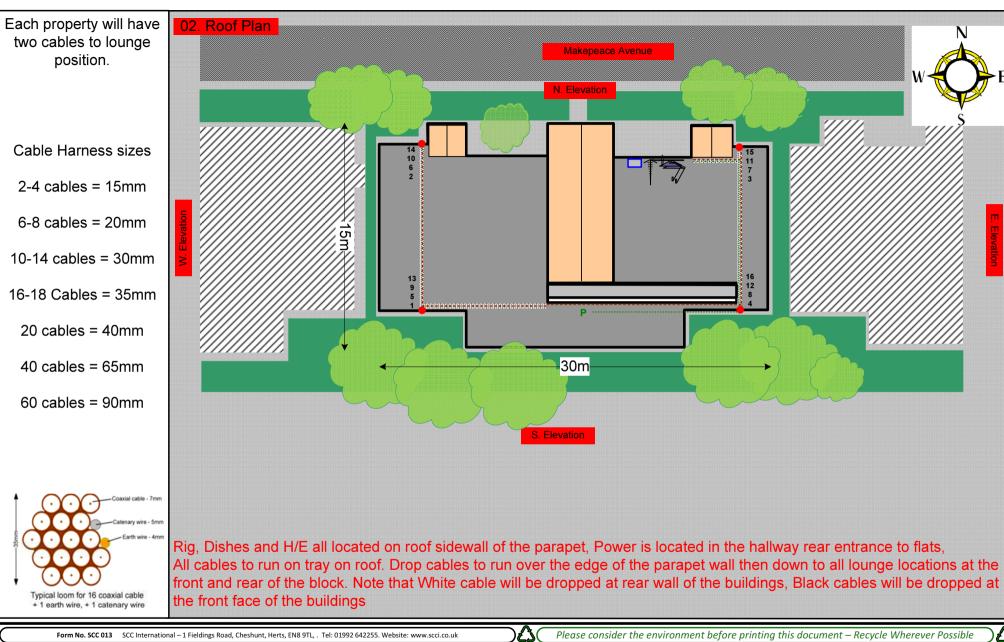




## 03. Roof Elevations

Location of 80cm dishes on the sidewall of the parapet on roof

32 cables to exit the remote cab and feed flat at rear and front of the building

Location of the remote cabinet. Sized 60x60cm on the sidewall of the parapet on roof

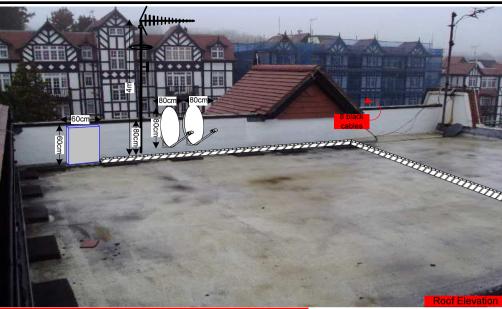

-White cables to run on tray at rear side of the roof the on the side of the ramp on roof then down to lounge points

-Black cables to run from the Main cabinet on roof then secured on tray then to drop at the front face to feed flats.







Each property will have two cables to lounge position.

Cable Harness sizes

2-4 cables = 15mm

6-8 cables = 20mm


10-14 cables = 30mm

16-18 Cables = 35mm

20 cables = 40mm


40 cables = 65mm

60 cables = 90mm

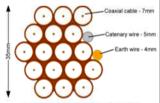

Typical loom for 16 coaxial cable + 1 earth wire, + 1 catenary wire



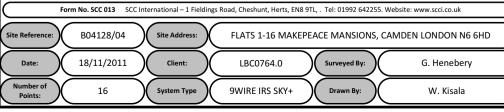



Each property will have two cables to lounge position.

Cable Harness sizes

2-4 cables = 15mm

6-8 cables = 20mm


10-14 cables = 30mm

16-18 Cables = 35mm

20 cables = 40mm

40 cables = 65mm

60 cables = 90mm

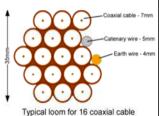


B04128/05

18/11/2011

16

Date: Number of

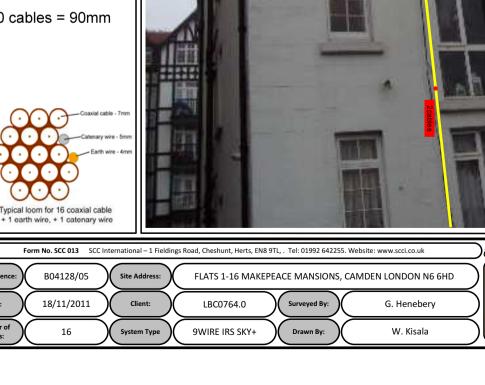





Each property will have two cables to lounge position.

Cable Harness sizes

2-4 cables = 15mm

6-8 cables = 20mm


10-14 cables = 30mm

16-18 Cables = 35mm

20 cables = 40mm

40 cables = 65mm


60 cables = 90mm

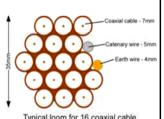

## 06. Existing Equipments





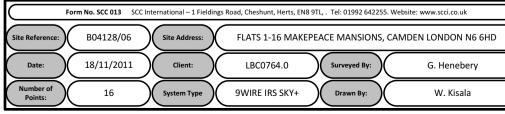



Each property will have two cables to lounge position.

Cable Harness sizes

2-4 cables = 15mm

6-8 cables = 20mm


10-14 cables = 30mm

16-18 Cables = 35mm

20 cables = 40mm

40 cables = 65mm

60 cables = 90mm

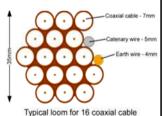

Typical loom for 16 coaxial cable + 1 earth wire, + 1 catenary wire

## 07. Antenna and Dishes Measurements

Proposed location of UHF Aerial on a 4m pole mounted using wall bracket and 80cm dishes mounted using lashing kits. all installed on the sidewall of the chimny on roof

<del>≰</del> 60cm

H/E

Digital TV, FM & DAB Radio Aerials

