

00. INDEX

Drawing Number	Drawing Title	Description
E12005/00	Index	Index of Drawings.
E12005/01	Location Plan	Scale 1:1250 at A4.
E12005/02	Block Plan	Photo of Site from above.
E12005/03	Roof Plan	Drawing of block from above, showing equipment positions.
E12005/04	South West Elevation 1	Description and location of the antenna, dishes and Main Cabinet + mounting
E12005/05	South West Elevation 2	Description of cable routes, colour and loom sizes per flats at entry points for each drops
E12005/06	South West Elevation 3	Description of cable routes, colour and loom sizes per flats at entry points for each drops (Remote)
E12005/07	South East Elevation 1	Description of cable routes, colour and loom sizes per flats at entry points for each drops
E12005/08	South East Elevation 2	Description of cable routes, colour and loom sizes per flats at entry points for each drops
E12005/09	Existing Equipments	View and location of existing equipment on site
E12005/10	Antenna, Dish Sizes & Typical Mounting Heights	Antenna and Dishes description, mounting, position, height and measurements.

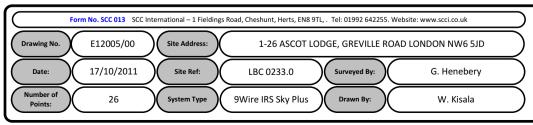




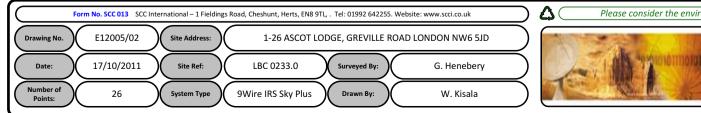





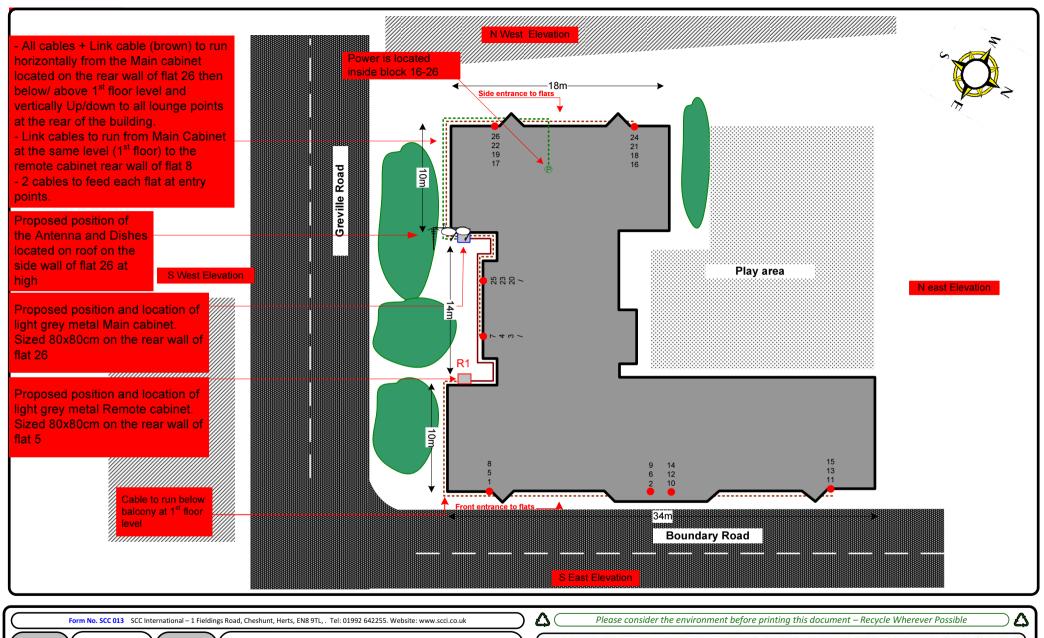



Cable Harness sizes

2-4 cables = 15mm

6-8 cables = 20mm


10-14 cables = 30mm

16-18 Cables = 35mm

20 cables = 40mm


40 cables = 65mm

60 cables = 90mm

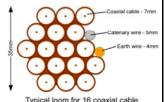

Typical loom for 16 coaxial cable + 1 earth wire, + 1 catenary wire



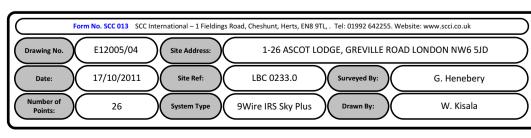



Cable Harness sizes

2-4 cables = 15mm

6-8 cables = 20mm


10-14 cables = 30mm

16-18 Cables = 35mm

20 cables = 40mm

40 cables = 65mm

60 cables = 90mm

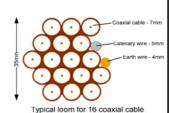

E12005/05

Drawing No.

Date:



1-26 ASCOT LODGE, GREVILLE ROAD LONDON NW6 5JD

17/10/2011 Site Ref: LBC 0233.0

Site Address:

9Wire IRS Sky Plus

Surveyed By:

G. Henebery

W. Kisala

A Please consider the environment before printing this document – Recycle Wherever Possible





Cable Harness sizes

2-4 cables = 15mm

6-8 cables = 20mm


10-14 cables = 30mm

16-18 Cables = 35mm

20 cables = 40mm

40 cables = 65mm

60 cables = 90mm

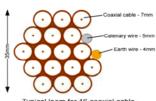

Typical loom for 16 coaxial cable + 1 earth wire, + 1 catenary wire







Cable Harness sizes

2-4 cables = 15mm

6-8 cables = 20mm


10-14 cables = 30mm

16-18 Cables = 35mm

20 cables = 40mm

40 cables = 65mm

60 cables = 90mm

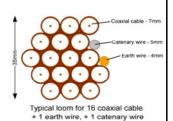







Cable Harness sizes

2-4 cables = 15mm

6-8 cables = 20mm


10-14 cables = 30mm

16-18 Cables = 35mm


20 cables = 40mm

40 cables = 65mm

60 cables = 90mm

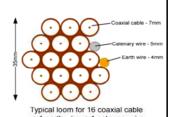



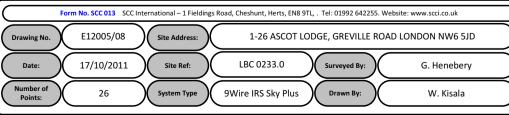



Cable Harness sizes

2-4 cables = 15mm

6-8 cables = 20mm

10-14 cables = 30mm

16-18 Cables = 35mm

20 cables = 40mm

40 cables = 65mm

60 cables = 90mm

