

00. INDEX

Drawing Number	Drawing Title	Description
B13038/00	Index	Index of Drawings.
B13038/01	Location Plan	Scale 1:1250 at A4.
B13038/02	Block Plan	Photo of Site from above.
B13038/03	Roof Plan	Drawing of block from above, showing equipment positions.
B13038/04	Roof Elevation	Description and location of the antenna and dishes + mounting and measurements and Description and location of the main cabinet size, colour + measurements.
B13038/05	East Elevation	Description and location of the Remote cabinet size, colour + measurements.
B13038/06	East Elevation 2	Description of Cable routes, loom sizes and entry points.
B13038/07	West Elevation 1	Description of Cable routes, loom sizes and entry points.
B13038/08	East Elevation 3	Description of Cable routes, loom sizes and entry points.
B13038/09	East Elevation 4	Description of Cable routes, loom sizes and entry points.
B13038/10	Existing Equipments	Description, location and view of the existing equipment on site before install.
B13038/11	Antenna, Dish Sizes & Typical Mounting Heights	Sketch of the Antenna and Dishes + mounting, position and height.

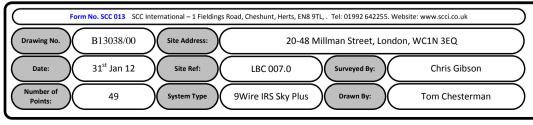




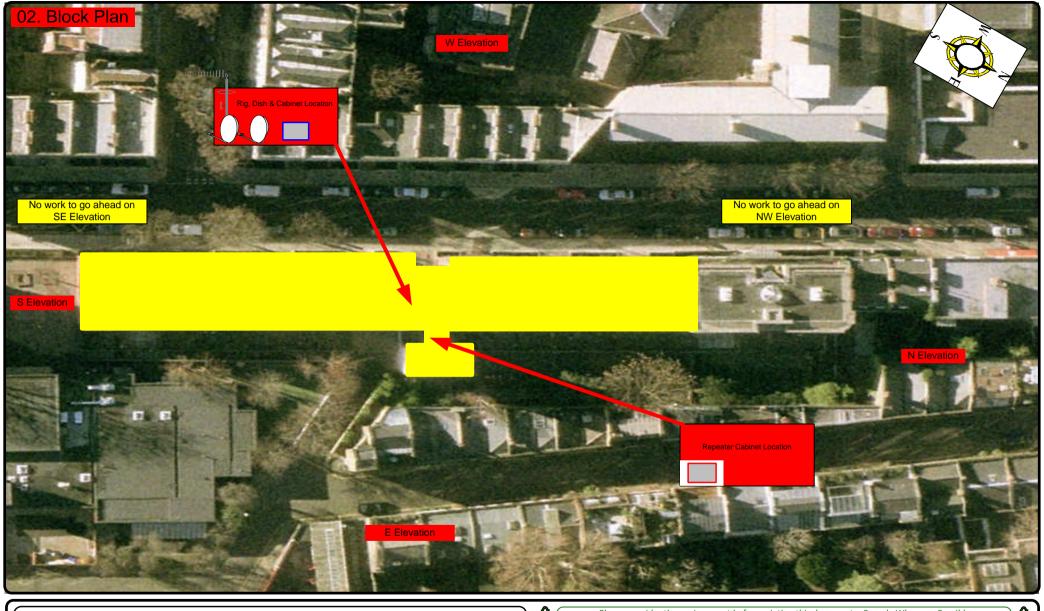





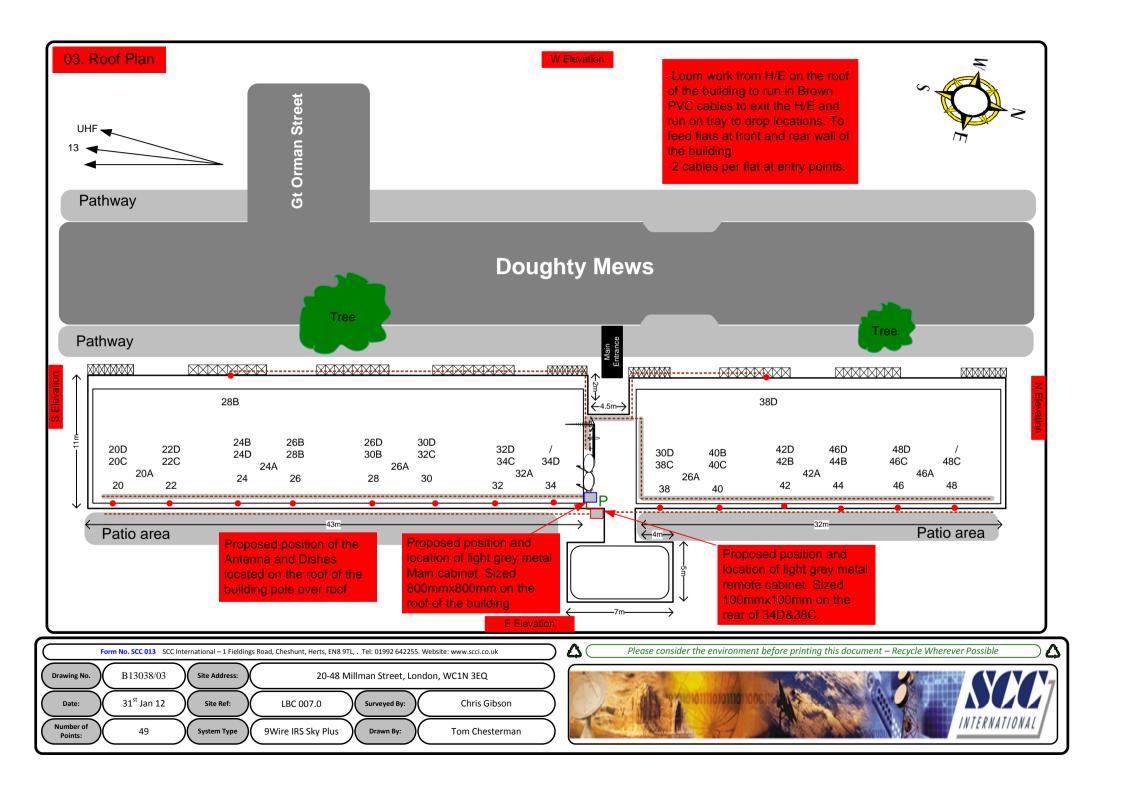

Cable Harness sizes

2-4 cables = 15mm

6-8 cables = 20mm


10-14 cables = 30mm

16-18 Cables = 35mm


20 cables = 40 mm


40 cables = 65 mm

60 cables = 90 mm

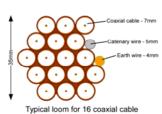

+ 1 earth wire, + 1 catenary wire

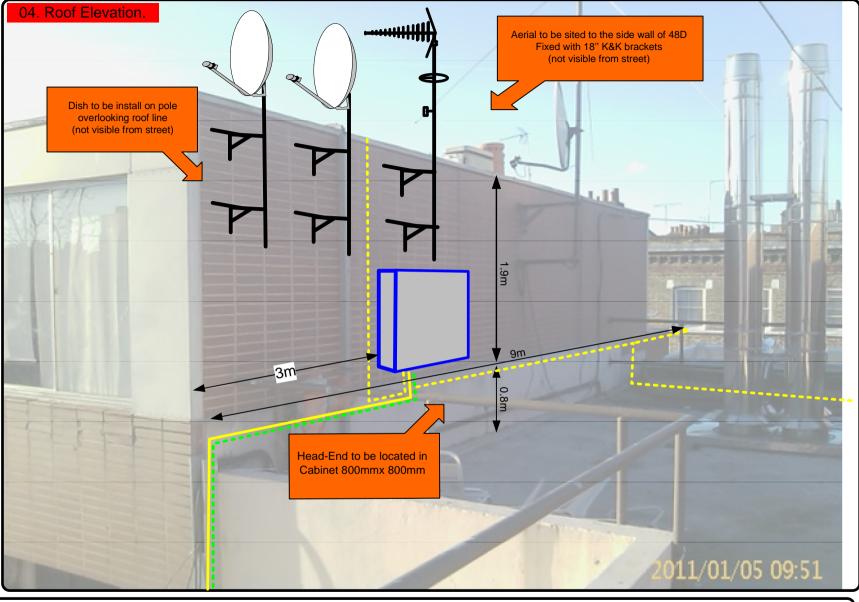

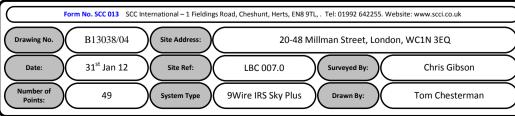



Cable Harness sizes

2-4 cables = 15mm

6-8 cables = 20mm


10-14 cables = 30mm


16-18 Cables = 35mm


20 cables = 40 mm

40 cables = 65 mm

60 cables = 90mm

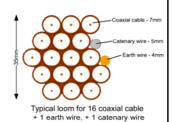

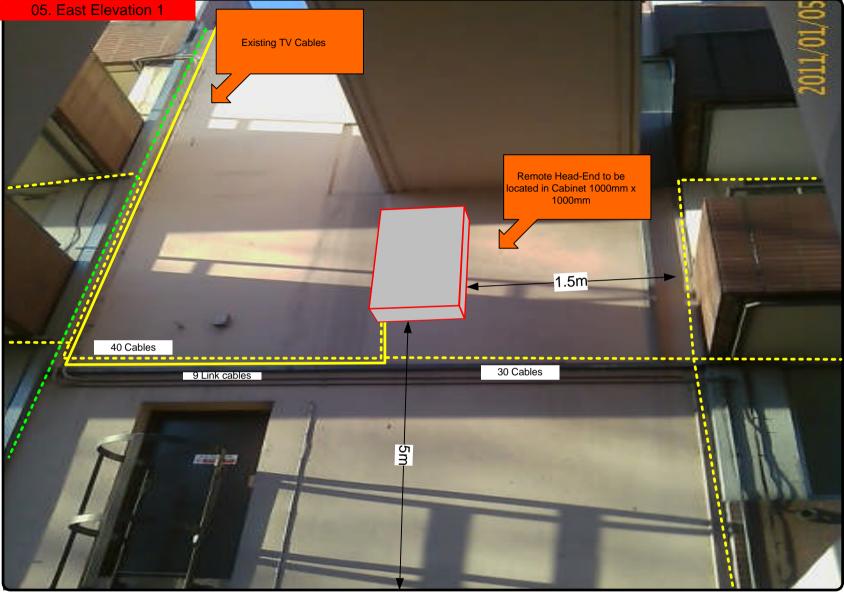

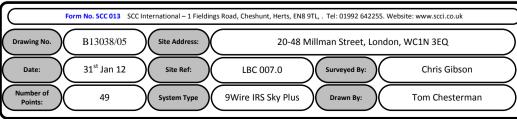



Cable Harness sizes

2-4 cables = 15mm

6-8 cables = 20mm


10-14 cables = 30mm

16-18 Cables = 35mm


20 cables = 40 mm


40 cables = 65 mm

60 cables = 90 mm

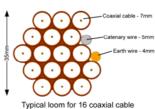

Typical loom for 16 coaxial cable + 1 earth wire, + 1 catenary wire

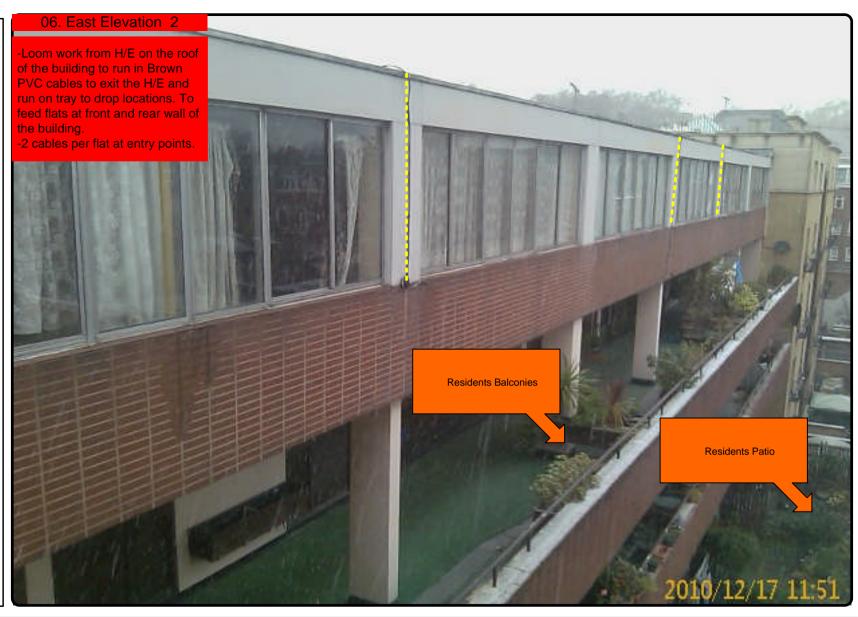

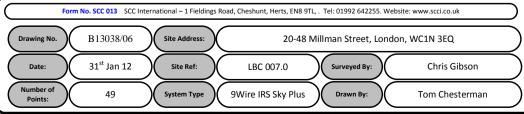



Cable Harness sizes

2-4 cables = 15mm

6-8 cables = 20mm


10-14 cables = 30mm

16-18 Cables = 35mm


20 cables = 40 mm

40 cables = 65 mm

60 cables = 90 mm

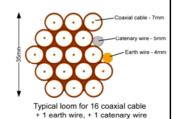



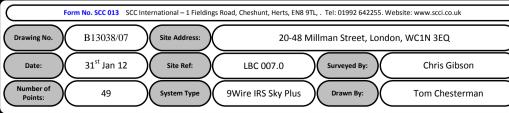



Each property will have two cables to lounge position. Cable Harness sizes

2-4 cables = 15mm

6-8 cables = 20 mm


10-14 cables = 30mm


16-18 Cables = 35mm


20 cables = 40 mm

40 cables = 65 mm

60 cables = 90 mm

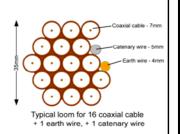

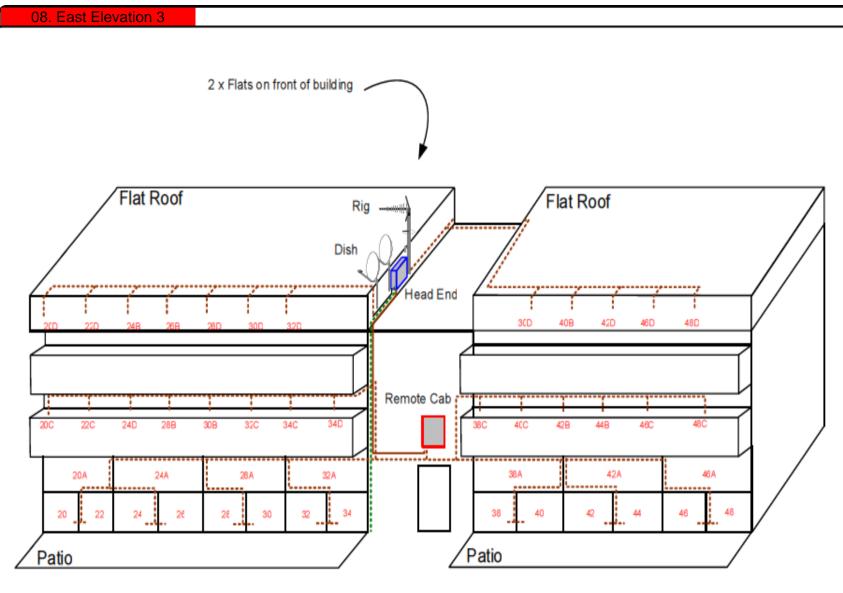

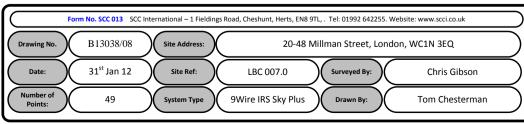



Cable Harness sizes

2-4 cables = 15mm

6-8 cables = 20mm


10-14 cables = 30mm

16-18 Cables = 35mm

20 cables = 40 mm


40 cables = 65 mm

60 cables = 90 mm

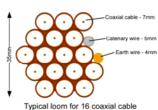

Typical loom for 16 coaxial cable + 1 earth wire, + 1 catenary wire



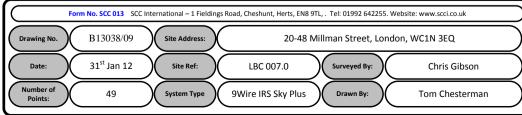



Cable Harness sizes

2-4 cables = 15mm

6-8 cables = 20mm


10-14 cables = 30mm

16-18 Cables = 35mm

20 cables = 40 mm

40 cables = 65mm

60 cables = 90mm

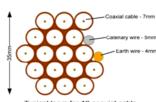

Typical loom for 16 coaxial cable + 1 earth wire. + 1 catenary wire

