

00. INDEX

Drawing Number	Drawing Title	Description
E00029/00	Index	Index of Drawings.
E00029/01	Location Plan	Scale 1:1250 at A4.
E00029/02	Block Plan	Photo of Site from above.
E00029/03	Roof Plan	Drawing of block from above, showing equipment positions.
E00029/04	West Elevation 1	Description and location of the Main cabinet size, colour + measurements and location of the antenna and dishes + mounting and measurements.
E00029/05	West Elevation 2	Description of Cable routes, loom sizes and entry points.
E00029/06	West Elevation 3	Description of Cable routes, loom sizes and entry points.
E00029/07	North Elevation 1	Description of Cable routes, loom sizes and entry points.
E00029/08	North Elevation 2	Description of Cable routes, loom sizes and entry points.
E00029/09	East Elevation 1	Description and location of the remote cabinet one size, colour
E00029/10	East Elevation 2	Description of Cable routes, loom sizes and entry points.
E00029/11	South Elevation	Description of Cable routes, loom sizes and entry points.
E00029/12	South West Elevation	Description and location of the remote two cabinet size, colour
E00029/13	Existing Equipments	Description, location and view of the existing equipment on site before install.
E00029/14	Antenna, Dish Sizes & Typical Mounting Heights	Sketch of the Antenna and Dishes + mounting, position and height.

Form No. SCC 013 SCC International – 1 Fieldings Road, Cheshunt, Herts, EN8 9TL, . Tel: 01992 642255. Website: www.scci.co.uk



Please consider the environment before printing this document – Recycle Wherever Possible



Drawing No.	E00029/00	Site Address:	1-17 & 29A-C Purchase Street, 1-19 Somers Close Estate, Camden, London, NW1 1RW		
Date:	14 th Oct 11	Site Ref:	LBC 0587.0	Surveyed By:	Danny Varleigh
Number of Points:	26	System Type	9Wire IRS Sky Plus	Drawn By:	James Schroder



02. Block Plan



Form No. SCC 013 SCC International – 1 Fieldings Road, Cheshunt, Herts, EN8 9TL, . Tel: 01992 642255. Website: www.scci.co.uk



Please consider the environment before printing this document – Recycle Wherever Possible





Drawing No.	E00029/00	Site Address:	1-17 & 29A-C Purchase Street, 1-19 Somers Close Estate, Camden, London, NW1 1RW		
Date:	14 th Oct 11	Site Ref:	LBC 0587.0	Surveyed By:	Danny Varleigh
Number of Points:	26	System Type	9Wire IRS Sky Plus	Drawn By:	James Schroder



03. Roof Plan

Platt Street

N Elevation

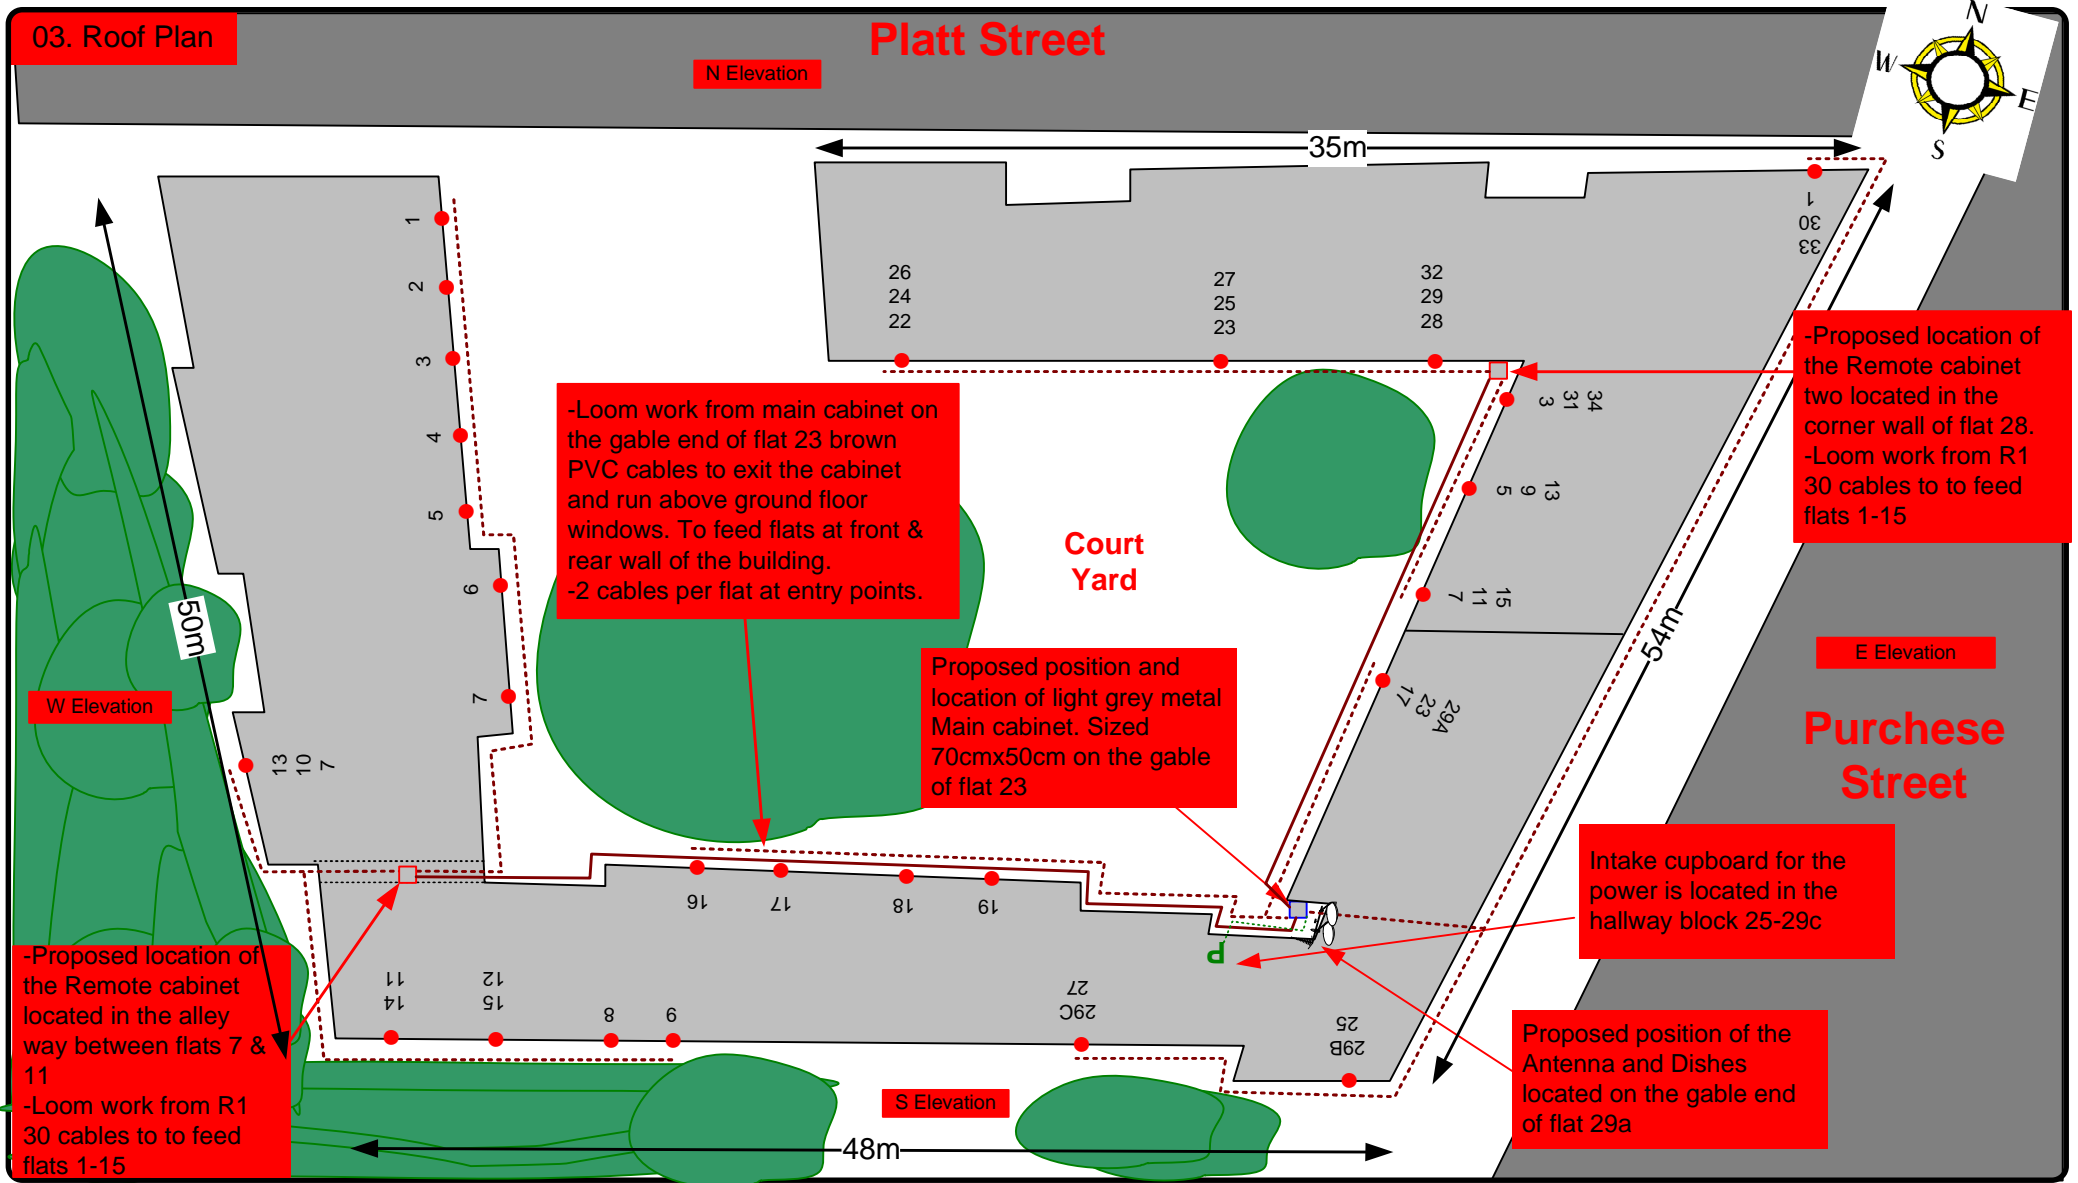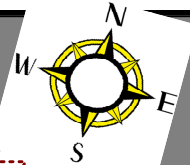

-Loom work from main cabinet on the gable end of flat 23 brown PVC cables to exit the cabinet and run above ground floor windows. To feed flats at front & rear wall of the building.
-2 cables per flat at entry points.

Proposed position and location of light grey metal Main cabinet. Sized 70cmx50cm on the gable of flat 23

-Proposed location of the Remote cabinet two located in the corner wall of flat 28.
-Loom work from R1 30 cables to feed flats 1-15

-Proposed location of the Remote cabinet located in the alley way between flats 7 & 11
-Loom work from R1 30 cables to feed flats 1-15

Intake cupboard for the power is located in the hallway block 25-29c

Proposed position of the Antenna and Dishes located on the gable end of flat 29a

Form No. SCC 013 SCC International – 1 Fieldings Road, Cheshunt, Herts, EN8 9TL. Tel: 01992 642255. Website: www.scci.co.uk

Please consider the environment before printing this document – Recycle Wherever Possible

Drawing No.	E00029/00	Site Address:	1-17 & 29A-C Purchase Street, 1-19 Somers Close Estate, Camden, London, NW1 1RW		
Date:	14 th Oct 11	Site Ref:	LBC 0587.0	Surveyed By:	Danny Varleigh
Number of Points:	26	System Type	9Wire IRS Sky Plus	Drawn By:	James Schroder



Each property will have two cables to lounge position.

Cable Harness sizes

2-4 cables = 15mm

6-8 cables = 20mm


10-14 cables = 30mm

16-18 Cables = 35mm

20 cables = 40mm


40 cables = 65mm

60 cables = 90mm

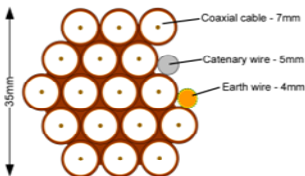

Typical loom for 16 coaxial cable + 1 earth wire, + 1 catenary wire

04. West Elevation.

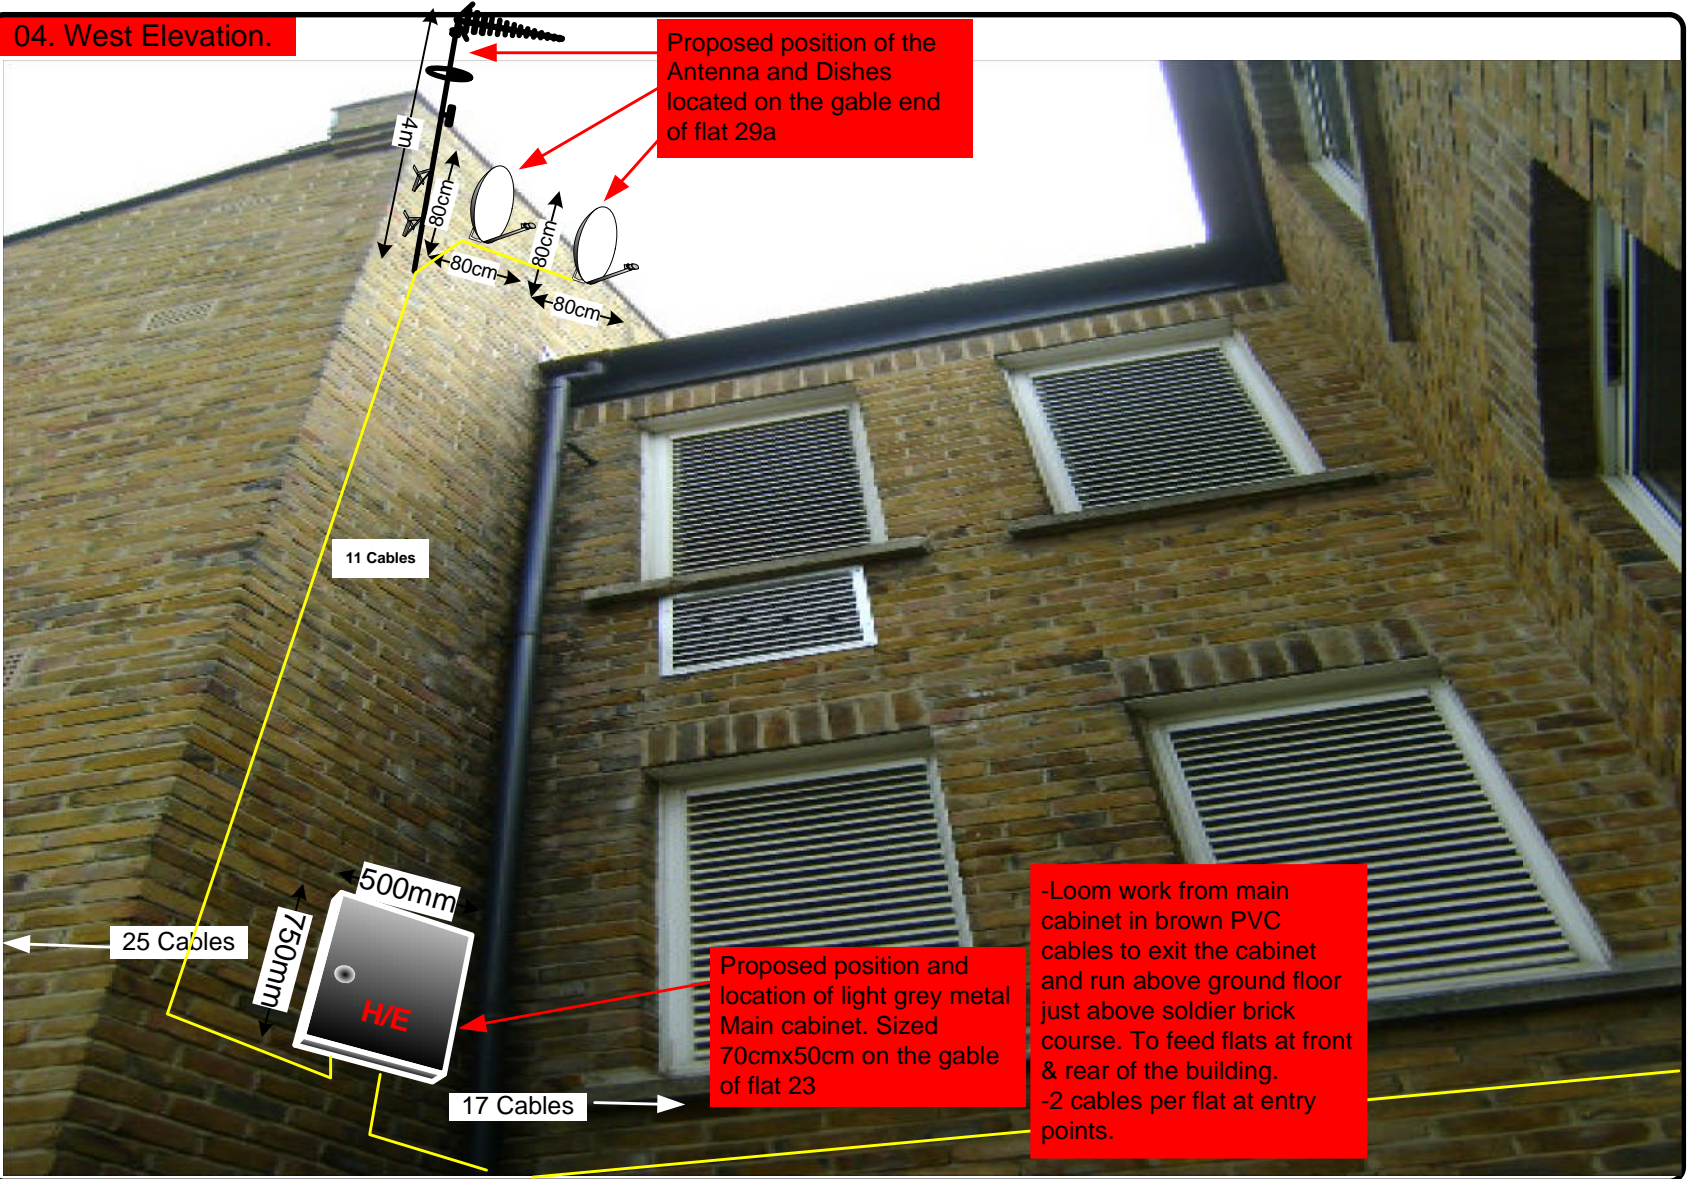

Proposed position of the Antenna and Dishes located on the gable end of flat 29a

-Loom work from main cabinet in brown PVC cables to exit the cabinet and run above ground floor just above soldier brick course. To feed flats at front & rear of the building.
-2 cables per flat at entry points.


Proposed position and location of light grey metal Main cabinet. Sized 70cmx50cm on the gable of flat 23

Drawing No.	E00029/00	Site Address:	1-17 & 29A-C Purchase Street, 1-19 Somers Close Estate, Camden, London, NW1 1RW		
Date:	14 th Oct 11	Site Ref:	LBC 0587.0	Surveyed By:	Danny Varleigh
Number of Points:	26	System Type	9Wire IRS Sky Plus	Drawn By:	James Schroder




Each property will have two cables to lounge position.

- Cable Harness sizes
- 2-4 cables = 15mm
 - 6-8 cables = 20mm
 - 10-14 cables = 30mm
 - 16-18 Cables = 35mm
 - 20 cables = 40mm
 - 40 cables = 65mm
 - 60 cables = 90mm

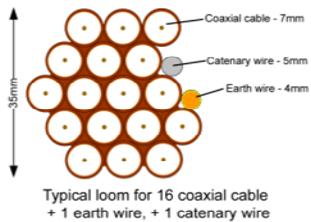

05. West Elevation

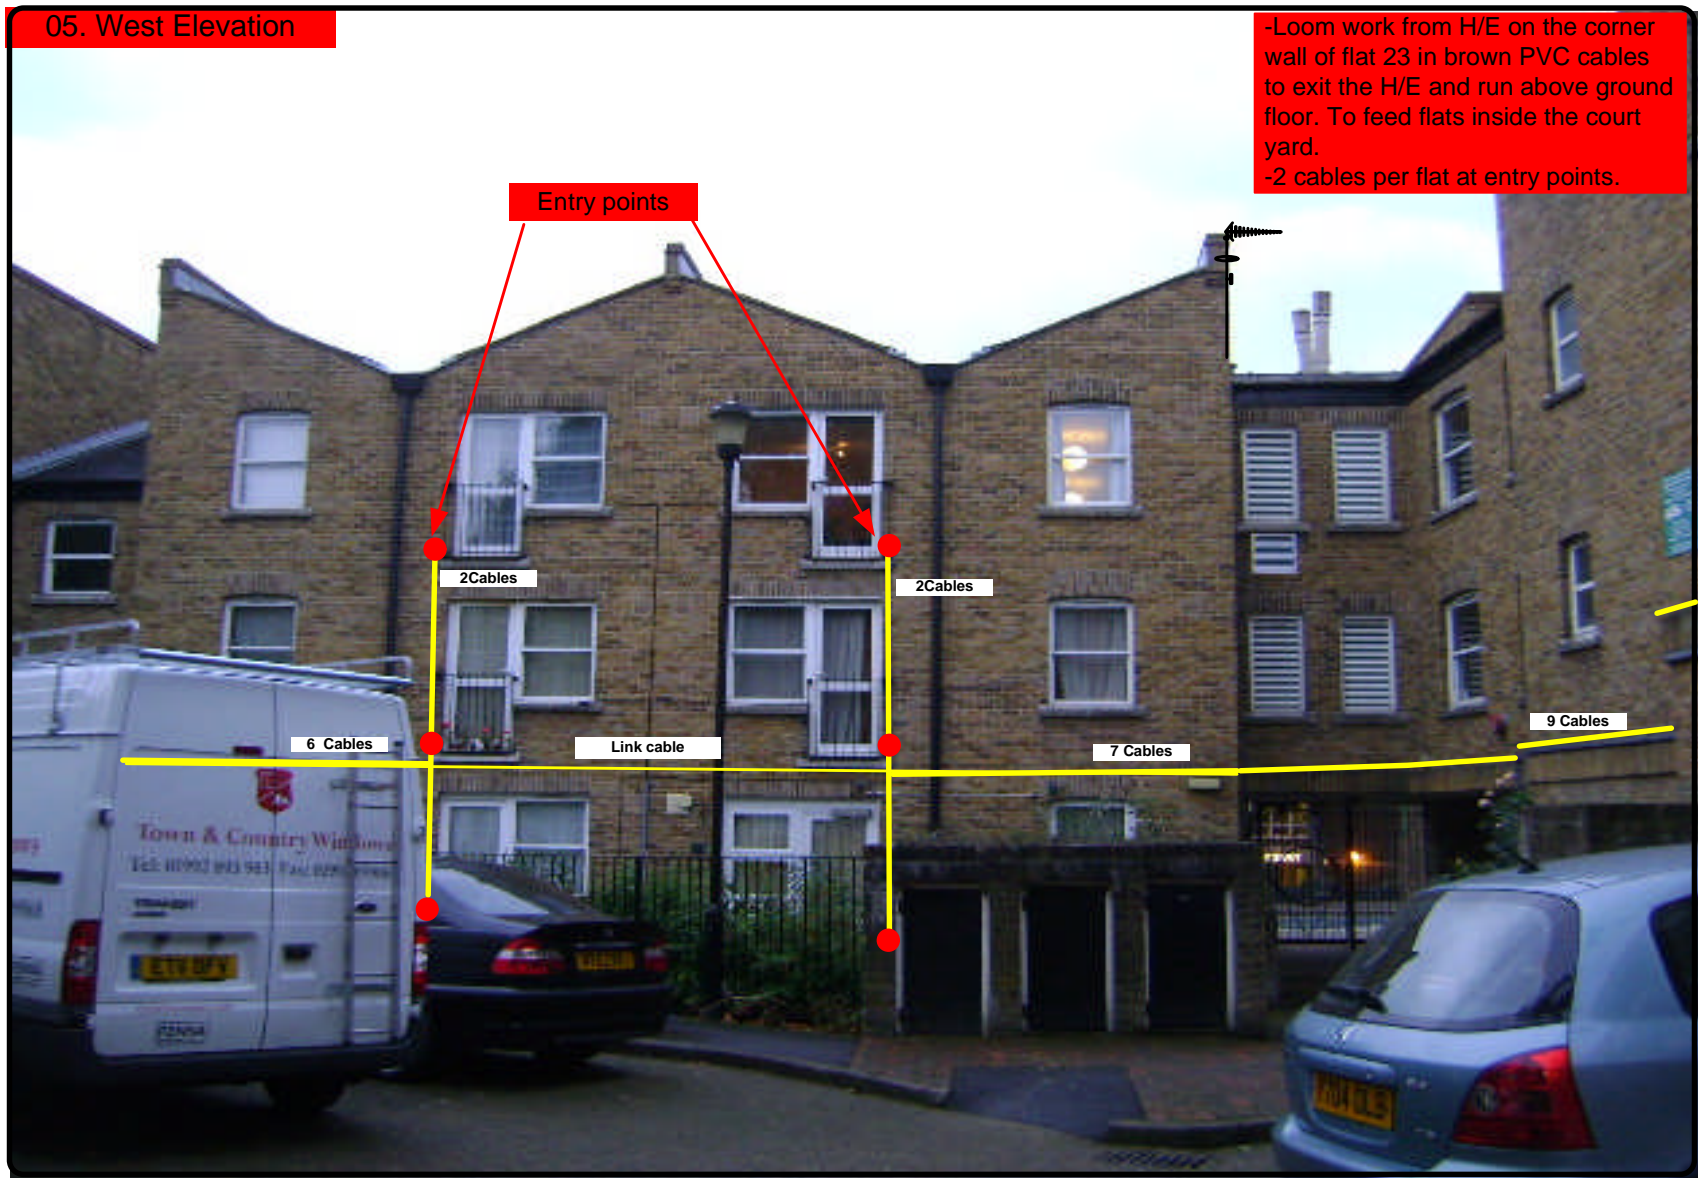

-Loom work from H/E on the corner wall of flat 23 in brown PVC cables to exit the H/E and run above ground floor. To feed flats inside the court yard.
-2 cables per flat at entry points.

Form No. SCC 013 SCC International – 1 Fieldings Road, Cheshunt, Herts, EN8 9TL, . Tel: 01992 642255. Website: www.scci.co.uk

Please consider the environment before printing this document – Recycle Wherever Possible

Drawing No.	E00029/00	Site Address:	1-17 & 29A-C Purchase Street, 1-19 Somers Close Estate, Camden, London, NW1 1RW		
Date:	14 th Oct 11	Site Ref:	LBC 0587.0	Surveyed By:	Danny Varleigh
Number of Points:	26	System Type	9Wire IRS Sky Plus	Drawn By:	James Schroder



Each property will have two cables to lounge position.

Cable Harness sizes

2-4 cables = 15mm

6-8 cables = 20mm


10-14 cables = 30mm

16-18 Cables = 35mm

20 cables = 40mm

40 cables = 65mm

60 cables = 90mm

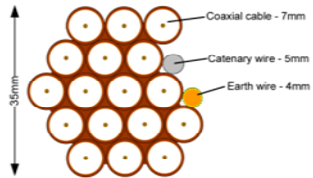

Typical loom for 16 coaxial cable + 1 earth wire, + 1 catenary wire

06. West Elevation

-Loom work from remote cabinet one in the alleyway between 7 & 11 in brown PVC cables to exit the remote and run above ground floor. To feed flats at front wall of the building.
 -2 cables per flat at entry points.



Entry points

Form No. SCC 013 SCC International – 1 Fieldings Road, Cheshunt, Herts, EN8 9TL, . Tel: 01992 642255. Website: www.scci.co.uk



Please consider the environment before printing this document – Recycle Wherever Possible



Drawing No.	E00029/00	Site Address:	1-17 & 29A-C Purchase Street, 1-19 Somers Close Estate, Camden, London, NW1 1RW	
Date:	14 th Oct 11	Site Ref:	LBC 0587.0	Surveyed By: Danny Varleigh
Number of Points:	26	System Type	9Wire IRS Sky Plus	Drawn By: James Schroder



Each property will have two cables to lounge position.

Cable Harness sizes

2-4 cables = 15mm

6-8 cables = 20mm


10-14 cables = 30mm

16-18 Cables = 35mm

20 cables = 40mm

40 cables = 65mm

60 cables = 90mm

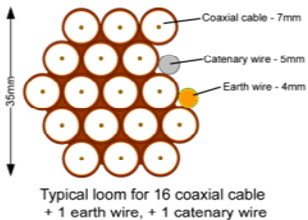

07. North Elevation

- Loom work from Headend on the corner wall of flat 29A in court yard brown PVC cables to exit the cabinet and run through the alley way then above ground floor. To feed flats at front of the building.
 - 2 cables per flat at entry points.



Form No. SCC 013 SCC International – 1 Fieldings Road, Cheshunt, Herts, EN8 9TL, . Tel: 01992 642255. Website: www.scci.co.uk

Please consider the environment before printing this document – Recycle Wherever Possible

Drawing No.	E00029/00	Site Address:	1-17 & 29A-C Purchase Street, 1-19 Somers Close Estate, Camden, London, NW1 1RW	
Date:	14 th Oct 11	Site Ref:	LBC 0587.0	Surveyed By: Danny Varleigh
Number of Points:	26	System Type	9Wire IRS Sky Plus	Drawn By: James Schroder



Each property will have two cables to lounge position.

Cable Harness sizes

2-4 cables = 15mm

6-8 cables = 20mm


10-14 cables = 30mm

16-18 Cables = 35mm

20 cables = 40mm

40 cables = 65mm

60 cables = 90mm

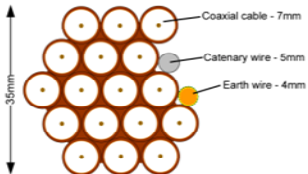

Typical loom for 16 coaxial cable + 1 earth wire, + 1 catenary wire

08. North Elevation.



-Loom work from main cabinet on the corner wall of flat 23 in court yard brown PVC cables to exit the cabinet and run above ground floor just above the soldier course. To feed flats at front & rear wall of the building.
-2 cables per flat at entry points.

2 Cables

7 Cables

2 Cables

5 Cables

3 Cables

17 Cables

9 Cables

8 Cables

Entry points

Form No. SCC 013 SCC International – 1 Fieldings Road, Cheshunt, Herts, EN8 9TL. Tel: 01992 642255. Website: www.scci.co.uk

Please consider the environment before printing this document – Recycle Wherever Possible

Drawing No.	E00029/00	Site Address:	1-17 & 29A-C Purchase Street, 1-19 Somers Close Estate, Camden, London, NW1 1RW	
Date:	14 th Oct 11	Site Ref:	LBC 0587.0	Surveyed By: Danny Varleigh
Number of Points:	26	System Type	9Wire IRS Sky Plus	Drawn By: James Schroder



Each property will have two cables to lounge position.

Cable Harness sizes

2-4 cables = 15mm

6-8 cables = 20mm


10-14 cables = 30mm

16-18 Cables = 35mm

20 cables = 40mm

40 cables = 65mm


60 cables = 90mm

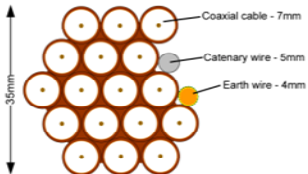

Typical loom for 16 coaxial cable + 1 earth wire, + 1 catenary wire

09. Internal East Elevation

-Proposed location of the Remote cabinet located on in alleyway between 7 & 11.
 -Loom work from R1 32 cables to to feed flats 1-15

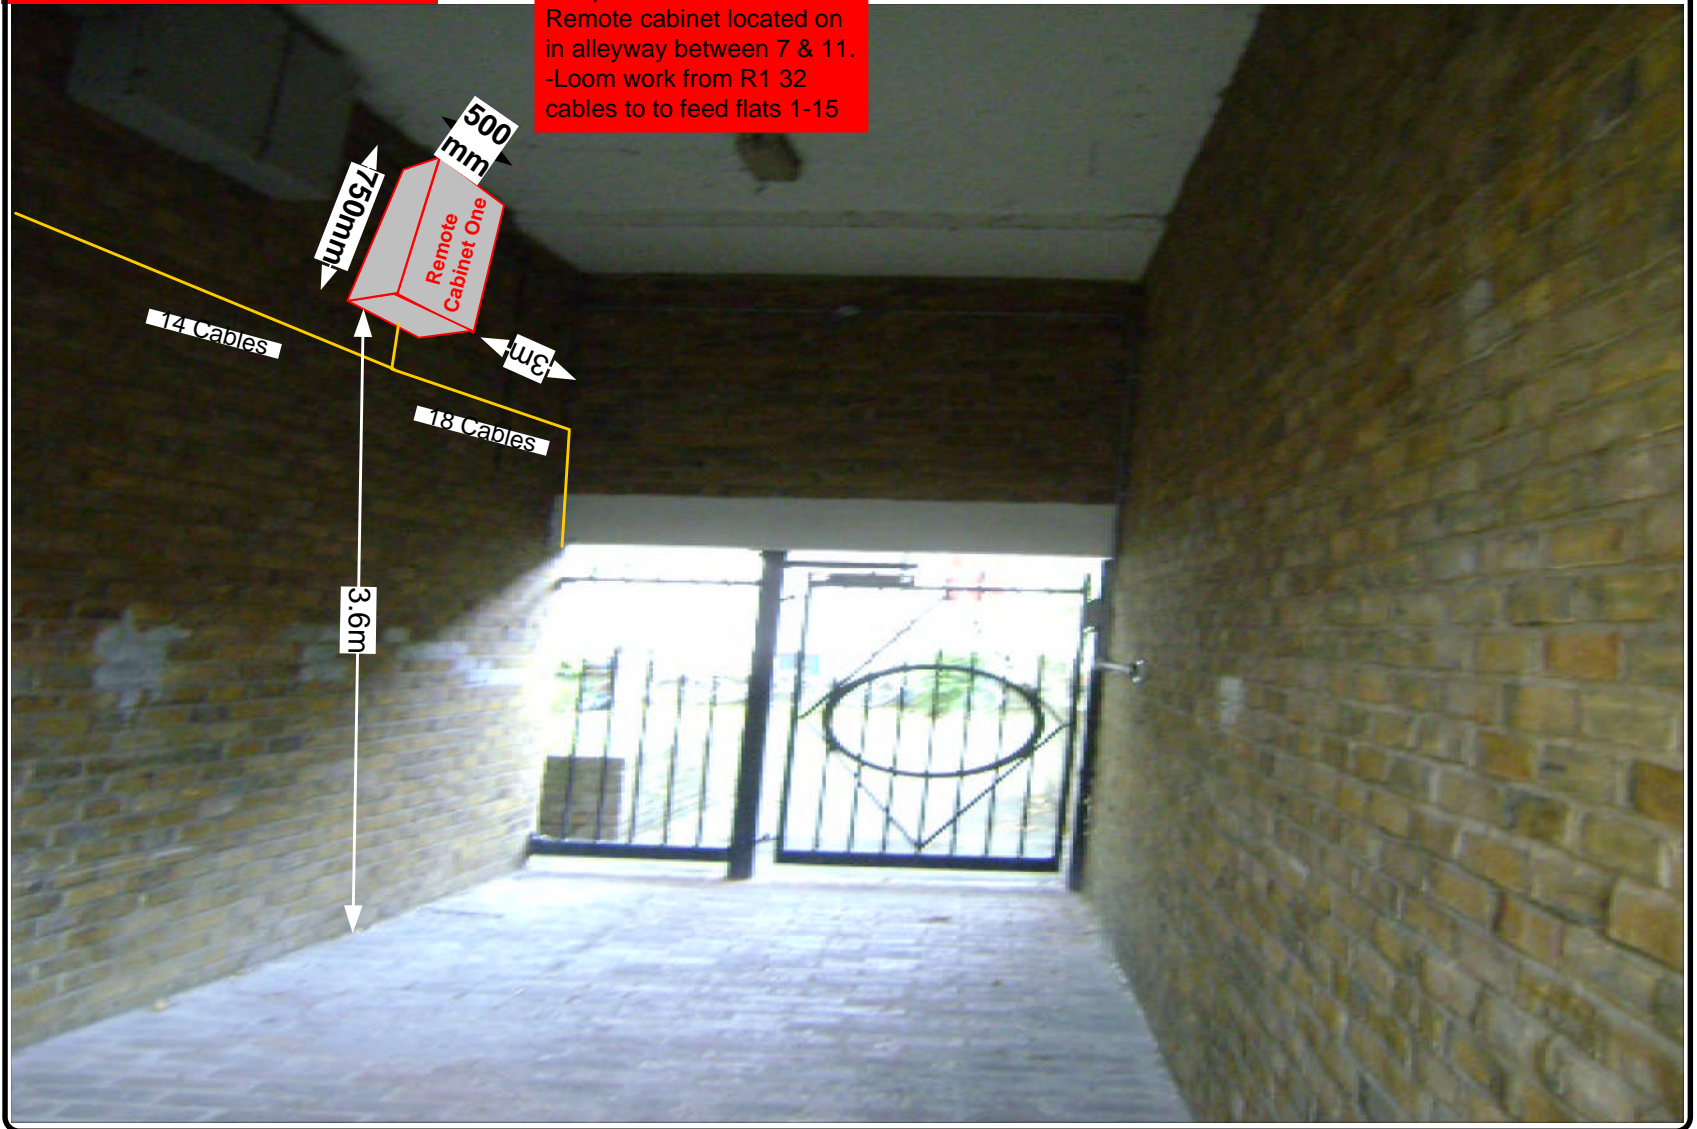

Drawing No.	E00029/00	Site Address:	1-17 & 29A-C Purchase Street, 1-19 Somers Close Estate, Camden, London, NW1 1RW	
Date:	14 th Oct 11	Site Ref:	LBC 0587.0	Surveyed By: Danny Varleigh
Number of Points:	26	System Type:	9Wire IRS Sky Plus	Drawn By: James Schroder



Each property will have two cables to lounge position.

Cable Harness sizes

2-4 cables = 15mm

6-8 cables = 20mm


10-14 cables = 30mm

16-18 Cables = 35mm

20 cables = 40mm

40 cables = 65mm

60 cables = 90mm

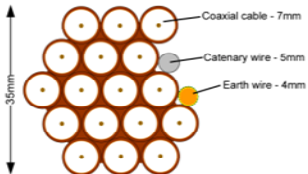

Typical loom for 16 coaxial cable + 1 earth wire, + 1 catenary wire

10. East Elevation



- Loom work from main cabinet on the corner wall of flat 23 in court yard brown PVC cables to exit the cabinet and run above ground floor above soldier brick course. To feed flats at front & rear wall of the building.
- 2 cables per flat at entry points.

Form No. SCC 013 SCC International – 1 Fieldings Road, Cheshunt, Herts, EN8 9TL. Tel: 01992 642255. Website: www.scci.co.uk

Please consider the environment before printing this document – Recycle Wherever Possible

Drawing No.	E00029/00	Site Address:	1-17 & 29A-C Purchase Street, 1-19 Somers Close Estate, Camden, London, NW1 1RW	
Date:	14 th Oct 11	Site Ref:	LBC 0587.0	Surveyed By: Danny Varleigh
Number of Points:	26	System Type	9Wire IRS Sky Plus	Drawn By: James Schroder



Each property will have two cables to lounge position.

Cable Harness sizes

2-4 cables = 15mm

6-8 cables = 20mm


10-14 cables = 30mm

16-18 Cables = 35mm

20 cables = 40mm

40 cables = 65mm

60 cables = 90mm

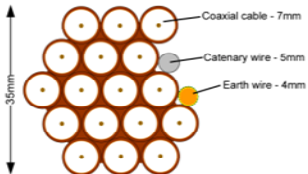

Typical loom for 16 coaxial cable + 1 earth wire, + 1 catenary wire

11. South Elevation



Form No. SCC 013 SCC International – 1 Fieldings Road, Cheshunt, Herts, EN8 9TL. Tel: 01992 642255. Website: www.scci.co.uk



Please consider the environment before printing this document – Recycle Wherever Possible



Drawing No.	E00029/00	Site Address:	1-17 & 29A-C Purchase Street, 1-19 Somers Close Estate, Camden, London, NW1 1RW	
Date:	14 th Oct 11	Site Ref:	LBC 0587.0	Surveyed By: Danny Varleigh
Number of Points:	26	System Type	9Wire IRS Sky Plus	Drawn By: James Schroder



Each property will have two cables to lounge position.

Cable Harness sizes

2-4 cables = 15mm

6-8 cables = 20mm


10-14 cables = 30mm

16-18 Cables = 35mm

20 cables = 40mm

40 cables = 65mm

60 cables = 90mm

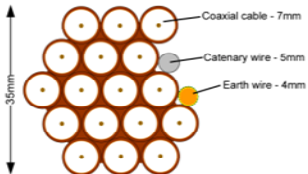

Typical loom for 16 coaxial cable + 1 earth wire, + 1 catenary wire

12. South West Elevation.

- Loom work from remote cabinet two on the corner wall of flat 28 in court yard brown PVC cables to exit the cabinet and run above ground floor above soldier brick course. To feed flats at rear wall of the building.
- 2 cables per flat at entry points.



Drawing No.	E00029/00	Site Address:	1-17 & 29A-C Purchase Street, 1-19 Somers Close Estate, Camden, London, NW1 1RW		
Date:	14 th Oct 11	Site Ref:	LBC 0587.0	Surveyed By:	Danny Varleigh
Number of Points:	26	System Type	9Wire IRS Sky Plus	Drawn By:	James Schroder



Each property will have two cables to lounge position.

Cable Harness sizes

2-4 cables = 15mm

6-8 cables = 20mm


10-14 cables = 30mm

16-18 Cables = 35mm

20 cables = 40mm

40 cables = 65mm

60 cables = 90mm

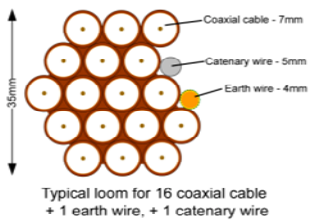

10. Existing Equipments

East Elevation



Roof Elevation



Form No. SCC 013 SCC International – 1 Fieldings Road, Cheshunt, Herts, EN8 9TL . Tel: 01992 642255. Website: www.scci.co.uk



Please consider the environment before printing this document – Recycle Wherever Possible




Drawing No.	E00029/00	Site Address:	1-17 & 29A-C Purchase Street, 1-19 Somers Close Estate, Camden, London, NW1 1RW		
Date:	14 th Oct 11	Site Ref:	LBC 0587.0	Surveyed By:	Danny Varleigh
Number of Points:	26	System Type	9Wire IRS Sky Plus	Drawn By:	James Schroder



14. Antenna and Dishes Measurements

Digital TV,
FM & DAB Radio
Aerials

Proposed location of UHF Aerial on a 4m pole and 80cm dishes mounted on 70.5cmx50cm L-arm on the corner wall of flat 23 in courtyard

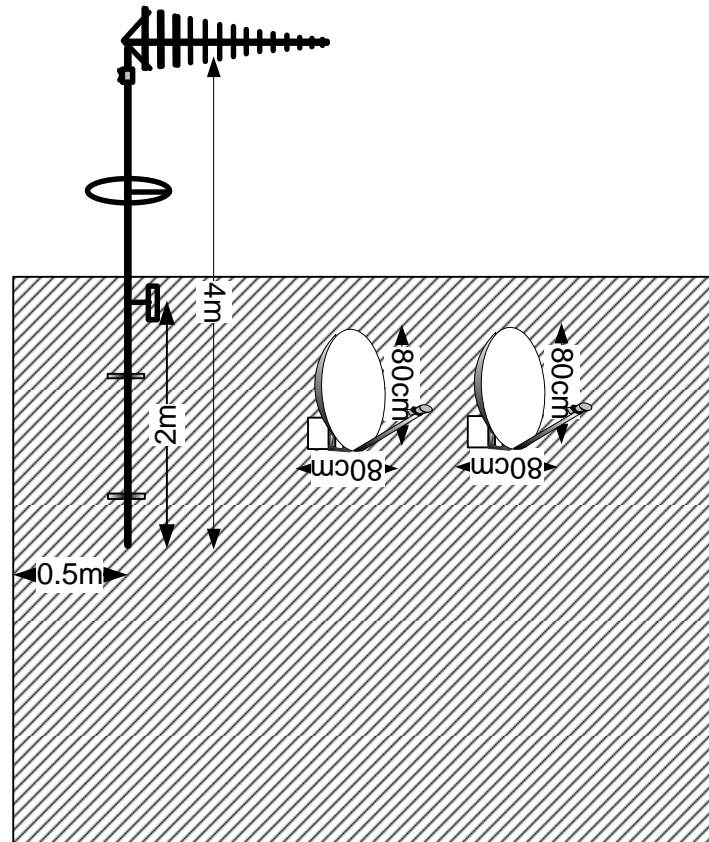

Form No. SCC 013 SCC International – 1 Fieldings Road, Cheshunt, Herts, EN8 9TL, . Tel: 01992 642255. Website: www.scci.co.uk



Please consider the environment before printing this document – Recycle Wherever Possible



Drawing No.	E00029/00	Site Address:	1-17 & 29A-C Purchase Street, 1-19 Somers Close Estate, Camden, London, NW1 1RW	
Date:	14 th Oct 11	Site Ref:	LBC 0587.0	Surveyed By: Danny Varleigh
Number of Points:	26	System Type	9Wire IRS Sky Plus	Drawn By: James Schroder

