

## 00. INDEX


| Drawing Number | Drawing Title                                     | Description  |
|----------------|---|--|
| E23005/00      | Index   | Index of Drawings.   |
| E23005/01      | Location Plan                                     | Scale 1:1250 at A4.  |
| E23005/02      | Block Plan  | Photo of Site from above.  |
| E23005/03      | Roof Plan   | Drawing of block from above, showing equipment positions.  |
| E23005/04      | South Elevation 1                                 | Description and location of the antenna and dishes + mounting and measurements and description and location of the Main cabinet size, colour + measurements. |
| E23005/05      | South Elevation 2                                 | Description of Cable routes, loom sizes and entry points.  |
| E23005/06      | South Elevation 3                                 | Description of Cable routes, loom sizes and entry points.  |
| E23005/07      | South Elevation 4                                 | Description of Cable routes, loom sizes and entry points.  |
| E23005/08      | Existing Equipments                               | Description, location and view of the existing equipment on site before install.   |
| E23005/09      | Antenna, Dish Sizes &<br>Typical Mounting Heights | Sketch of the Antenna and Dishes + mounting, position and height.  |

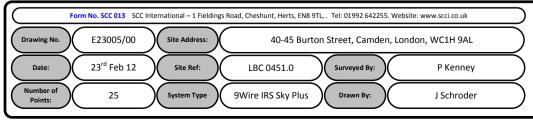



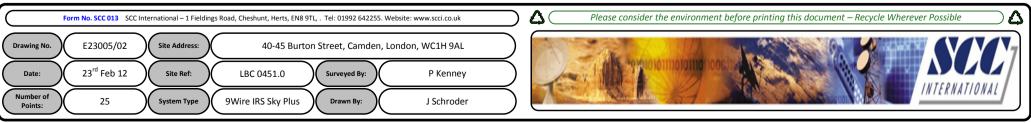



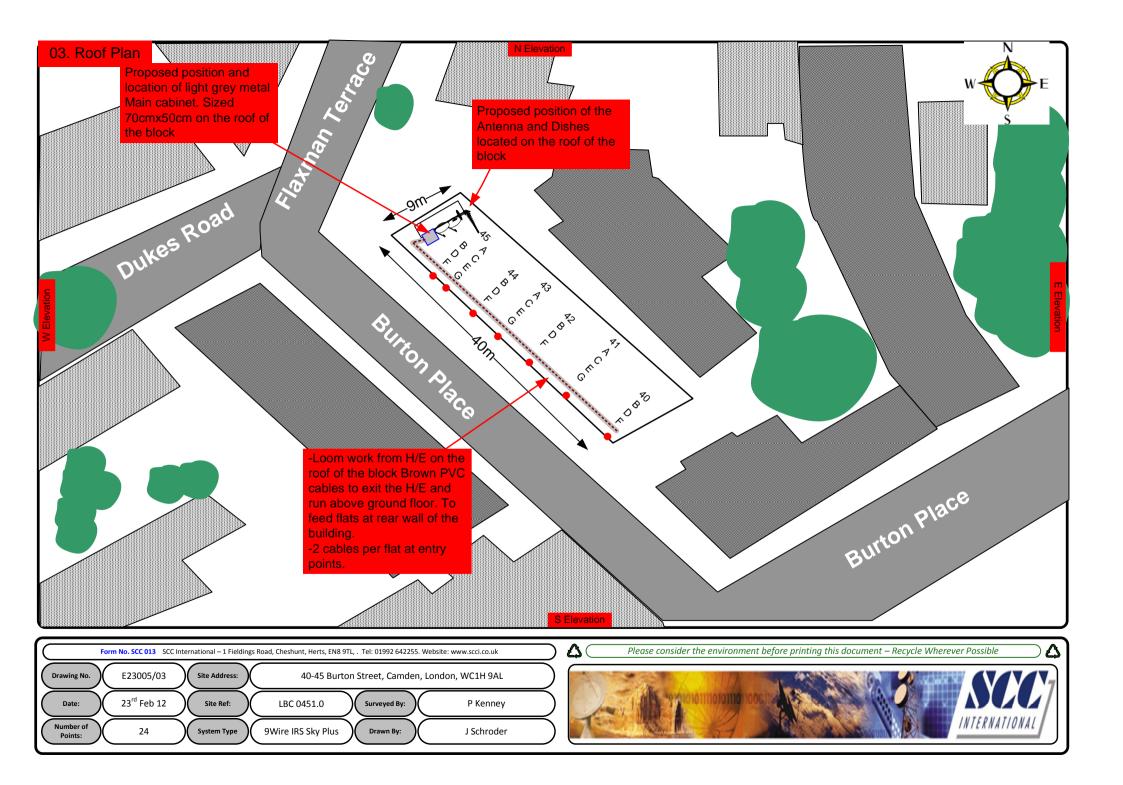

Cable Harness sizes

2-4 cables = 15mm

6-8 cables = 20mm


10-14 cables = 30mm

16-18 Cables = 35mm


20 cables = 40 mm


40 cables = 65 mm

60 cables = 90 mm

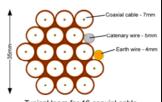

Typical loom for 16 coaxial cable + 1 earth wire, + 1 catenary wire

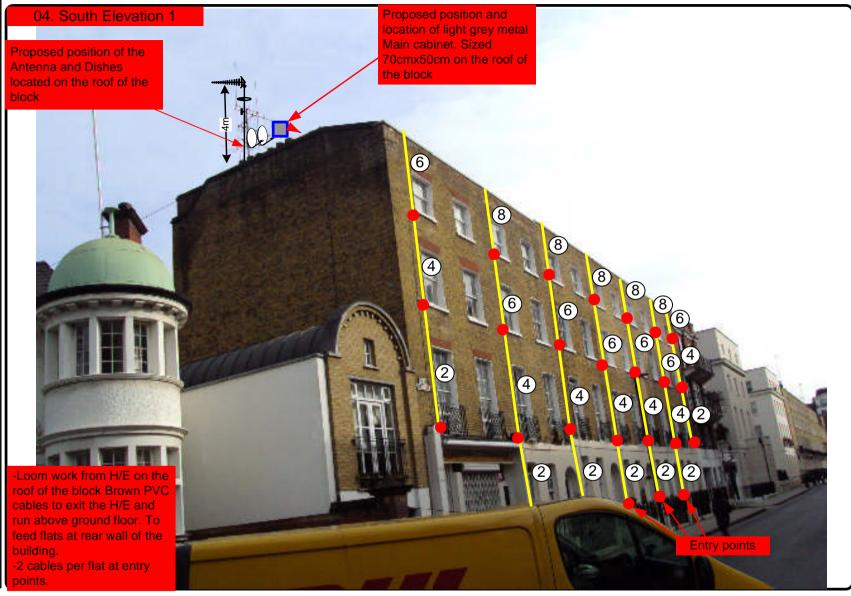

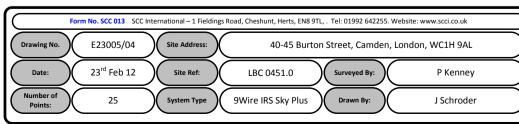



Cable Harness sizes

2-4 cables = 15mm

6-8 cables = 20mm


10-14 cables = 30mm

16-18 Cables = 35mm


20 cables = 40 mm

40 cables = 65 mm

60 cables = 90mm

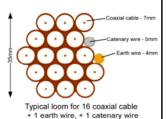



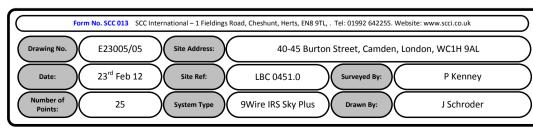



Cable Harness sizes

2-4 cables = 15mm

6-8 cables = 20mm


10-14 cables = 30mm

16-18 Cables = 35mm


20 cables = 40 mm

40 cables = 65 mm

60 cables = 90 mm

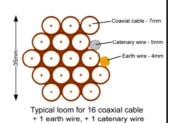



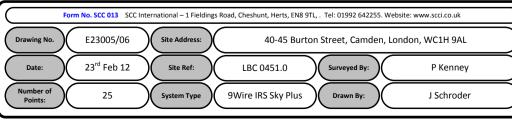



Cable Harness sizes

2-4 cables = 15mm

6-8 cables = 20mm


10-14 cables = 30mm

16-18 Cables = 35mm

20 cables = 40 mm


40 cables = 65 mm

60 cables = 90 mm

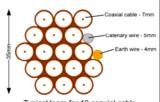

Typical loom for 16 coaxial cable + 1 earth wire, + 1 catenary wire



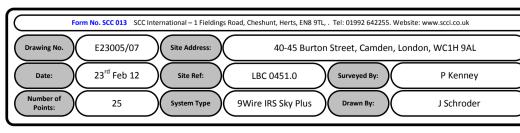



Cable Harness sizes

2-4 cables = 15mm

6-8 cables = 20mm


10-14 cables = 30mm

16-18 Cables = 35mm


20 cables = 40 mm

40 cables = 65mm

60 cables = 90mm

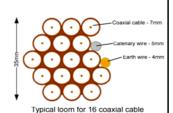



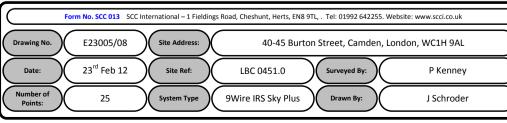



## 09. Antenna and Dishes Measurements

Digital TV, FM & DAB Radio Aerials

Proposed location of UHF Aerial on a 4m pole and 80cm dishes mounted on the roof of the block.

