

00. INDEX

Drawing Number	Drawing Title	Description
B13012/00	Index	Index of Drawings.
B13012/01	Location Plan	Scale 1:1250 at A4.
B13012/02	Roof Plan	Drawing of block from above, showing equipment positions.
B13012/03	Roof Elevation 1	Description and location of the antenna, dishes and Main Cabinet + mounting and measurements
B13012/04	Roof Elevation 2	Description of Cable routes, loom sizes and entry points
B13012/05	Internal View	Description of cables routes and trunking to entry points
B13012/06	Existing Equipments	Description, location and view of the existing equipment on site before install.
B13012/07	Antenna, Dish Sizes & Typical Mounting Heights	Sketch of the Antenna and Dishes + mounting, position and height.

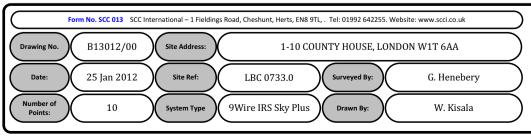

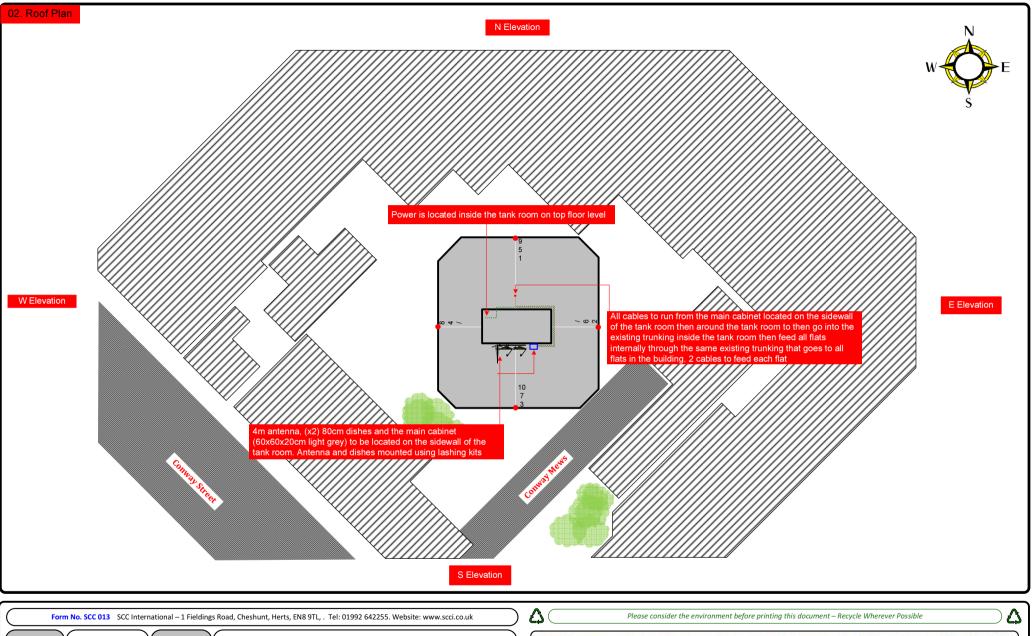







Cable Harness sizes

2-4 cables = 15mm

6-8 cables = 20mm


10-14 cables = 30mm

16-18 Cables = 35mm

20 cables = 40mm


40 cables = 65mm

60 cables = 90mm

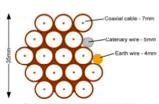

Typical loom for 16 coaxial cable + 1 earth wire, + 1 catenary wire



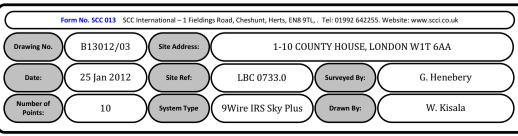



Cable Harness sizes

2-4 cables = 15mm

6-8 cables = 20mm


10-14 cables = 30mm

16-18 Cables = 35mm

20 cables = 40mm


40 cables = 65mm


60 cables = 90mm

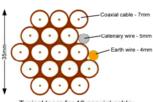

Typical loom for 16 coaxial cable + 1 earth wire, + 1 catenary wire

04. Roof Elevation 2

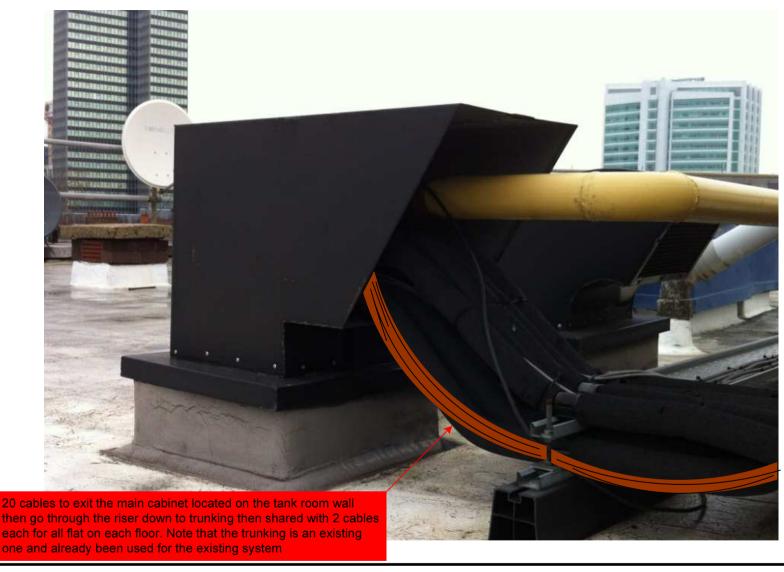

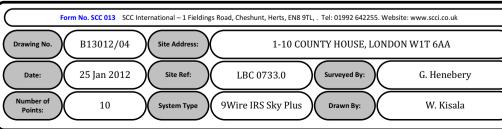



Cable Harness sizes

2-4 cables = 15mm

6-8 cables = 20mm


10-14 cables = 30mm

16-18 Cables = 35mm

20 cables = 40mm


40 cables = 65mm

60 cables = 90mm

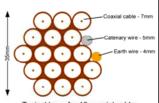

Typical loom for 16 coaxial cable + 1 earth wire, + 1 catenary wire



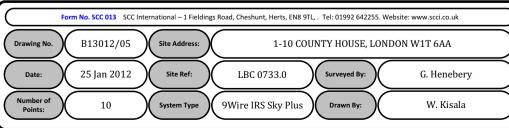



Cable Harness sizes

2-4 cables = 15mm

6-8 cables = 20mm


10-14 cables = 30mm

16-18 Cables = 35mm

20 cables = 40mm

40 cables = 65mm

60 cables = 90mm

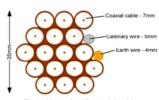


Number of

Points:



9Wire IRS Sky Plus

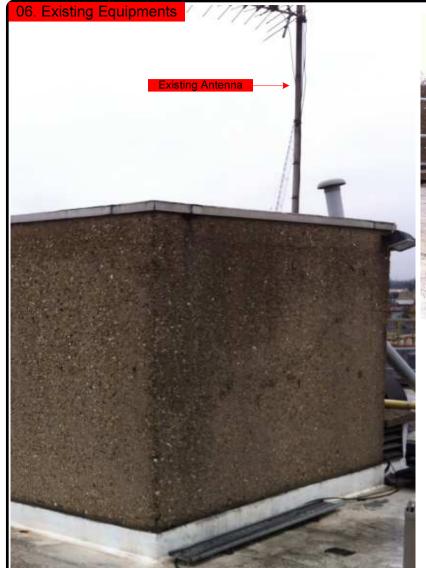

W. Kisala

