

00. INDEX

Drawing Number	Drawing Title	Description
B02060/00	Index	Index of Drawings.
B02060/01	Location Plan	Scale 1:1250 at A4.
B02060/02	Block Plan	Photo of Site from above.
B02060/03	Roof Plan	Drawing of block from above, showing equipment positions.
B02060/04	South & East Elevations	Description and location of the antenna, dishes and Main Cabinet
B02060/05	South Elevation 1	Description of Cable routes, loom sizes and entry points.
B02060/06	South elevation 2	Description of Cable routes, loom sizes and entry points.
B02060/07	South elevation 2	Description and location of the Main cabinet and remote cabinet size, colour + measurements.
B02060/08	Existing Equipments	View and location of existing equipment on site
B02060/09	Antenna, Dish Sizes & Typical Mounting Heights	Antenna and Dishes description, mounting, position, height and measurements.

Form No. SCC 013 SCC International – 1 Fieldings Road, Cheshunt, Herts, EN8 9TL . Tel: 01992 642255. Website: www.scci.co.uk




Please consider the environment before printing this document – Recycle Wherever Possible



Site Reference:	B02060/00	Site Address:	Flat 1-32, Broadfield Broadhurst Gardens, LONDON, NW6 3BP		
Date:	09/11/2011	Client:	LBC-0725.0	Surveyed By:	G.Henebery
Number of Points:	32	System Type	9-Wire	Drawn By:	W. Kisala



02. Block Plan

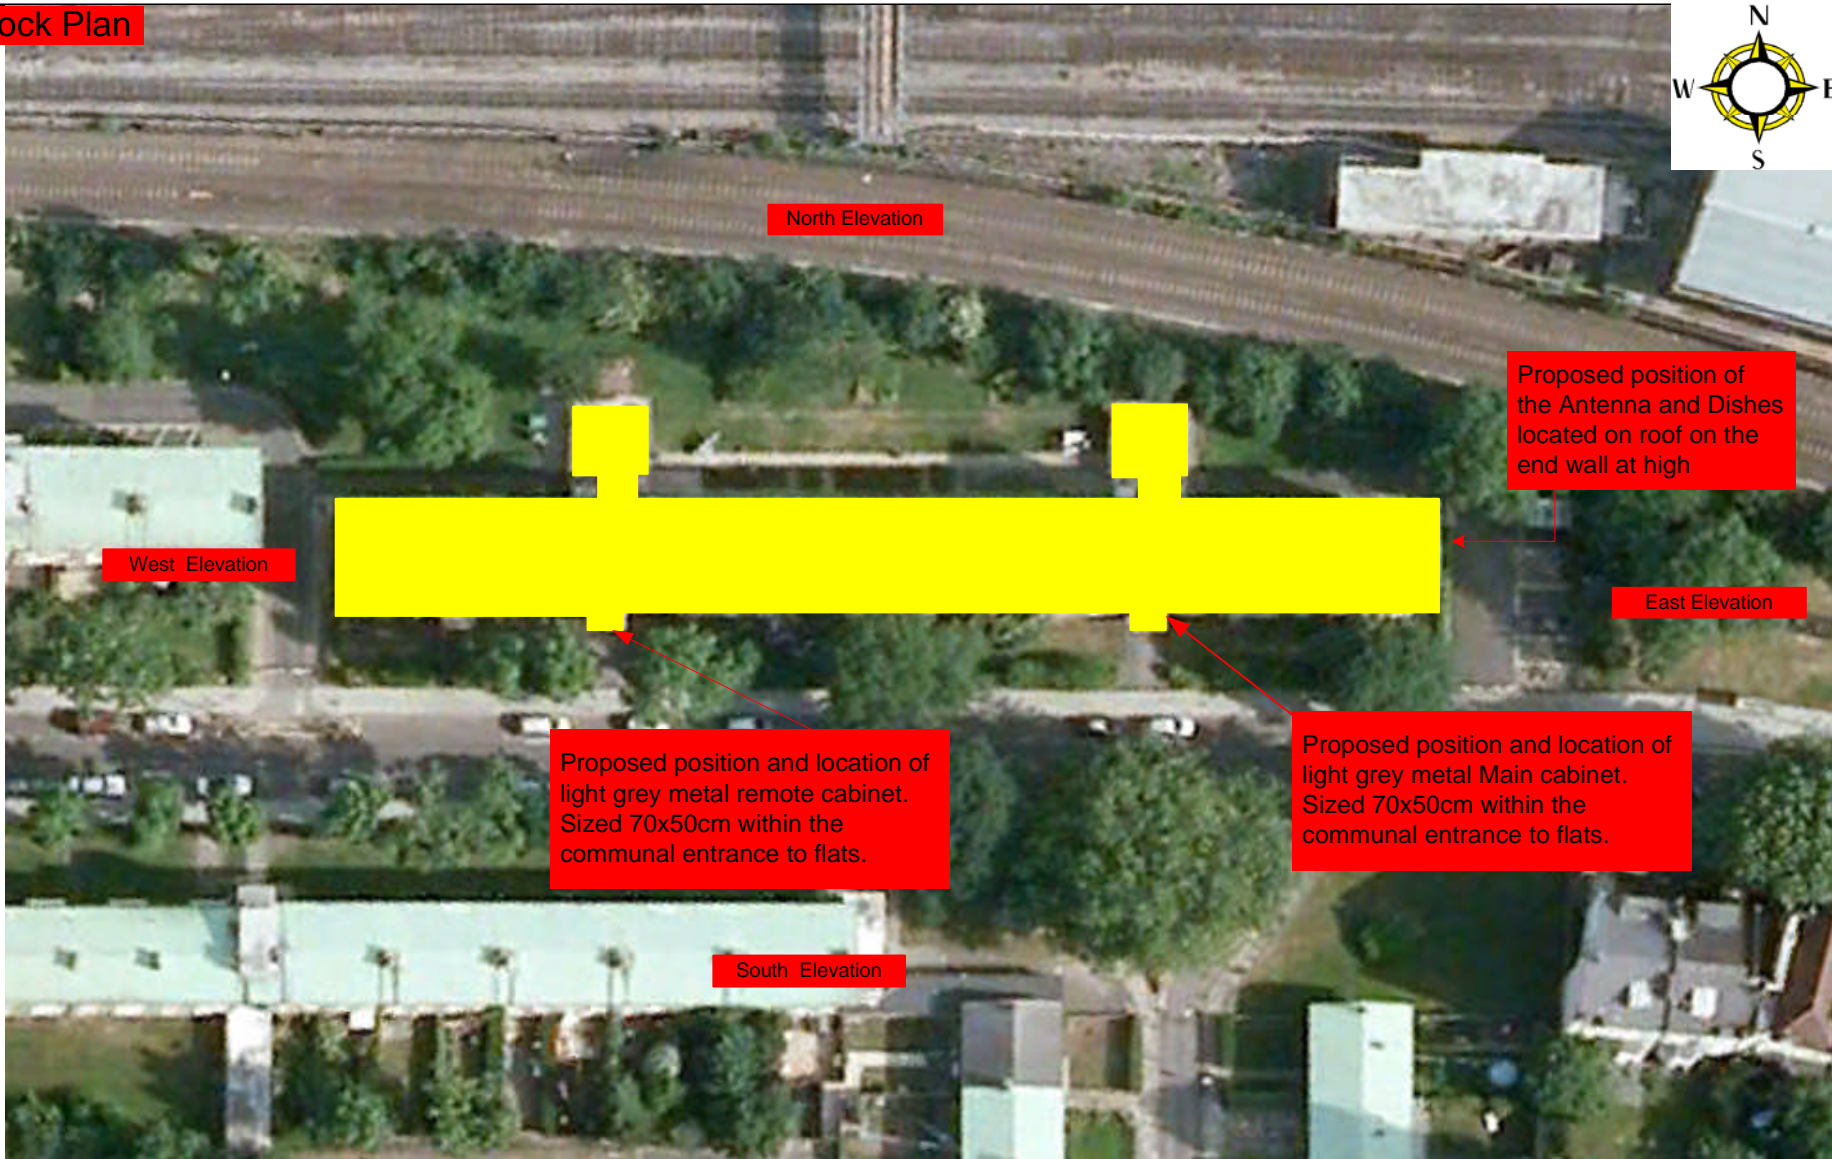

North Elevation

Proposed position of the Antenna and Dishes located on roof on the end wall at high

West Elevation

East Elevation


Proposed position and location of light grey metal remote cabinet. Sized 70x50cm within the communal entrance to flats.

Proposed position and location of light grey metal Main cabinet. Sized 70x50cm within the communal entrance to flats.

South Elevation

Form No. SCC 013 SCC International – 1 Fieldings Road, Cheshunt, Herts, EN8 9TL, . Tel: 01992 642255. Website: www.scci.co.uk						Please consider the environment before printing this document – Recycle Wherever Possible					
Site Reference:	B02060/02	Site Address:	Flat 1-32, Broadfield Broadhurst Gardens, LONDON, NW6 3BP								
Date:	09/11/2011	Client:	LBC-0725.0	Surveyed By:	G.Henebery						
Number of Points:	32	System Type:	9-Wire	Drawn By:	W. Kisala						

03. Roof Plan

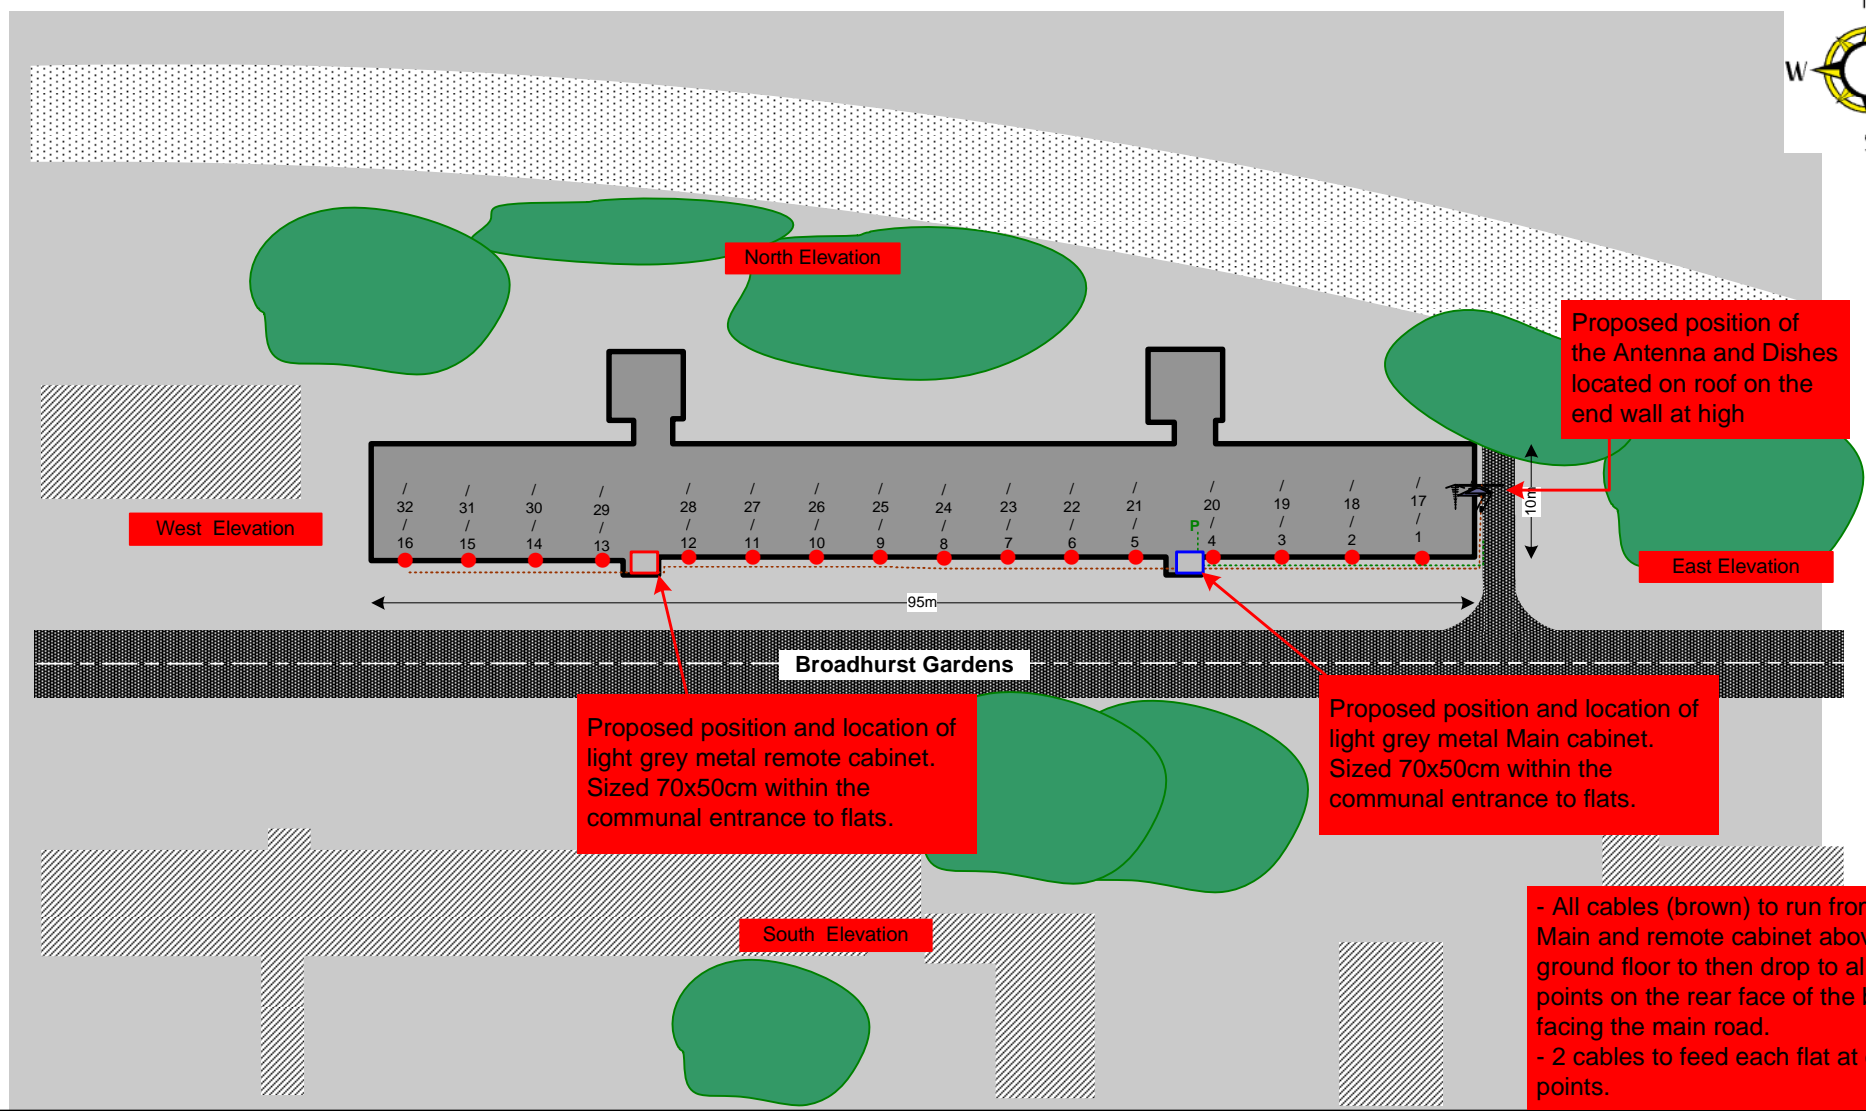

Form No. SCC 013 SCC International – 1 Fieldings Road, Cheshunt, Herts, EN8 9TL, . Tel: 01992 642255. Website: www.scci.co.uk						Please consider the environment before printing this document – Recycle Wherever Possible					
Site Reference:	B02060/03	Site Address:	Flat 1-32, Broadfield Broadhurst Gardens, LONDON, NW6 3BP								
Date:	09/11/2011	Client:	LBC-0725.0	Surveyed By:	G.Henebery						
Number of Points:	32	System Type	9-Wire	Drawn By:	W. Kisala						

Each property will have two cables to lounge position.

Cable Harness sizes

2-4 cables = 15mm

6-8 cables = 20mm


10-14 cables = 30mm

16-18 Cables = 35mm

20 cables = 40mm

40 cables = 65mm

60 cables = 90mm

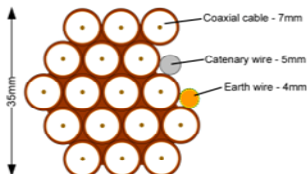

Typical loom for 16 coaxial cable + 1 earth wire, + 1 catenary wire

04. South & East Elevation



Proposed location of UHF Aerial on a 4m pole mounted using wall bracket and 80cm dishes mounted using lashing kits. all installed on the end wall at high

- All cables (brown) to run from the Main and remote cabinet above ground floor to then drop to all lounge points on the rear face of the block facing the main road.
- 2 cables to feed each flat at entry points.

Form No. SCC 013 SCC International – 1 Fieldings Road, Cheshunt, Herts, EN8 9TL, . Tel: 01992 642255. Website: www.scci.co.uk

Please consider the environment before printing this document – Recycle Wherever Possible


Site Reference:	B02060/04	Site Address:	Flat 1-32, Broadfield Broadhurst Gardens, LONDON, NW6 3BP		
Date:	09/11/2011	Client:	LBC-0725.0	Surveyed By:	G.Henebery
Number of Points:	32	System Type:	9-Wire	Drawn By:	W. Kisala



Each property will have two cables to lounge position.

Cable Harness sizes

- 2-4 cables = 15mm
- 6-8 cables = 20mm
- 10-14 cables = 30mm
- 16-18 Cables = 35mm
- 20 cables = 40mm
- 40 cables = 65mm
- 60 cables = 90mm

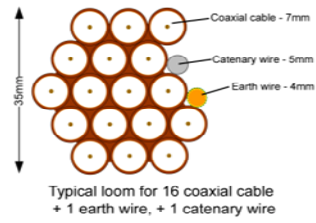

05. South Elevation 1

- All cables (brown) to run from the Main and remote cabinet above ground floor to then drop to all lounge points on the rear face of the block facing the main road.
 - 2 cables to feed each flat at entry points.



Form No. SCC 013 SCC International – 1 Fieldings Road, Cheshunt, Herts, EN8 9TL, . Tel: 01992 642255. Website: www.scci.co.uk						Please consider the environment before printing this document – Recycle Wherever Possible					
Site Reference:	B02060/05	Site Address:	Flat 1-32, Broadfield Broadhurst Gardens, LONDON, NW6 3BP								
Date:	09/11/2011	Client:	LBC-0725.0	Surveyed By:	G.Henebery						
Number of Points:	32	System Type:	9-Wire	Drawn By:	W. Kisala						

Each property will have two cables to lounge position.

Cable Harness sizes

2-4 cables = 15mm

6-8 cables = 20mm


10-14 cables = 30mm

16-18 Cables = 35mm


20 cables = 40mm

40 cables = 65mm

60 cables = 90mm

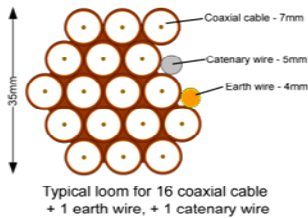

06. South Elevation 2

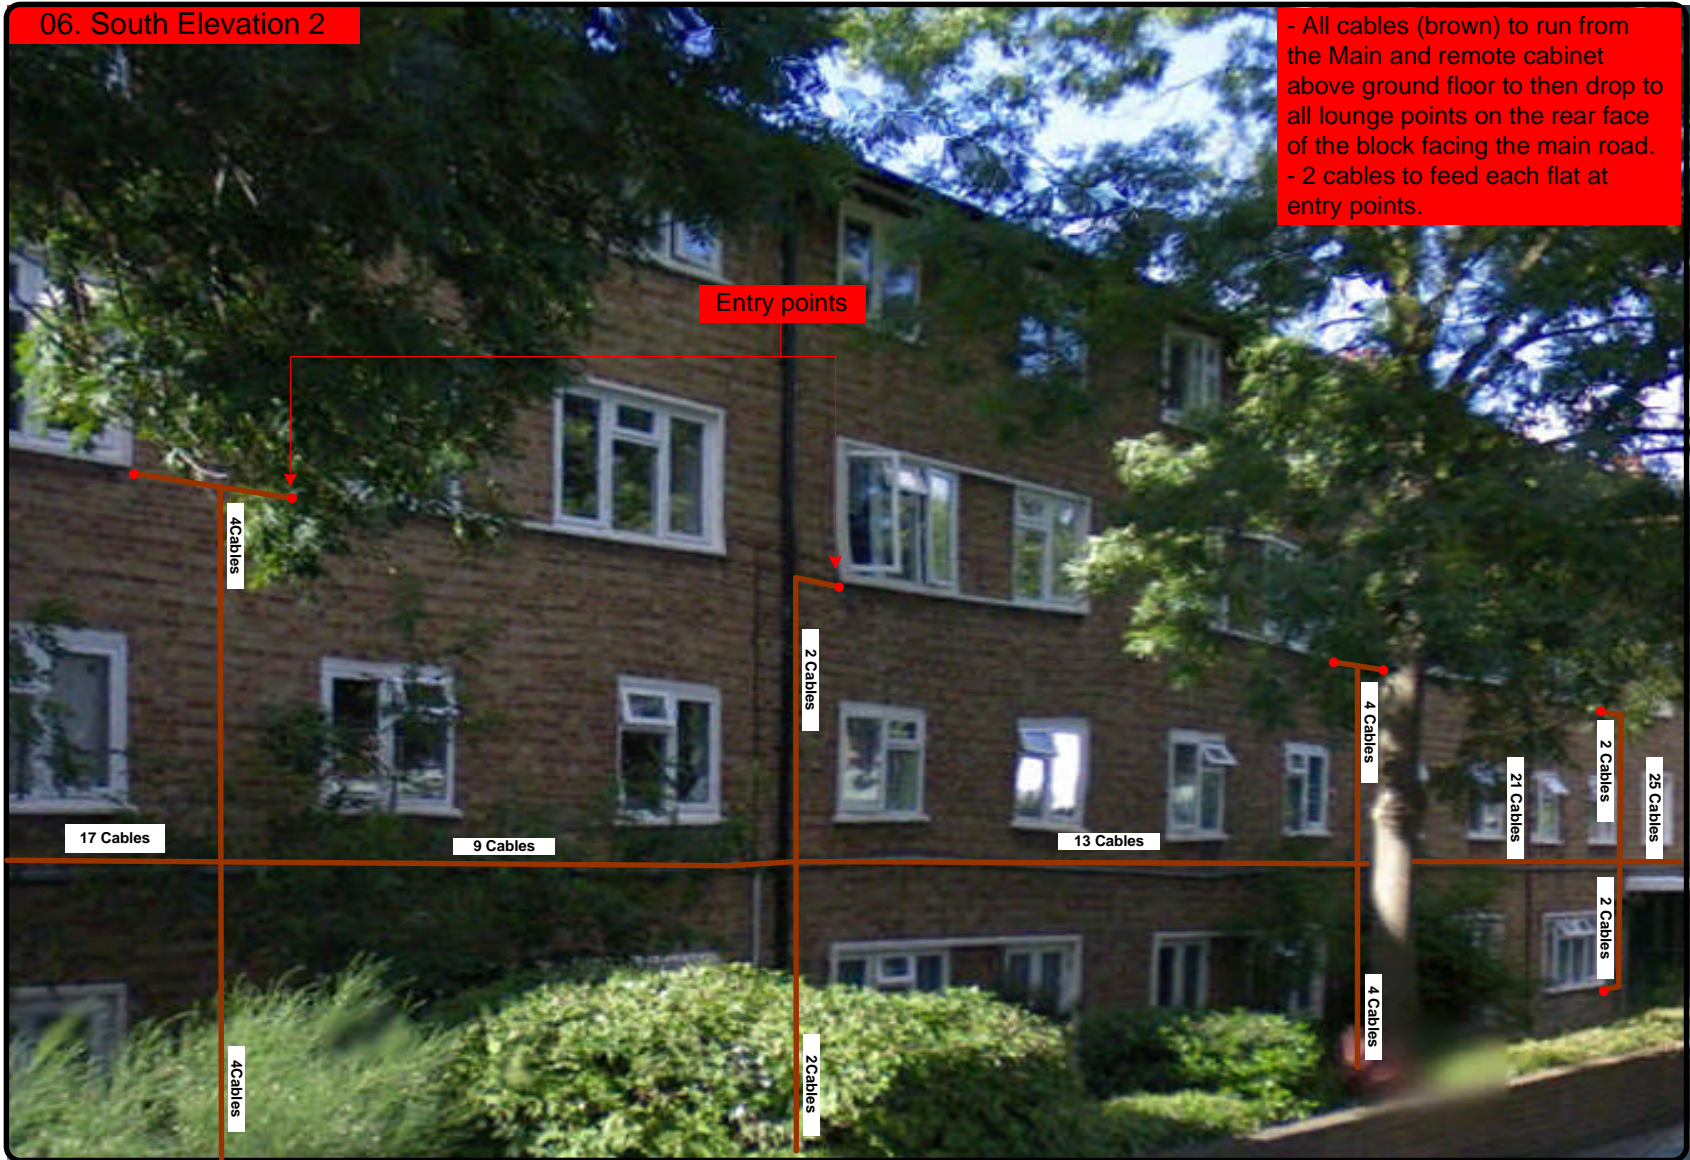

- All cables (brown) to run from the Main and remote cabinet above ground floor to then drop to all lounge points on the rear face of the block facing the main road.
 - 2 cables to feed each flat at entry points.

Form No. SCC 013 SCC International – 1 Fieldings Road, Cheshunt, Herts, EN8 9TL, . Tel: 01992 642255. Website: www.scci.co.uk

Please consider the environment before printing this document – Recycle Wherever Possible

Site Reference:	B02060/06	Site Address:	Flat 1-32, Broadfield Broadhurst Gardens, LONDON, NW6 3BP		
Date:	09/11/2011	Client:	LBC-0725.0	Surveyed By:	G.Henebery
Number of Points:	32	System Type	9-Wire	Drawn By:	W. Kisala



Each property will have two cables to lounge position.

Cable Harness sizes

2-4 cables = 15mm

6-8 cables = 20mm


10-14 cables = 30mm

16-18 Cables = 35mm


20 cables = 40mm

40 cables = 65mm

60 cables = 90mm

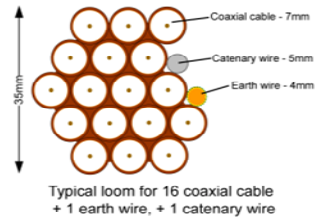


07. South Elevation 3

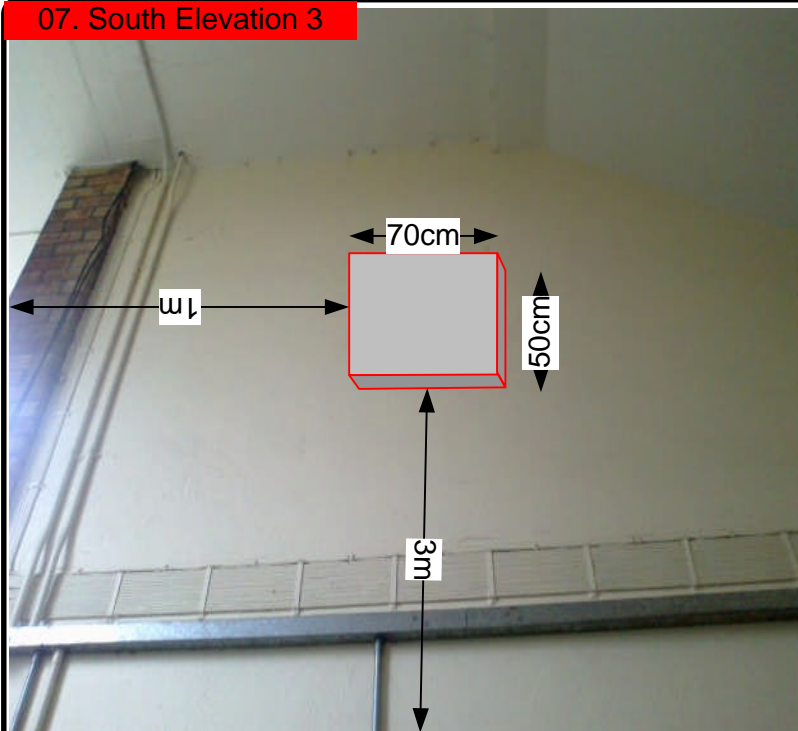

Proposed position and location of light grey metal main cabinet. Sized 70x50cm on the sidewall of flat 1.


Proposed position and location of light grey metal remote cabinet. Sized 70x50cm within the communal entrance to flats.

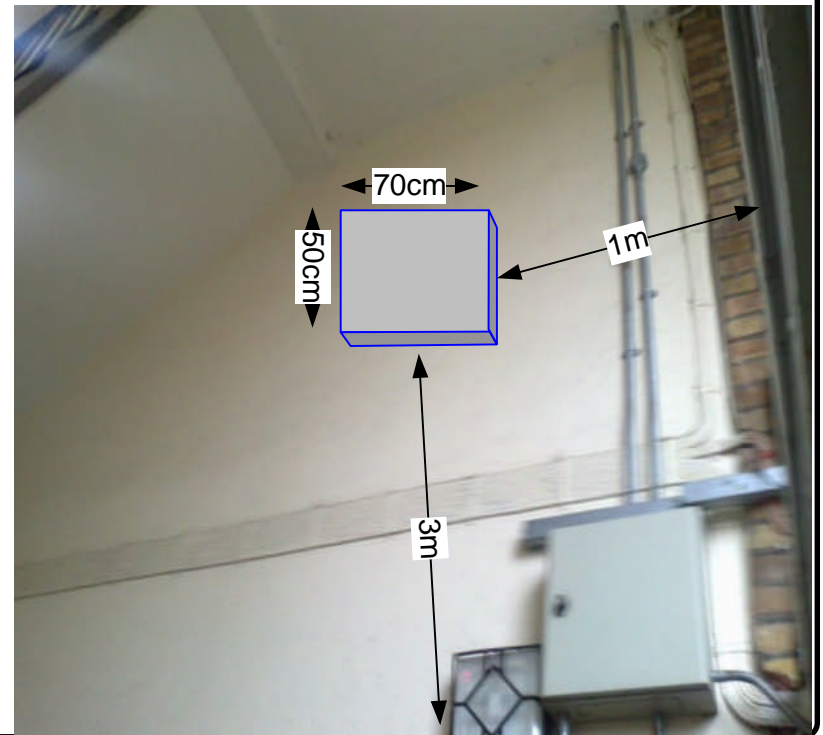

Form No. SCC 013 SCC International – 1 Fieldings Road, Cheshunt, Herts, EN8 9TL, . Tel: 01992 642255. Website: www.scci.co.uk

Please consider the environment before printing this document – Recycle Wherever Possible

Site Reference:	B02060/07	Site Address:	Flat 1-32, Broadfield Broadhurst Gardens, LONDON, NW6 3BP		
Date:	09/11/2011	Client:	LBC-0725.0	Surveyed By:	G.Henebery
Number of Points:	32	System Type:	9-Wire	Drawn By:	W. Kisala

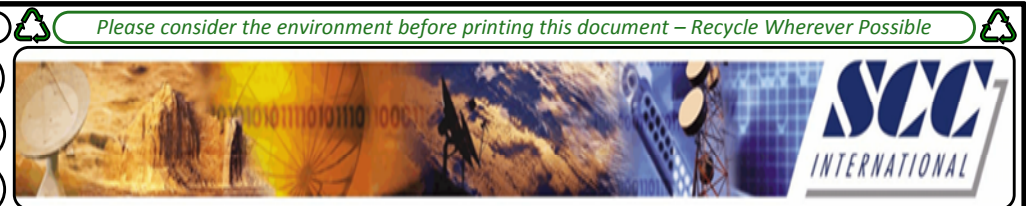

Each property will have two cables to lounge position.

Cable Harness sizes

2-4 cables = 15mm

6-8 cables = 20mm


10-14 cables = 30mm

16-18 Cables = 35mm

20 cables = 40mm

40 cables = 65mm

60 cables = 90mm

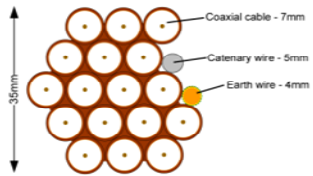

Typical loom for 16 coaxial cable + 1 earth wire, + 1 catenary wire

08. Existing Equipments



Form No. SCC 013 SCC International – 1 Fieldings Road, Cheshunt, Herts, EN8 9TL, . Tel: 01992 642255. Website: www.scci.co.uk

Please consider the environment before printing this document – Recycle Wherever Possible


Site Reference:	B02060/08	Site Address:	Flat 1-32, Broadfield Broadhurst Gardens, LONDON, NW6 3BP		
Date:	09/11/2011	Client:	LBC-0725.0	Surveyed By:	G.Henebery
Number of Points:	32	System Type	9-Wire	Drawn By:	W. Kisala



09. Antenna and Dishes Measurements

Proposed location of UHF Aerial on a 4m pole mounted using wall bracket and 80cm dishes mounted using lashing kits. all installed on the end wall at high

Digital TV,
FM & DAB Radio
Aerials

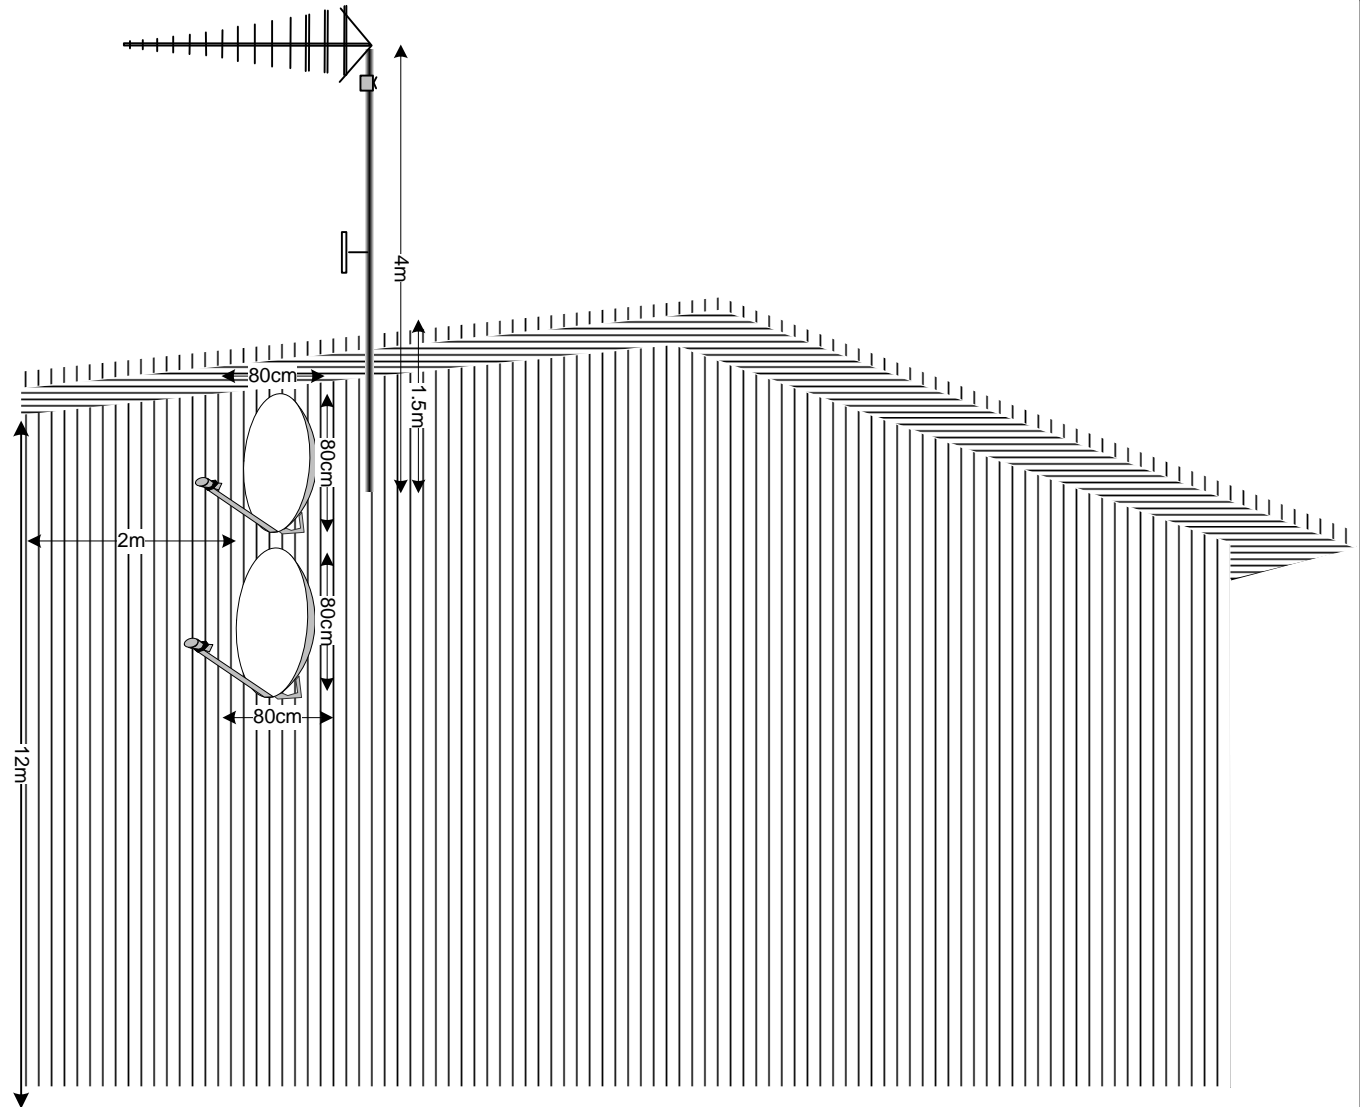

Form No. SCC 013 SCC International – 1 Fieldings Road, Cheshunt, Herts, EN8 9TL, . Tel: 01992 642255. Website: www.scci.co.uk



Please consider the environment before printing this document – Recycle Wherever Possible



Site Reference:	B02060/09	Site Address:	Flat 1-32, Broadfield Broadhurst Gardens, LONDON, NW6 3BP		
Date:	09/11/2011	Client:	LBC-0725.0	Surveyed By:	G.Henebery
Number of Points:	32	System Type:	9-Wire	Drawn By:	W. Kisala

