

00. INDEX

Drawing Number	Drawing Title	Description
E43224,E02014/00	Index	Index of Drawings.
E43224,E02014/01	Location Plan	Scale 1:1250 at A4.
E43224,E02014/02	Block Plan	Photo of Site from above.
E43224,E02014/03	Roof Plan	Drawing of block from above, showing equipment positions.
E43224,E02014/04	East Elevation 1	Description and location of the antenna and dishes + mounting and measurements.
E43224,E02014/05	East Elevation 2	Description of Cable routes, loom sizes and entry points and description and location of the Main cabinet size, colour + measurements.
E43224,E02014/06	West Elevation 1	Description of Cable routes, loom sizes and entry points.
E43224,E02014/07	West Elevation 2	Description of Cable routes, loom sizes and entry points.
E43224,E02014/08	Existing Equipments	Description, location and view of the existing equipment on site before install.
E43224,E02014/09	Antenna, Dish Sizes & Typical Mounting Heights	Sketch of the Antenna and Dishes + mounting, position and height.

Form No. SCC 013 SCC International – 1 Fieldings Road, Cheshunt, Herts, EN8 9TL, . Tel: 01992 642255. Website: www.scci.co.uk

Drawing No.	E43224,E02014/00	Site Address:	31-31a Daleham Gardens, London, NW3 5BU	
Date:	27 th Jan 12	Site Ref:	LBC0315.0	Surveyed By: Paul Kenney
Number of Points:	18	System Type	9Wire IRS Sky Plus	Drawn By: James Schroder



Please consider the environment before printing this document – Recycle Wherever Possible



02. Block Plan



Form No. SCC 013 SCC International – 1 Fieldings Road, Cheshunt, Herts, EN8 9TL, . Tel: 01992 642255. Website: www.scci.co.uk




Please consider the environment before printing this document – Recycle Wherever Possible



Drawing No.	E43224,E02014/02	Site Address:	31-31a Daleham Gardens, London, NW3 5BU	
Date:	27 th Jan 12	Site Ref:	LBC0315.0	Surveyed By:
Number of Points:	18	System Type	9Wire IRS Sky Plus	Drawn By:
				Paul Kenney
				James Schroder



03. Roof Plan

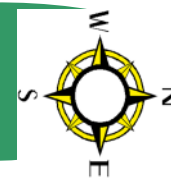

W Elevation

N Elevation

S Elevation

E Elevation

Daleham Gardens

-Loom work from H/E on the front of the block to run in Brown PVC cables above 1st floor. To feed flats at front, rear and sides of the building. Cat to connect buildings
-2 cables per flat at entry points.

Proposed position and location of light grey metal Main cabinet. Sized 70cmx50cm on the front of the building

Proposed position of the Antenna and Dishes located at front of the building at high level.

Form No. SCC 013 SCC International – 1 Fieldings Road, Cheshunt, Herts, EN8 9TL, . Tel: 01992 642255. Website: www.scci.co.uk

Drawing No.	E43224,E02014/03	Site Address:	31-31a Daleham Gardens, London, NW3 5BU
Date:	27 th Jan 12	Site Ref:	LBC0315.0
Number of Points:	18	System Type	9Wire IRS Sky Plus
		Surveyed By:	Paul Kenney
		Drawn By:	James Schroder



Please consider the environment before printing this document – Recycle Wherever Possible



Each property will have two cables to lounge position.

Cable Harness sizes

2-4 cables = 15mm

6-8 cables = 20mm


10-14 cables = 30mm

16-18 Cables = 35mm

20 cables = 40mm


40 cables = 65mm

60 cables = 90mm

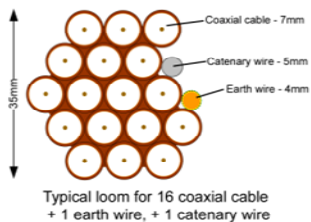

04. East Elevation 1.

Proposed position of the Antenna and Dishes located at front of the building at high level this is the only place it can go due to line of sight

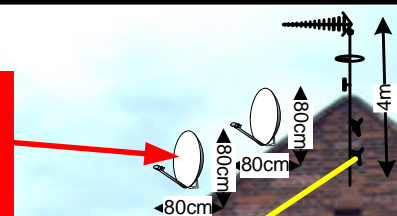

-Loom work from H/E on the front of the block to run in Brown PVC cables above 1st floor. To feed flats at front, rear and sides of the building. Cat to connect buildings
-2 cables per flat at entry points.

3m Cat wire

Entry points

9 Cables

2 Cables

16 Cables

16 Cables

4 Cables

2 Cables


Form No. SCC 013 SCC International – 1 Fieldings Road, Cheshunt, Herts, EN8 9TL, . Tel: 01992 642255. Website: www.scci.co.uk



Please consider the environment before printing this document – Recycle Wherever Possible



Drawing No.	E43224,E02014/04	Site Address:	31-31a Daleham Gardens, London, NW3 5BU
Date:	27 th Jan 12	Site Ref:	LBC0315.0
Number of Points:	18	System Type	9Wire IRS Sky Plus
		Surveyed By:	Paul Kenney
		Drawn By:	James Schroder

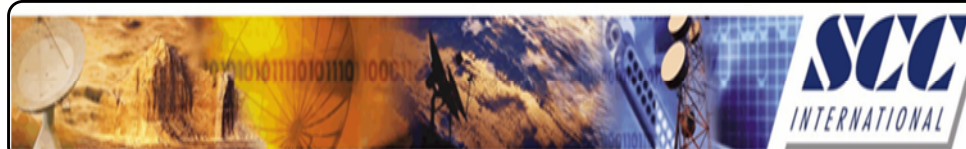

Each property will have two cables to lounge position.

Cable Harness sizes

2-4 cables = 15mm

6-8 cables = 20mm


10-14 cables = 30mm

16-18 Cables = 35mm


20 cables = 40mm

40 cables = 65mm

60 cables = 90mm

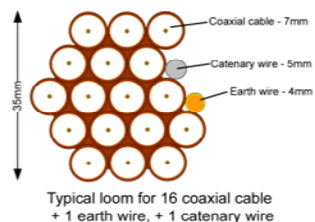

05. East Elevation 2

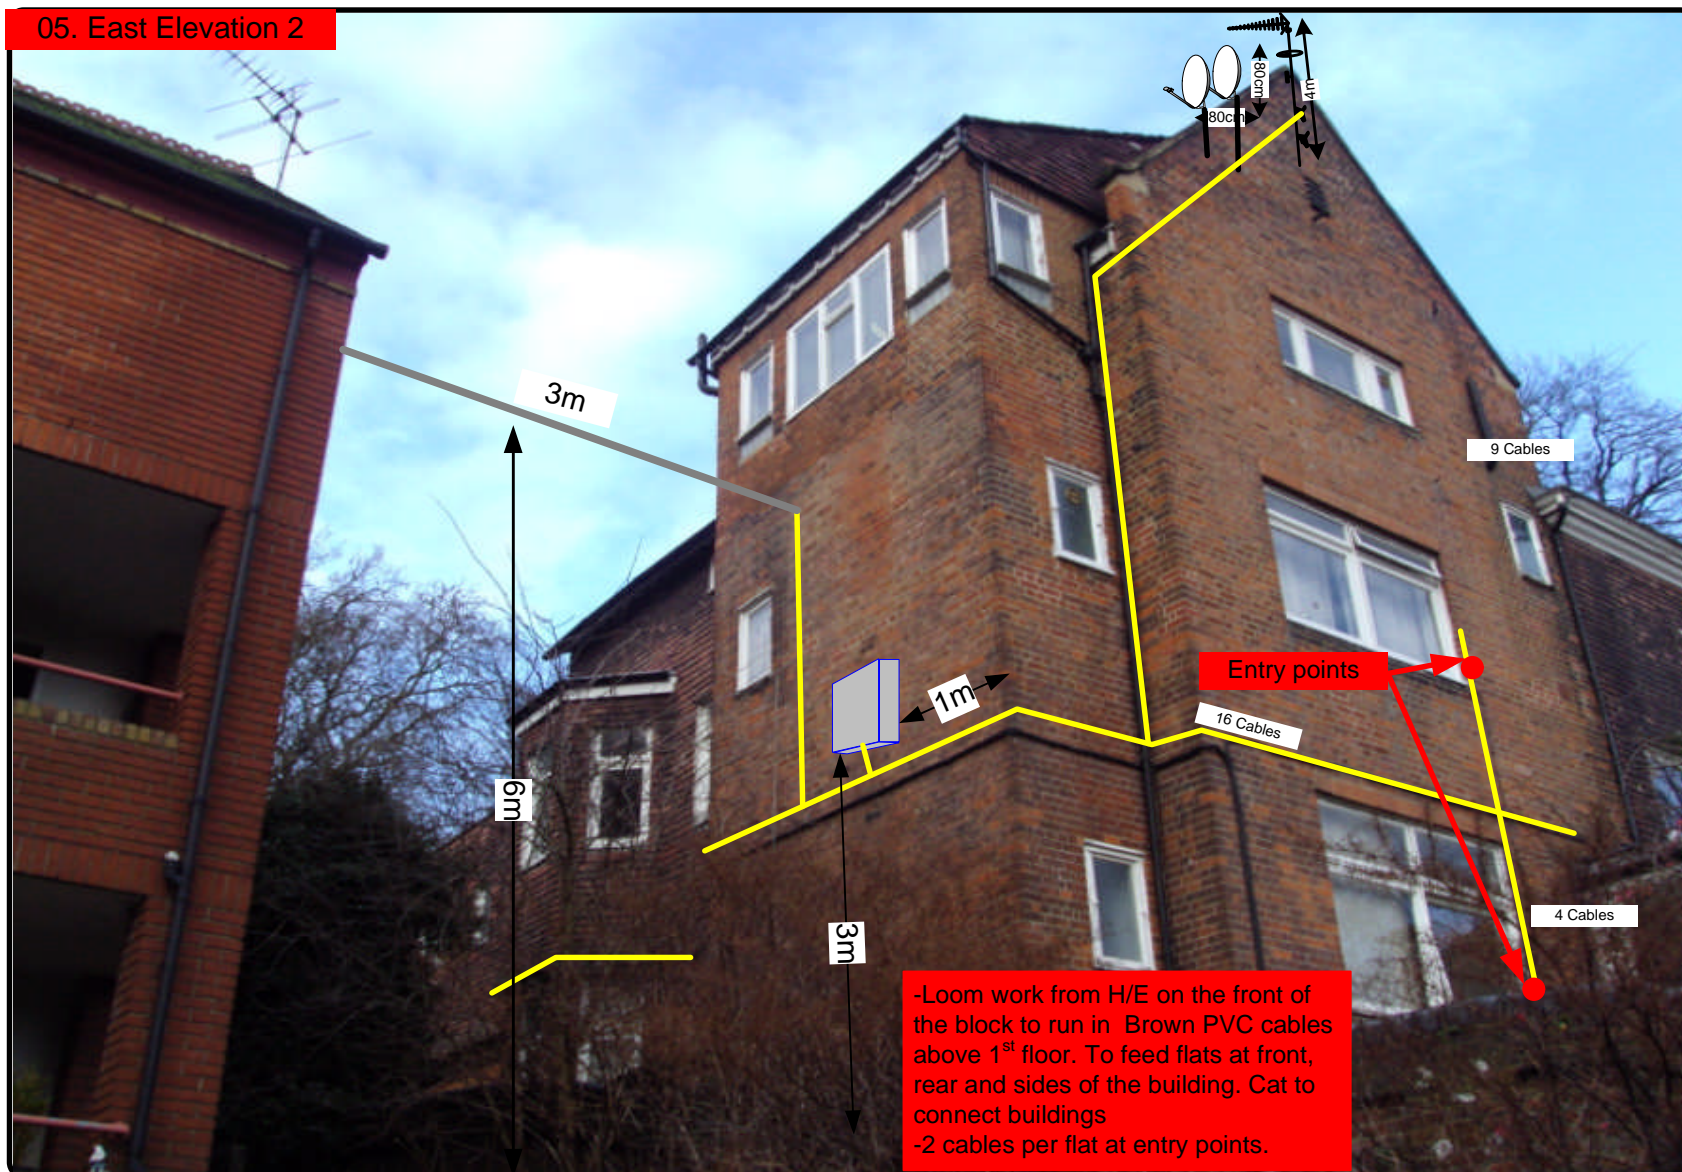

Form No. SCC 013 SCC International – 1 Fieldings Road, Cheshunt, Herts, EN8 9TL, . Tel: 01992 642255. Website: www.scci.co.uk



Please consider the environment before printing this document – Recycle Wherever Possible



Drawing No.	E43224,E02014/05	Site Address:	31-31a Daleham Gardens, London, NW3 5BU
Date:	27 th Jan 12	Site Ref:	LBC0315.0
Number of Points:	18	System Type	9Wire IRS Sky Plus
		Surveyed By:	Paul Kenney
		Drawn By:	James Schroder



Each property will have two cables to lounge position.

Cable Harness sizes

2-4 cables = 15mm

6-8 cables = 20mm


10-14 cables = 30mm

16-18 Cables = 35mm

20 cables = 40mm

40 cables = 65mm

60 cables = 90mm

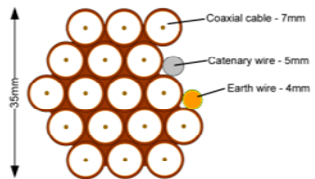

06. West Elevation 1

31a Daleham Gardens

-Loom work from H/E on the front of the block to run in Brown PVC cables above 1st floor. To feed flats at front, rear and sides of the building. Cat to connect buildings

-2 cables per flat at entry points.



Form No. SCC 013 SCC International – 1 Fieldings Road, Cheshunt, Herts, EN8 9TL. - Tel: 01992 642255. Website: www.scci.co.uk

Drawing No.	E43224,E02014/06	Site Address:	31-31a Daleham Gardens, London, NW3 5BU
Date:	27 th Jan 12	Site Ref:	LBC0315.0
Number of Points:	18	System Type	9Wire IRS Sky Plus
		Surveyed By:	Paul Kenney
		Drawn By:	James Schroder



Please consider the environment before printing this document – Recycle Wherever Possible



Each property will have two cables to lounge position.

Cable Harness sizes

2-4 cables = 15mm

6-8 cables = 20mm


10-14 cables = 30mm

16-18 Cables = 35mm

20 cables = 40mm

40 cables = 65mm


60 cables = 90mm

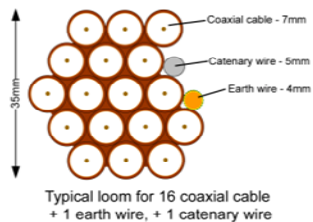

07. West Elevation 2

31 Daleham Gardens

-Loom work from H/E on the front of the block to run in Brown PVC cables above 1st floor. To feed flats at front, rear and sides of the building. Cat to connect buildings
-2 cables per flat at entry points.

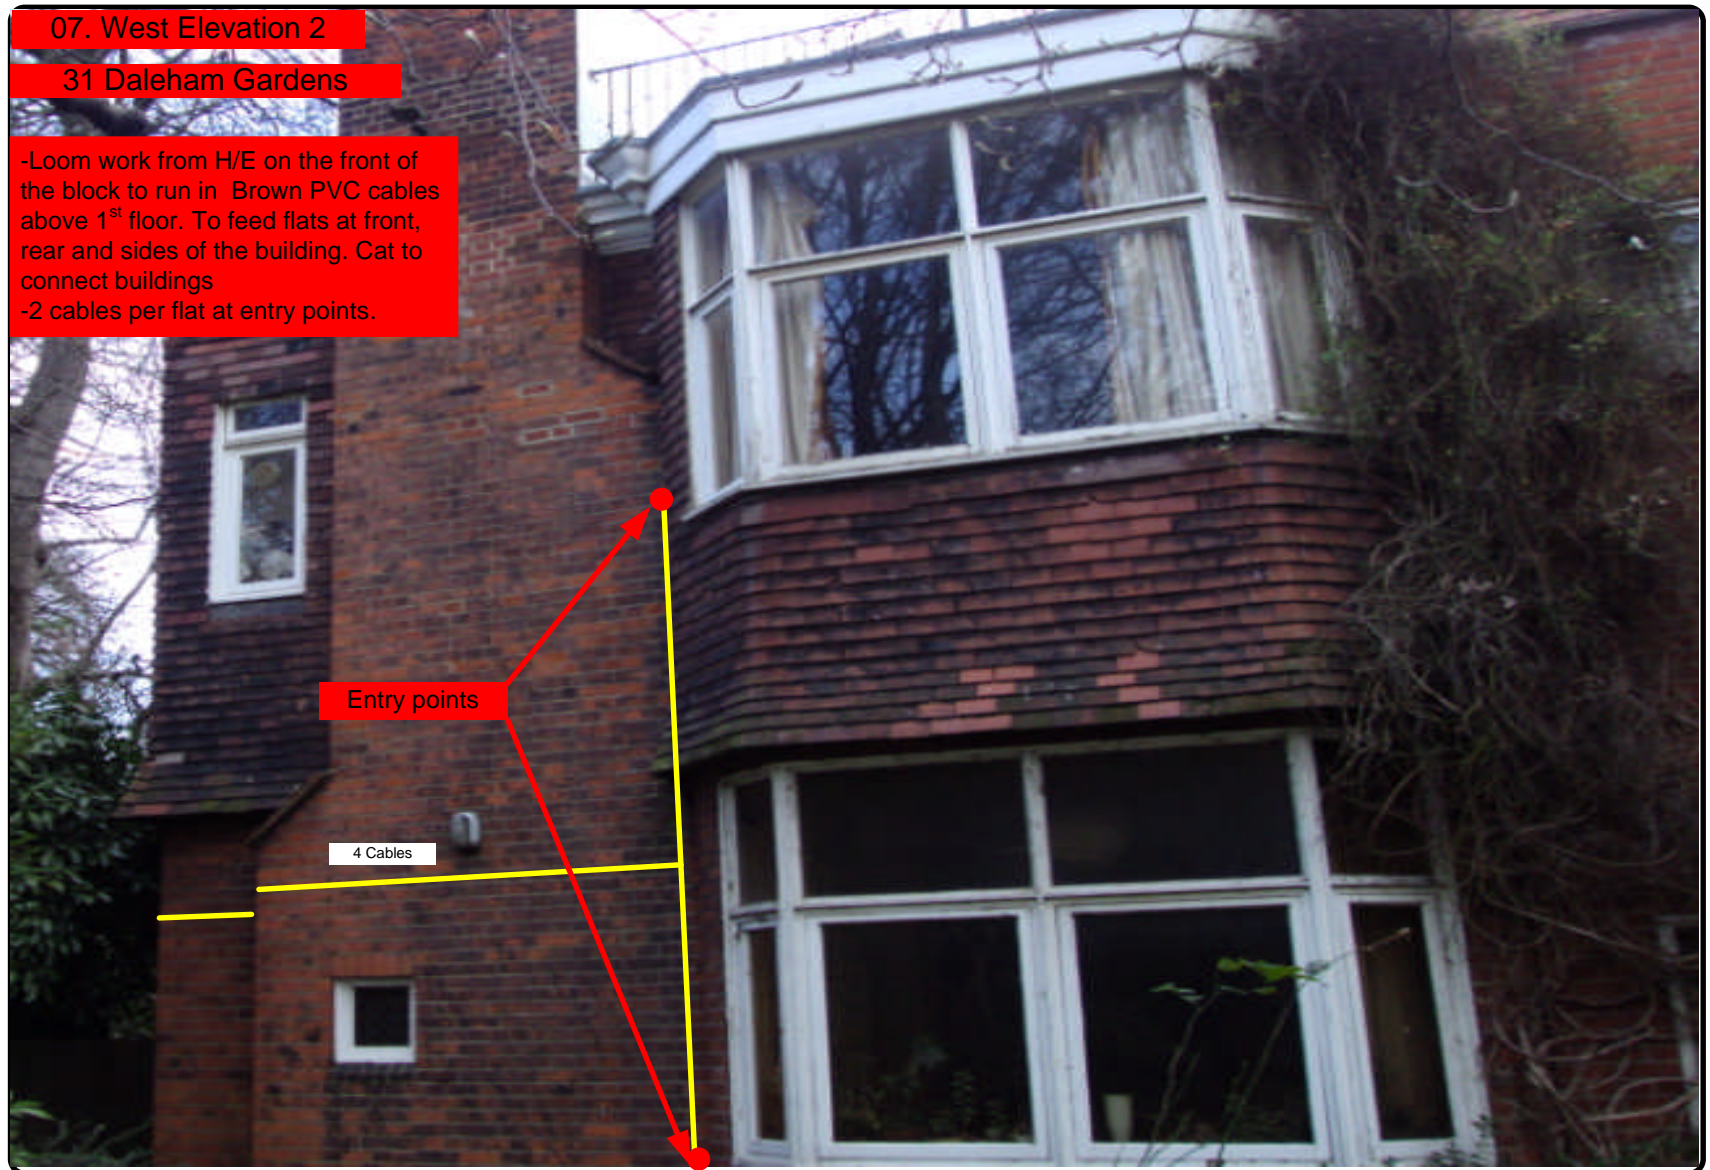

Form No. SCC 013 SCC International – 1 Fieldings Road, Cheshunt, Herts, EN8 9TL, . Tel: 01992 642255. Website: www.scci.co.uk



Please consider the environment before printing this document – Recycle Wherever Possible



Drawing No.	E43224,E02014/07	Site Address:	31-31a Daleham Gardens, London, NW3 5BU
Date:	27 th Jan 12	Site Ref:	LBC0315.0
Number of Points:	18	System Type	9Wire IRS Sky Plus
		Surveyed By:	Paul Kenney
		Drawn By:	James Schroder



Each property will have two cables to lounge position.

Cable Harness sizes

2-4 cables = 15mm

6-8 cables = 20mm


10-14 cables = 30mm

16-18 Cables = 35mm

20 cables = 40mm

40 cables = 65mm

60 cables = 90mm

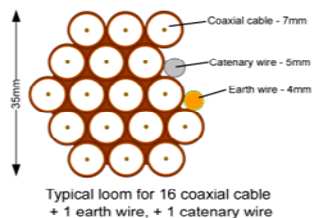

08. Existing Equipments



Form No. SCC 013 SCC International – 1 Fieldings Road, Cheshunt, Herts, EN8 9TL . Tel: 01992 642255. Website: www.scci.co.uk

Drawing No.	E43224,E02014/08	Site Address:	31-31a Daleham Gardens, London, NW3 5BU
Date:	27 th Jan 12	Site Ref:	LBC0315.0
Number of Points:	18	System Type	9Wire IRS Sky Plus
		Surveyed By:	Paul Kenney
		Drawn By:	James Schroder




Please consider the environment before printing this document – Recycle Wherever Possible



09. Antenna and Dishes Measurements

Digital TV,
FM & DAB Radio
Aerials

Proposed location of UHF Aerial on a 6m pole and 80cm dishes mounted on 70.5cmx50cm L-arm on the external face of flat 9.

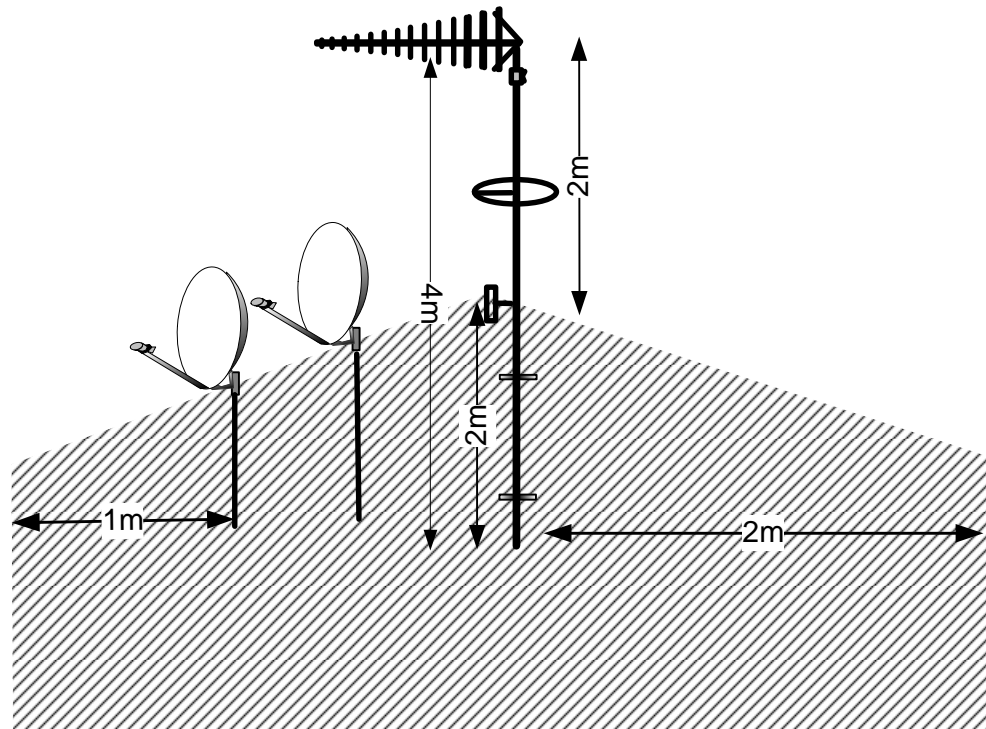

Form No. SCC 013 SCC International – 1 Fieldings Road, Cheshunt, Herts, EN8 9TL, . Tel: 01992 642255. Website: www.scci.co.uk

Drawing No.	E43224,E02014/09	Site Address:	31-31a Daleham Gardens, London, NW3 5BU
Date:	27 th Jan 12	Site Ref:	LBC0315.0
Number of Points:	18	System Type	9Wire IRS Sky Plus
		Surveyed By:	Paul Kenney
		Drawn By:	James Schroder



Please consider the environment before printing this document – Recycle Wherever Possible

