


00. INDEX


Drawing Number	Drawing Title	Description
E43224,E02014/00	Index	Index of Drawings.
E43224,E02014/01	Location Plan	Scale 1:1250 at A4.
E43224,E02014/02	Block Plan	Photo of Site from above.
E43224,E02014/03	Roof Plan	Drawing of block from above, showing equipment positions.
E43224,E02014/04	East Elevation 1	Description and location of the antenna and dishes + mounting and measurements.
E43224,E02014/05	East Elevation 2	Description of Cable routes, loom sizes and entry points and description and location of the Main cabinet size, colour + measurements.
E43224,E02014/06	West Elevation 1	Description of Cable routes, loom sizes and entry points.
E43224,E02014/07	West Elevation 2	Description of Cable routes, loom sizes and entry points.
E43224,E02014/08	Existing Equipments	Description, location and view of the existing equipment on site before install.
E43224,E02014/09	Antenna, Dish Sizes & Typical Mounting Heights	Sketch of the Antenna and Dishes + mounting, position and height.

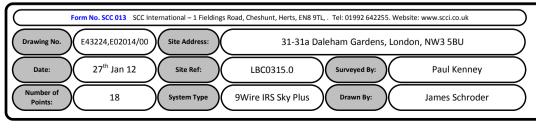

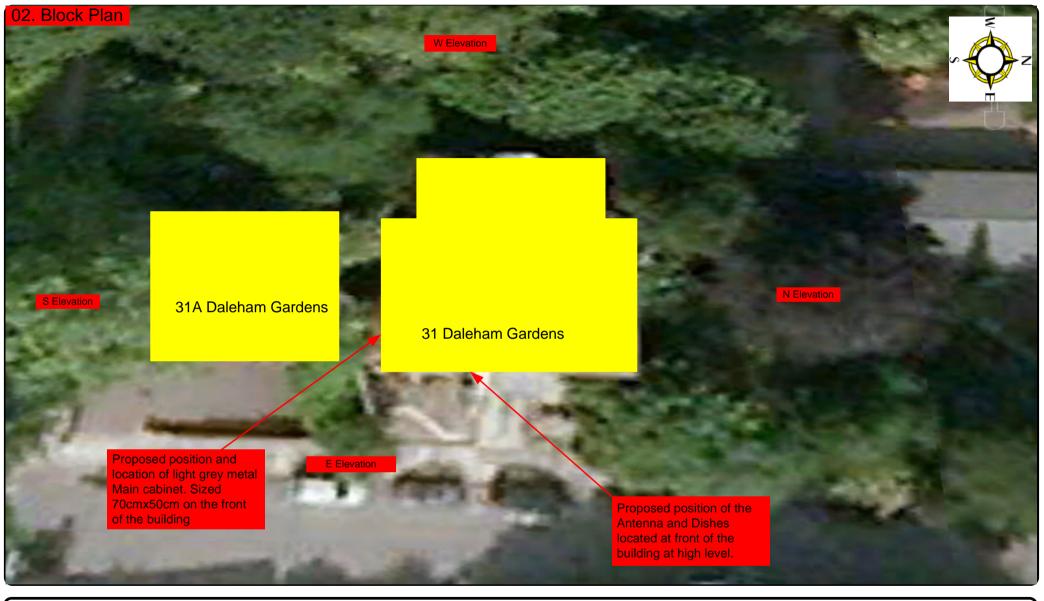

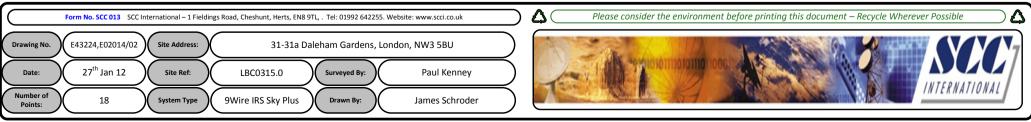



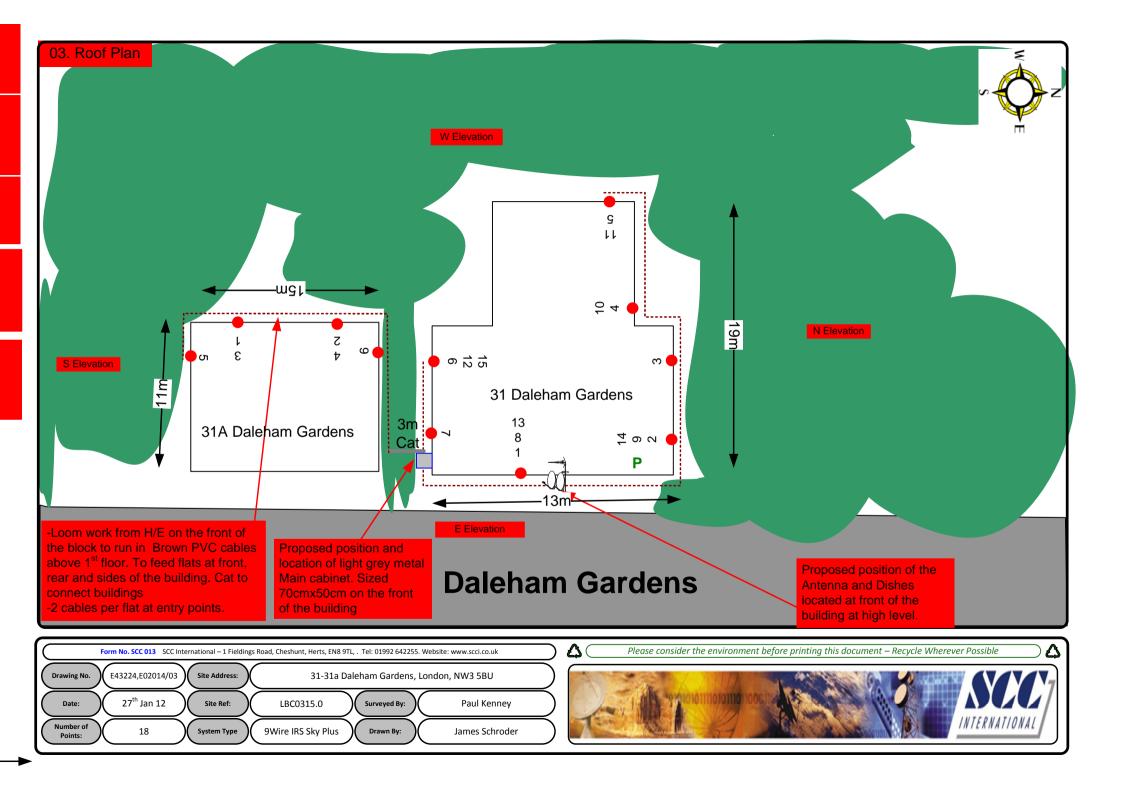

Cable Harness sizes

2-4 cables = 15mm

6-8 cables = 20mm


10-14 cables = 30mm

16-18 Cables = 35mm


20 cables = 40 mm


40 cables = 65 mm

60 cables = 90 mm

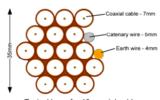

Typical loom for 16 coaxial cable + 1 earth wire, + 1 catenary wire

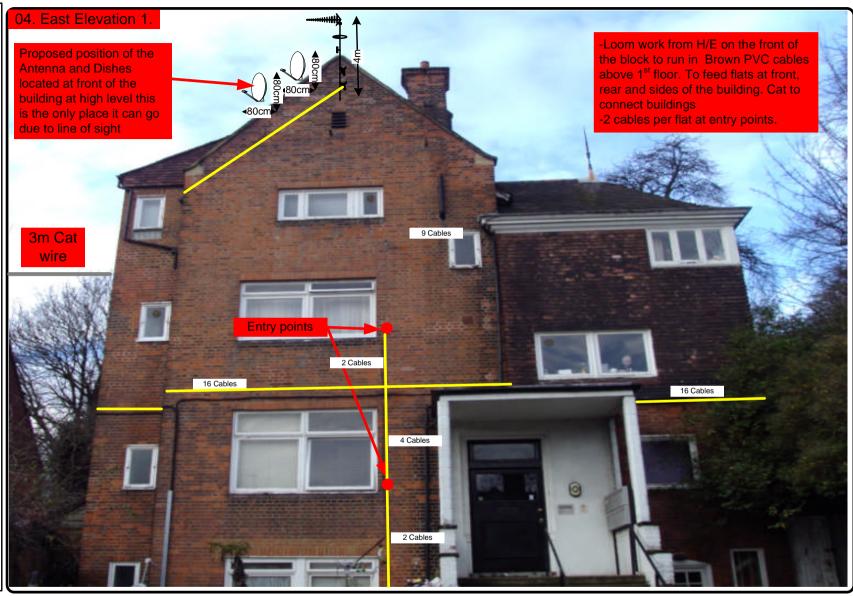

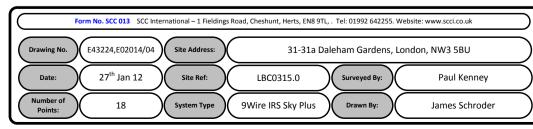



Cable Harness sizes

2-4 cables = 15mm

6-8 cables = 20mm


10-14 cables = 30mm


16-18 Cables = 35mm


20 cables = 40 mm

40 cables = 65 mm

60 cables = 90mm

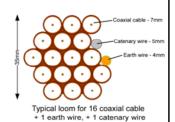

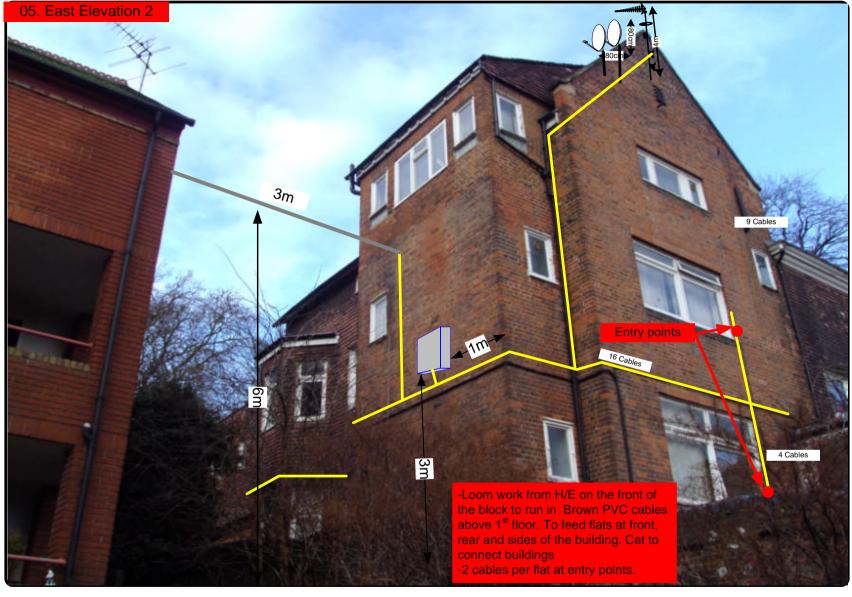

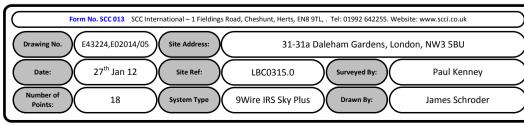



Cable Harness sizes

2-4 cables = 15mm

6-8 cables = 20 mm


10-14 cables = 30mm

16-18 Cables = 35mm


20 cables = 40 mm

40 cables = 65 mm

60 cables = 90 mm

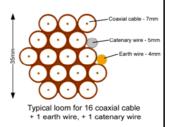



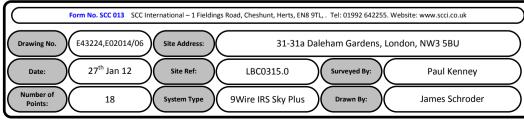



Cable Harness sizes

2-4 cables = 15mm

6-8 cables = 20mm


10-14 cables = 30mm

16-18 Cables = 35mm

20 cables = 40 mm

40 cables = 65 mm

60 cables = 90 mm

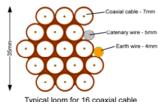

Typical loom for 16 coaxial cable + 1 earth wire, + 1 catenary wire







Cable Harness sizes

2-4 cables = 15mm

6-8 cables = 20mm


10-14 cables = 30mm

16-18 Cables = 35mm

20 cables = 40 mm


40 cables = 65mm

60 cables = 90mm

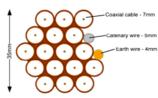

Typical loom for 16 coaxial cable + 1 earth wire, + 1 catenary wire



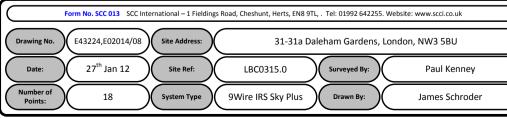



09. Antenna and Dishes Measurements

Digital TV, FM & DAB Radio Aerials Proposed location of UHF Aerial on a 6m pole and 80cm dishes mounted on 70.5cmx50cm L-arm on the external face of flat 9.

