| 00. INDEX | | |
|---|---|---|
| Drawing Number | Drawing Title | Description |
| E014025/00 | Index | Index of Drawings. |
| E014025/01 | Location Plan | Scale 1:1250 at A4 |
| E014025/02 | Block Plan | Photo of Site from above. |
| E014025/03 | Roof Plan | Drawing of block from above, showing equipment positions. |
| E014025/04 | S Elevation 1 | Location of the Main cabinet, Aerial and Dishes |
| E014025/05 | S Elevation 2 | Side entrance front face of the building |
| E014025/06 | North Elevations | Rear View description of drop Cables and looms per flats |
| E014025/07 | Antenna, Dish Sizes & Typical Mounting Heights | Measurement of Dishes mounting position / height. |
| | | |
| Form No. SCC 013 SCC International – 1 Fieldings Road, Cheshunt, Herts, EN8 9TL, . Tel: 01992 642255. Website: www.scci.co.uk | | |
| Drawing No. E014025/00 Site Address: 6-10 GAISFORD STREET, CAMDEN LONDON NW5 2ED | | |

G. Henebery

W. Kisala

21/09/2011

Date:

Number of Points: Site Ref:

System Type

LBC 0446.0


9Wire IRS Sky Plus

Surveyed By:

Drawn By:





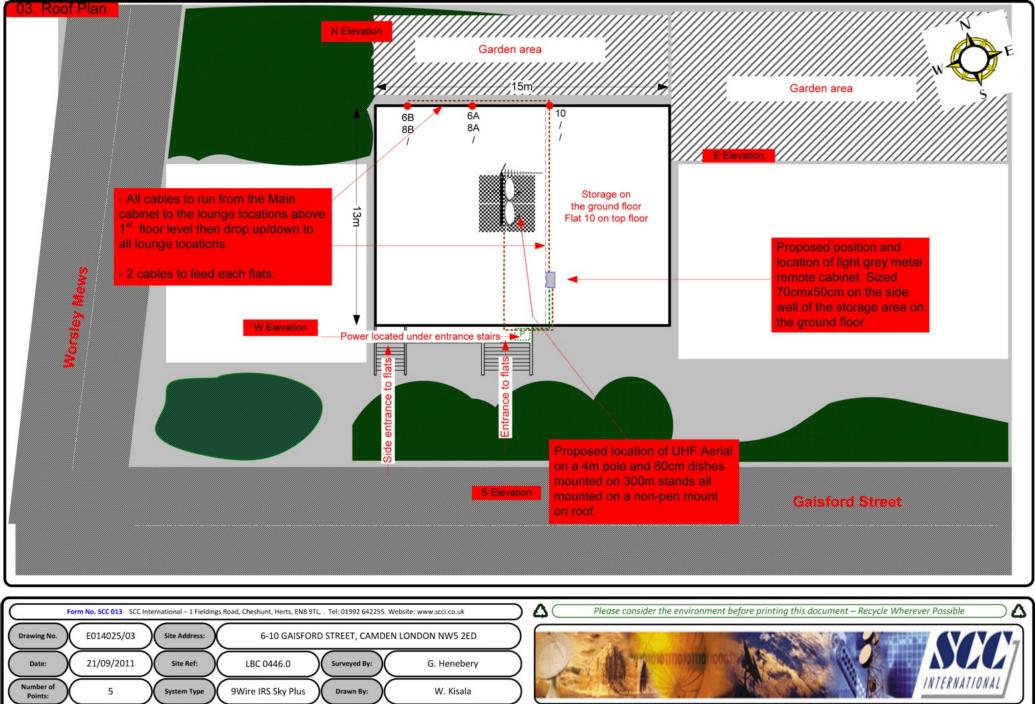

Each property will have two cables to lounge position.


2-4 cables = 15mm 6-8 cables = 20mm

10-14 cables = 30mm


20 cables = 40mm

40 cables = 65mm

60 cables = 90mm

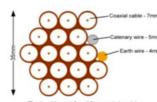

Typical loom for 16 coaxial cable + 1 earth wire, + 1 catenary wire

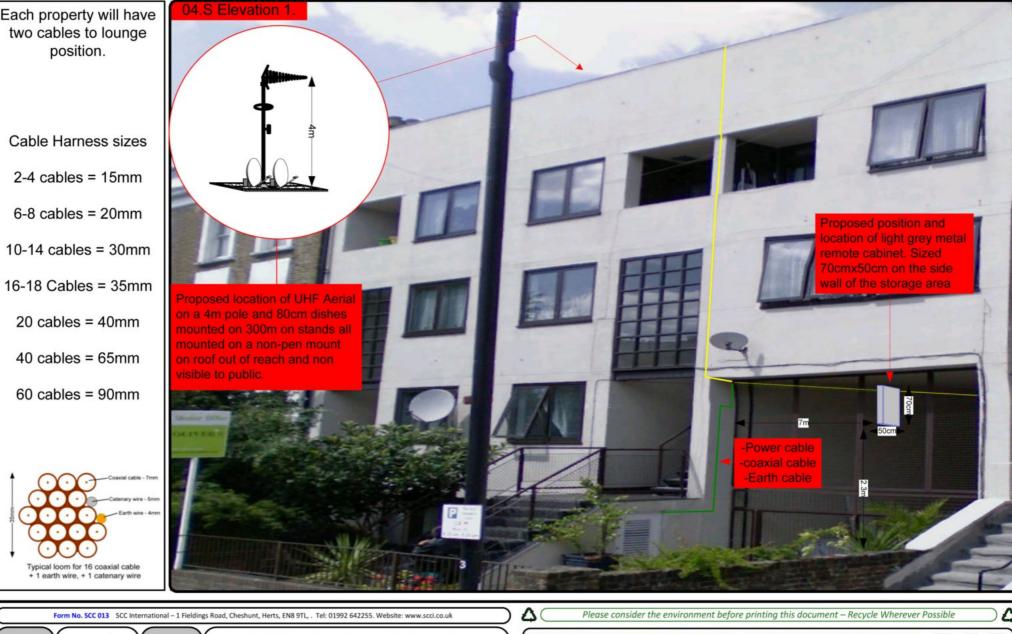





Each property will have two cables to lounge position.

Cable Harness sizes

2-4 cables = 15mm

6-8 cables = 20mm

10-14 cables = 30mm

16-18 Cables = 35mm 20 cables = 40mm

40 cables = 65mm

60 cables = 90mm

