

## 00. INDEX


Drawing Number	Drawing Title	Description
B045108-15/00	Index	Index of Drawings.
B045108-15/01	Location Plan	Scale 1:1250 at A4.
B045108-15/02	Roof Plan	Drawing of block from above, showing equipment positions.
B045108-15/03	Roof Elevation	Description and location of the antenna and dishes + mounting and measurements
B045108-15/04	West Elevation 1	Description of Cable routes, loom sizes and entry points
B045108-15/05	West Elevation 2	Description of Cable routes, loom sizes and entry points.
B045108-15/06	East Elevation	Description of Cable routes, loom sizes and entry points. Description and location of the Main cabinet size and colour
B045108-15/07	Existing Equipments	Description, location and view of the existing equipment on site before install.
B045108-15/08	Antenna, Dish Sizes & Typical Mounting Heights	Sketch of the Antenna and Dishes + mounting, position and height.

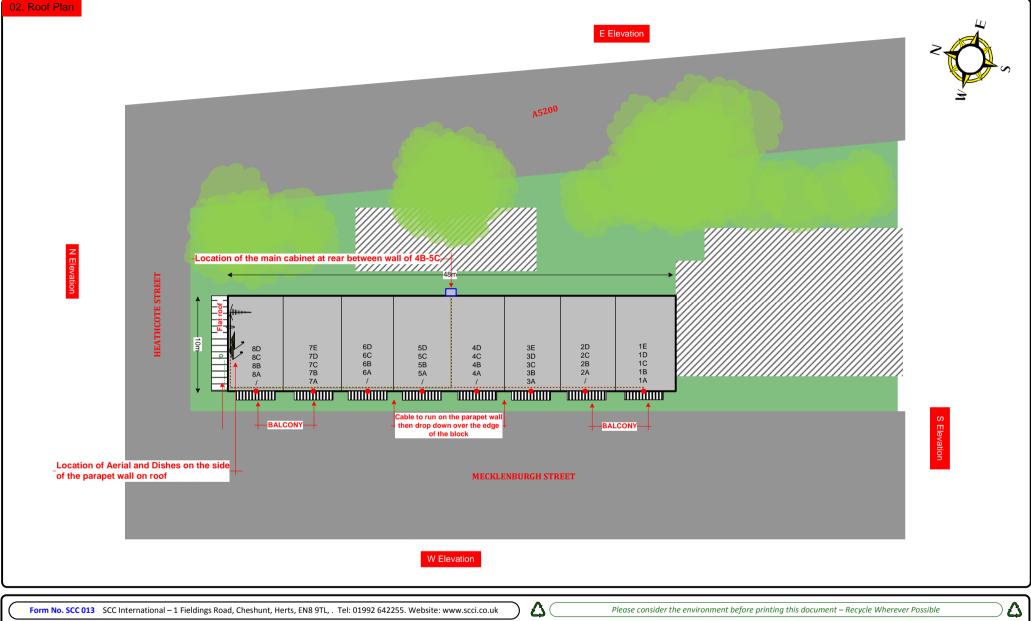


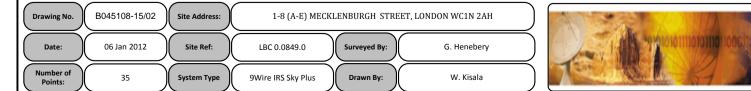







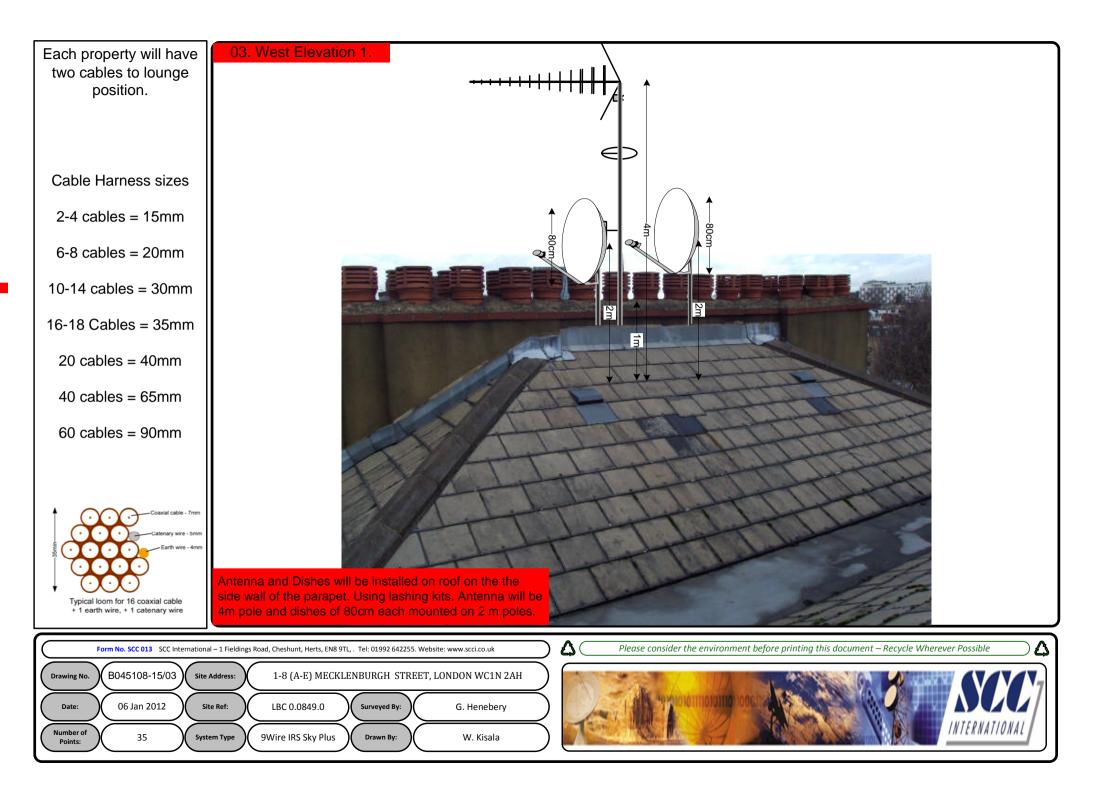


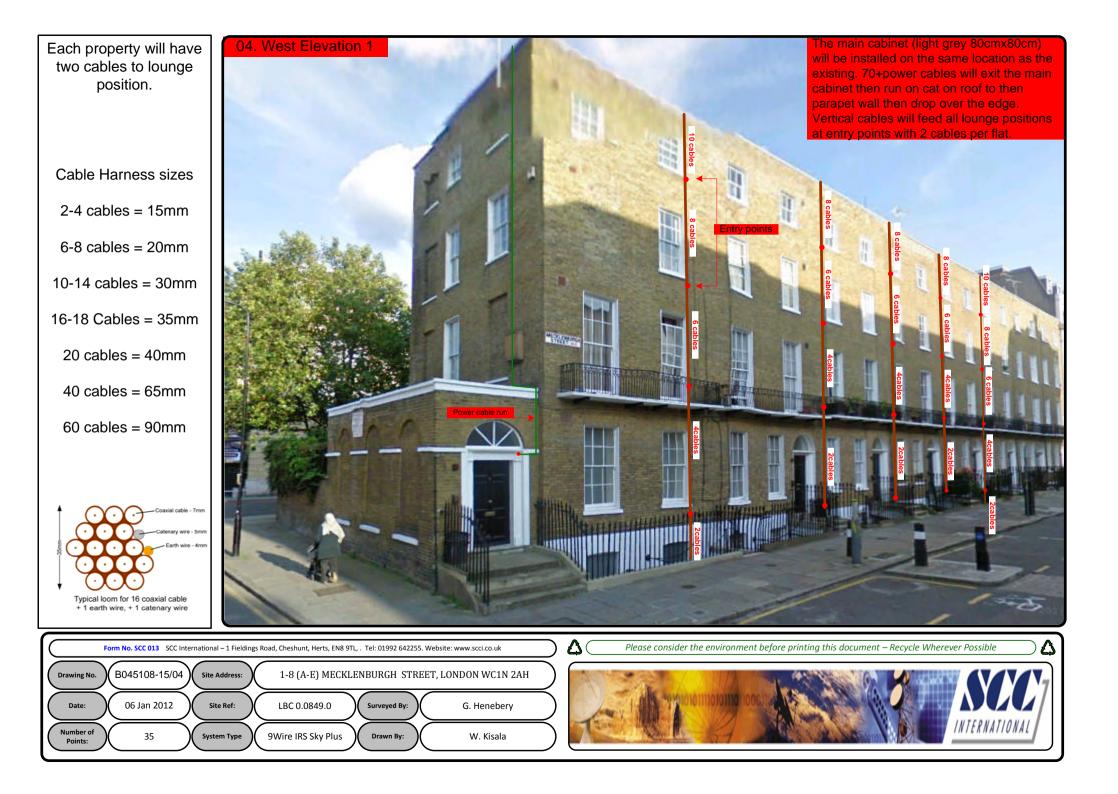

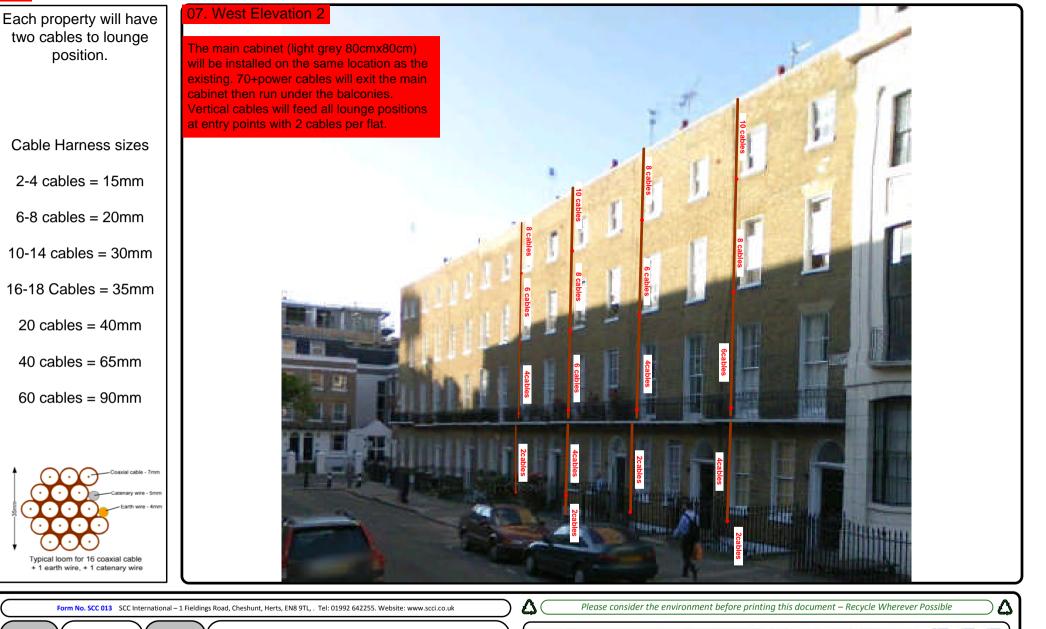

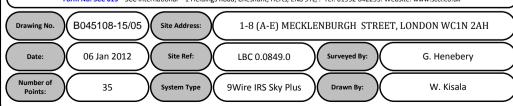



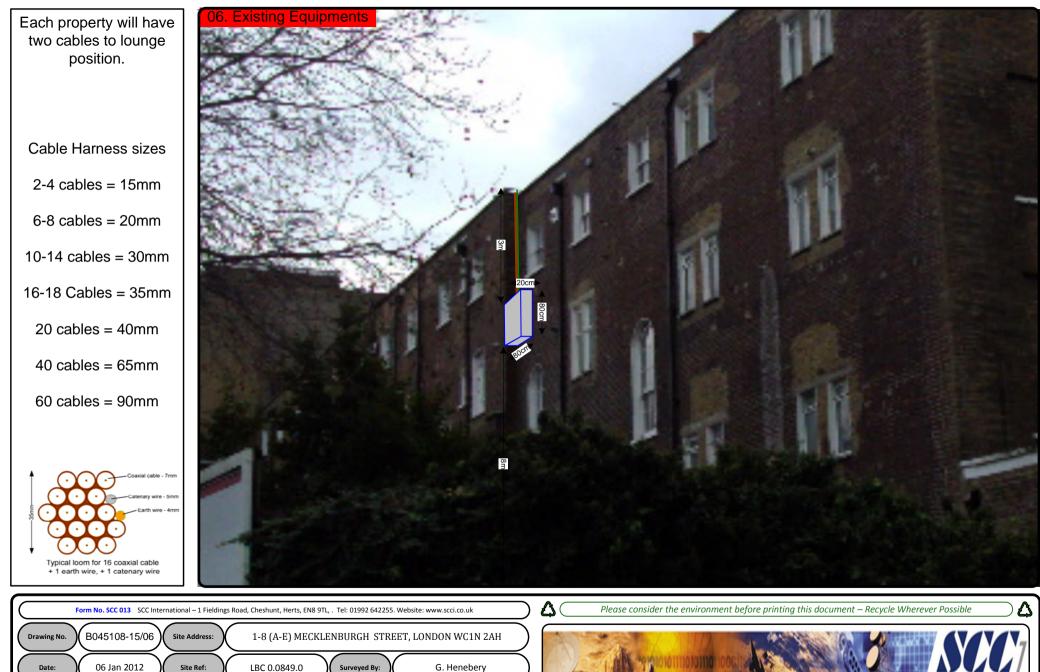


Site Ref: LBC 0.0849.0 Surveyed By: G. Henebery 35 9Wire IRS Sky Plus W. Kisala System Type Drawn By:

Number of

Points:



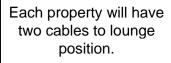

Cable Harness sizes

2-4 cables = 15mm

6-8 cables = 20mm


10-14 cables = 30mm

16-18 Cables = 35mm

20 cables = 40 mm

40 cables = 65 mm

60 cables = 90mm

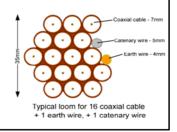



## South Elevation

