

00. INDEX

| Drawing Number | Drawing Title | Description |
|----------------|--|---|
| B02062/00 | Index | Index of Drawings. |
| B02062/01 | Location Plan | Scale 1:1250 at A4. |
| B02062/02 | Block Plan | Photo of Site from above. |
| B02062/03 | Roof Plan | Drawing of block from above, showing equipment positions. |
| B02062/04 | South & East Elevations | Description and location of the antenna, dishes and Main Cabinet |
| B02062/05 | South Elevation 1 | Description of cable routes, colour and loom sizes per flats at entry points for each drops |
| B02062/06 | South elevation 2 | Description of cable routes, colour and loom sizes per flats at entry points for each drops |
| B02062/07 | Internal elevation | Description and location of the Main & remote cabinet size, colour + measurements. |
| B02062/08 | Existing Equipments | View and location of existing equipment on site |
| B02062/09 | Antenna, Dish Sizes & Typical Mounting Heights | Antenna and Dishes description, mounting, position, height and measurements. |

Form No. SCC 013 SCC International – 1 Fieldings Road, Cheshunt, Herts, EN8 9TL, . Tel: 01992 642255. Website: www.scci.co.uk



Please consider the environment before printing this document – Recycle Wherever Possible



Site Reference: B02062/00 Site Address: Flats 77-108, Broadfield Broadhurst Gardens, LONDON, NW6 3BN

Date: 10/11/2011 Client: LBC-0727.0 Surveyed By: G.Henebery

Number of Points: 32 System Type: 9-Wire Drawn By: W. Kisala



02. Block Plan



Form No. SCC 013 SCC International – 1 Fieldings Road, Cheshunt, Herts, EN8 9TL, . Tel: 01992 642255. Website: www.scci.co.uk




Please consider the environment before printing this document – Recycle Wherever Possible



| | | | |
|-------------------|------------|---------------|--|
| Site Reference: | B02062/02 | Site Address: | Flats 77-108, Broadfield Broadhurst Gardens, LONDON, NW6 3BN |
| Date: | 10/11/2011 | Client: | LBC-0727.0 |
| Number of Points: | 32 | System Type: | 9-Wire |
| | | Surveyed By: | G.Henebery |
| | | Drawn By: | W. Kisala |



03. Roof Plan

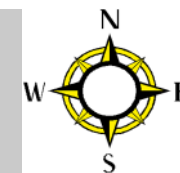

North Elevation

Power located in the hallway of flats 80-97

East Elevation

West Elevation

10m

95m

Proposed position and location of light grey metal remote cabinet. Sized 70x50cm within the communal entrance way to flats

Proposed position of the Antenna and Dishes located on roof on the end wall at high

Broadhurst Gardens

Proposed position and location of light grey metal Main cabinet. Sized 70x50cm on the sidewall 77 above windows level.

South Elevation


Form No. SCC 013 SCC International – 1 Fieldings Road, Cheshunt, Herts, EN8 9TL, . Tel: 01992 642255. Website: www.scci.co.uk

Please consider the environment before printing this document – Recycle Wherever Possible

Site Reference: B02062/03 Site Address: Flats 77-108, Broadfield Broadhurst Gardens, LONDON, NW6 3BN

Date: 10/11/2011 Client: LBC-0727.0 Surveyed By: G.Henebery

Number of Points: 32 System Type: 9-Wire Drawn By: W. Kisala

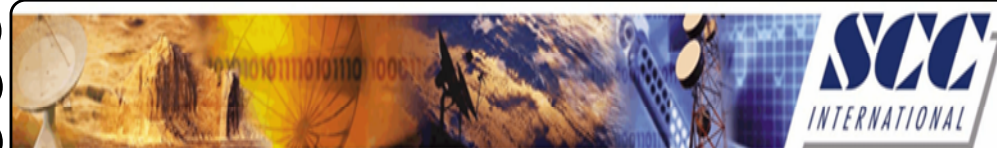

Each property will have two cables to lounge position.

Cable Harness sizes

2-4 cables = 15mm

6-8 cables = 20mm


10-14 cables = 30mm

16-18 Cables = 35mm

20 cables = 40mm

40 cables = 65mm

60 cables = 90mm

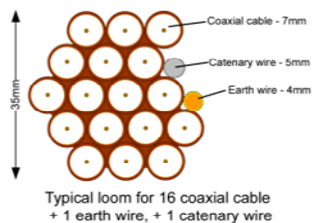

04. South & East Elevation



Form No. SCC 013 SCC International – 1 Fieldings Road, Cheshunt, Herts, EN8 9TL, . Tel: 01992 642255. Website: www.scci.co.uk



Please consider the environment before printing this document – Recycle Wherever Possible



| | | | |
|-------------------|------------|---------------|--|
| Site Reference: | B02062/04 | Site Address: | Flats 77-108, Broadfield Broadhurst Gardens, LONDON, NW6 3BN |
| Date: | 10/11/2011 | Client: | LBC-0727.0 |
| Number of Points: | 32 | System Type | 9-Wire |
| | | Drawn By: | W. Kisala |
| | | Surveyed By: | G.Henebery |



Each property will have two cables to lounge position.

Cable Harness sizes

2-4 cables = 15mm

6-8 cables = 20mm


10-14 cables = 30mm

16-18 Cables = 35mm

20 cables = 40mm

40 cables = 65mm

60 cables = 90mm

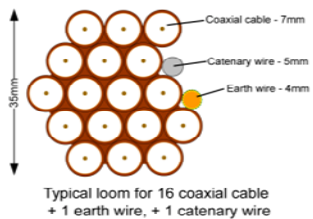

05. South Elevation 1



- All cables (brown) to run from the Main and remote cabinet above ground floor to then drop to all lounge points on the rear face of the block facing the main road.
- 2 cables to feed each flat at entry points.

Form No. SCC 013 SCC International – 1 Fieldings Road, Cheshunt, Herts, EN8 9TL, . Tel: 01992 642255. Website: www.scci.co.uk



Please consider the environment before printing this document – Recycle Wherever Possible



| | | | | | |
|-------------------|------------|---------------|--|--------------|------------|
| Site Reference: | B02062/05 | Site Address: | Flats 77-108, Broadfield Broadhurst Gardens, LONDON, NW6 3BN | | |
| Date: | 10/11/2011 | Client: | LBC-0727.0 | Surveyed By: | G.Henebery |
| Number of Points: | 32 | System Type | 9-Wire | Drawn By: | W. Kisala |



Each property will have two cables to lounge position.

Cable Harness sizes

2-4 cables = 15mm

6-8 cables = 20mm


10-14 cables = 30mm

16-18 Cables = 35mm

20 cables = 40mm


40 cables = 65mm

60 cables = 90mm

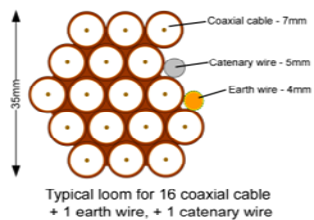

06. South Elevation 2

- All cables (brown) to run from the Main and remote cabinet above ground floor to then drop to all lounge points on the rear face of the block facing the main road.
- 2 cables to feed each flat at entry points.

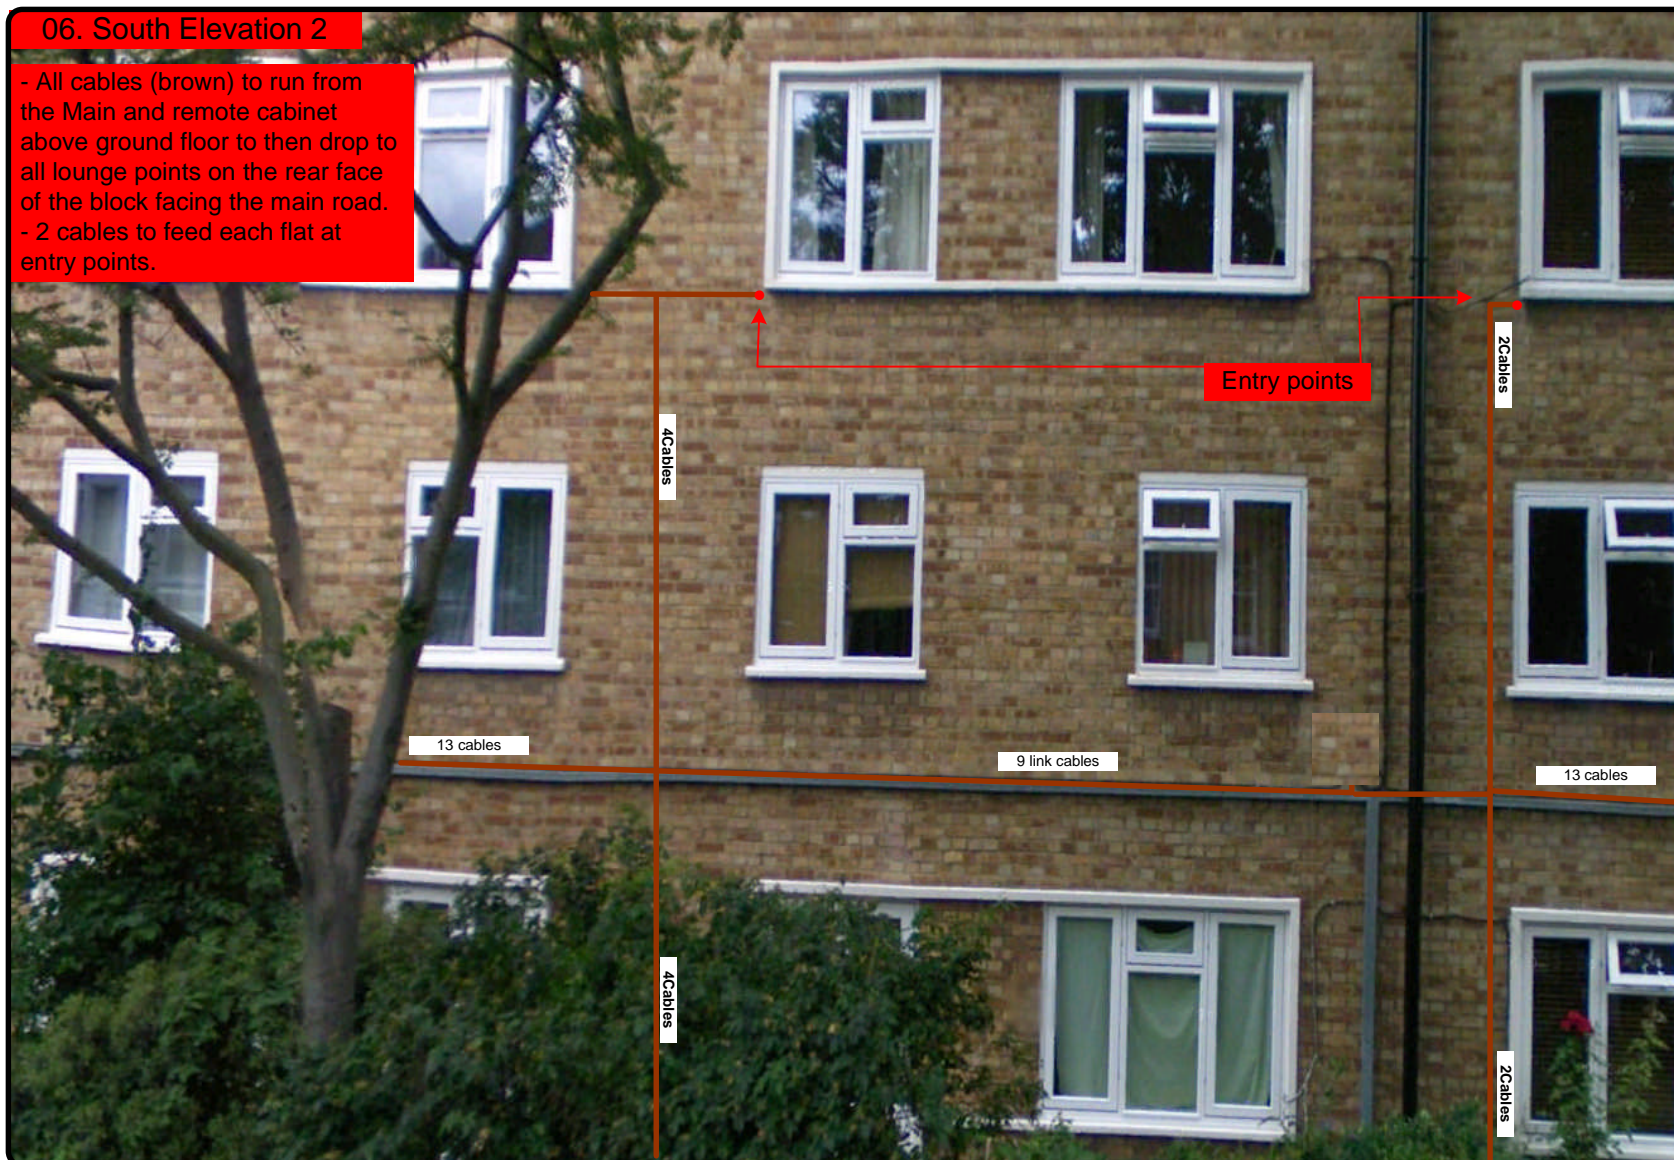

Form No. SCC 013 SCC International – 1 Fieldings Road, Cheshunt, Herts, EN8 9TL, . Tel: 01992 642255. Website: www.scci.co.uk

Site Reference: B02062/06 Site Address: Flats 77-108, Broadfield Broadhurst Gardens, LONDON, NW6 3BN

Date: 10/11/2011 Client: LBC-0727.0 Surveyed By: G.Henebery

Number of Points: 32 System Type: 9-Wire Drawn By: W. Kisala



Please consider the environment before printing this document – Recycle Wherever Possible



Each property will have two cables to lounge position.

Cable Harness sizes

2-4 cables = 15mm

6-8 cables = 20mm


10-14 cables = 30mm

16-18 Cables = 35mm


20 cables = 40mm

40 cables = 65mm

60 cables = 90mm

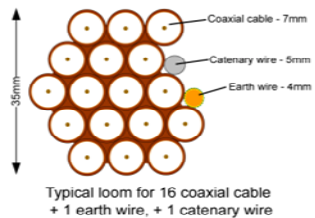


06. Internal Elevation

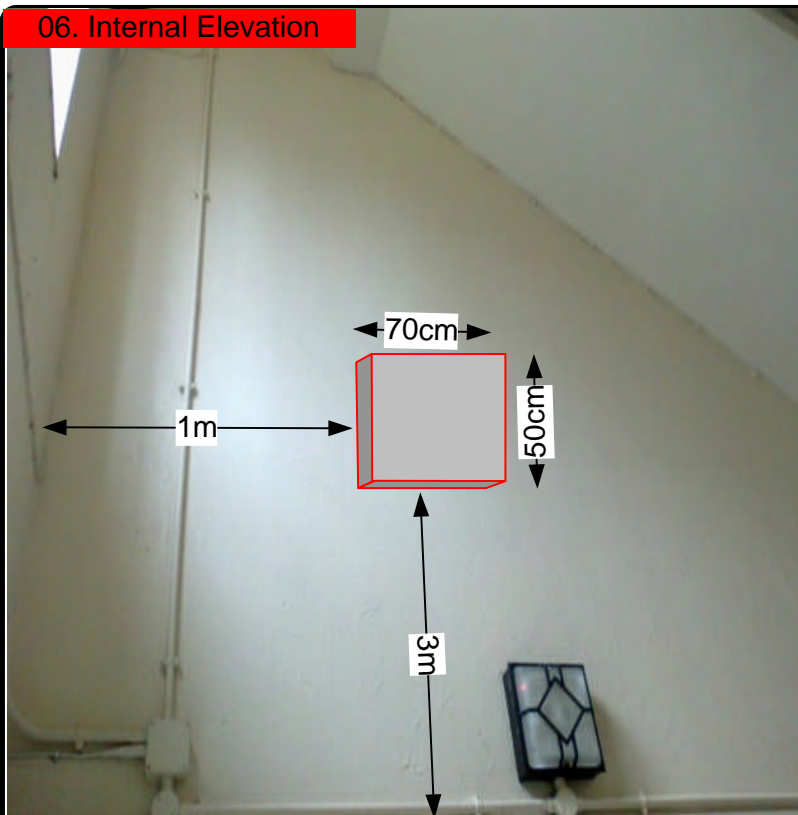

Proposed position and location of light grey metal remote cabinet. Sized 70x50cm within the communal entrance way to flats

Proposed position and location of light grey metal Main cabinet. Sized 70x50cm on the sidewall 77 above windows level.

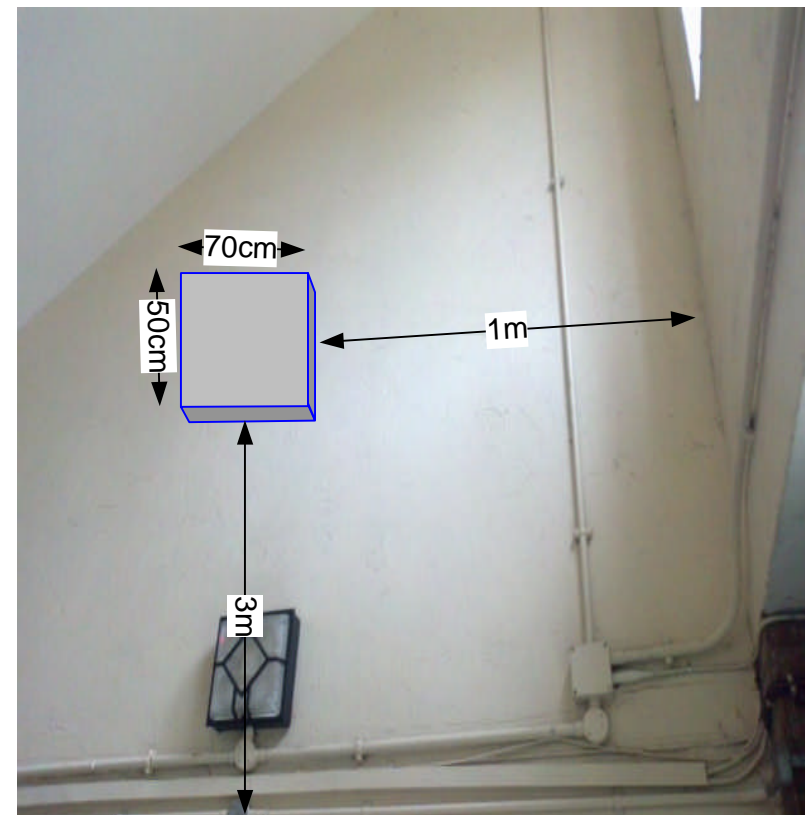

Form No. SCC 013 SCC International – 1 Fieldings Road, Cheshunt, Herts, EN8 9TL, . Tel: 01992 642255. Website: www.scci.co.uk

Site Reference: B02062/07 Site Address: Flats 77-108, Broadfield Broadhurst Gardens, LONDON, NW6 3BN

Date: 10/11/2011 Client: LBC-0727.0 Surveyed By: G.Henebery

Number of Points: 32 System Type: 9-Wire Drawn By: W. Kisala

Please consider the environment before printing this document – Recycle Wherever Possible



Each property will have two cables to lounge position.

Cable Harness sizes

2-4 cables = 15mm

6-8 cables = 20mm


10-14 cables = 30mm

16-18 Cables = 35mm

20 cables = 40mm

40 cables = 65mm

60 cables = 90mm

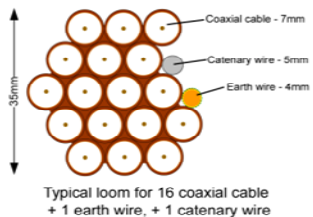

08. Existing Equipments



South Elevation

Form No. SCC 013 SCC International – 1 Fieldings Road, Cheshunt, Herts, EN8 9TL, . Tel: 01992 642255. Website: www.scci.co.uk

| | | | |
|-------------------|------------|---------------|--|
| Site Reference: | B02062/08 | Site Address: | Flats 77-108, Broadfield Broadhurst Gardens, LONDON, NW6 3BN |
| Date: | 10/11/2011 | Client: | LBC-0727.0 |
| Number of Points: | 32 | System Type: | 9-Wire |
| | | Surveyed By: | G.Henebery |
| | | Drawn By: | W. Kisala |


Please consider the environment before printing this document – Recycle Wherever Possible



09. Antenna and Dishes Measurements

Proposed location of UHF Aerial on a 4m pole mounted using wall bracket and 80cm dishes mounted using lashing kits. all installed on the end wall at high

Digital TV,
FM & DAB Radio
Aerials

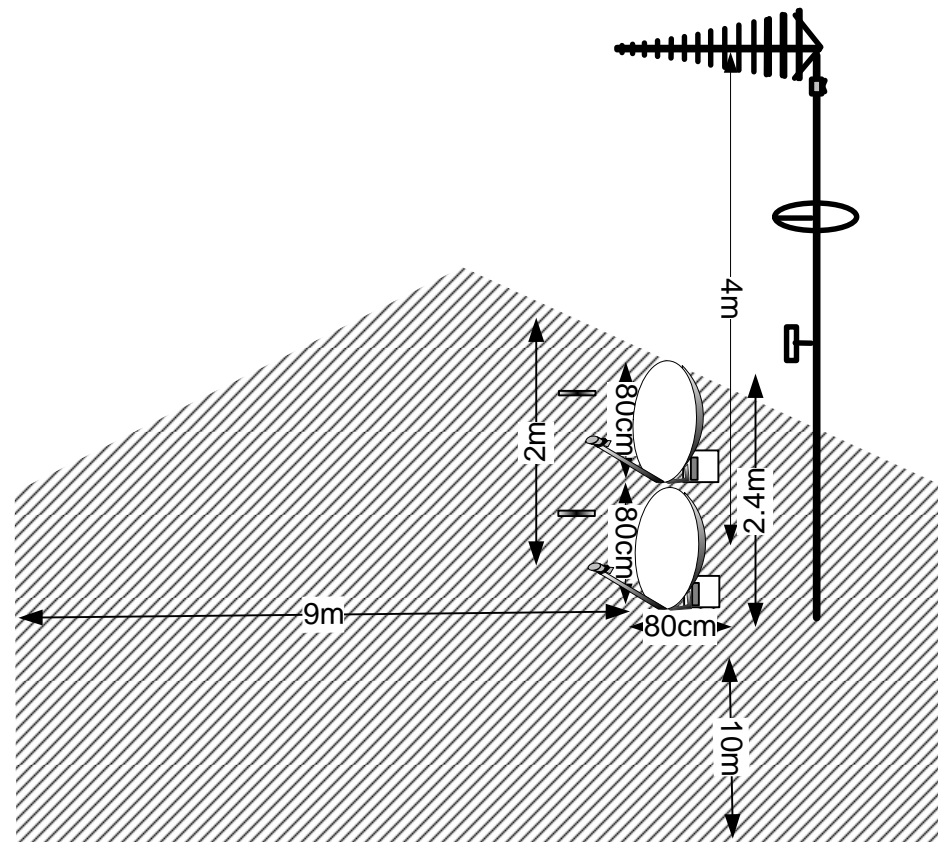

Form No. SCC 013 SCC International – 1 Fieldings Road, Cheshunt, Herts, EN8 9TL, . Tel: 01992 642255. Website: www.scci.co.uk



Please consider the environment before printing this document – Recycle Wherever Possible



| | | | |
|-------------------|------------|---------------|--|
| Site Reference: | B02062/09 | Site Address: | Flats 77-108, Broadfield Broadhurst Gardens, LONDON, NW6 3BN |
| Date: | 10/11/2011 | Client: | LBC-0727.0 |
| Number of Points: | 32 | System Type | 9-Wire |
| | | Drawn By: | W. Kisala |
| | | Surveyed By: | G.Henebery |

