


00. INDEX

Drawing Number	Drawing Title	Description
B02061/00	Index	Index of Drawings.
B02061/01	Location Plan	Scale 1:1250 at A4.
B02061/02	Block Plan	Photo of Site from above.
B02061/03	Roof Plan	Drawing of block from above, showing equipment positions.
B02061/04	South East Elevation	Description and location of the antenna and dishes + mounting and measurements.
B02061/05	South Elevation 1	Description of Cable routes, loom sizes and entry points.
B02061/06	South Elevation 2	Description of Cable routes, loom sizes and entry points.
B02061/07	Internal Elevation	Description and location of the Main and remote cabinet size, colour + measurements.
B02061/08	Existing Equipments	Description, location and view of the existing equipment on site before install.
B02061/09	Antenna, Dish Sizes & Typical Mounting Heights	Sketch of the Antenna and Dishes + mounting, position and height.

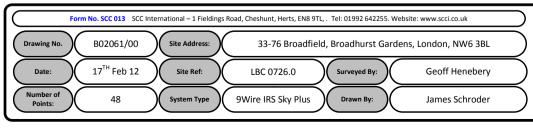


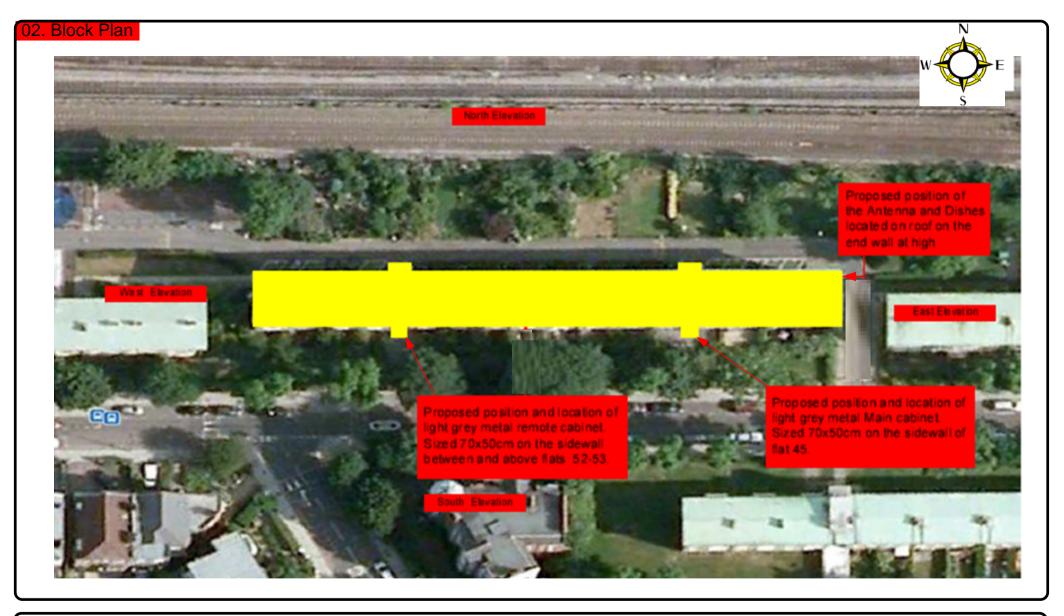

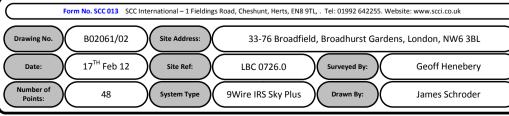





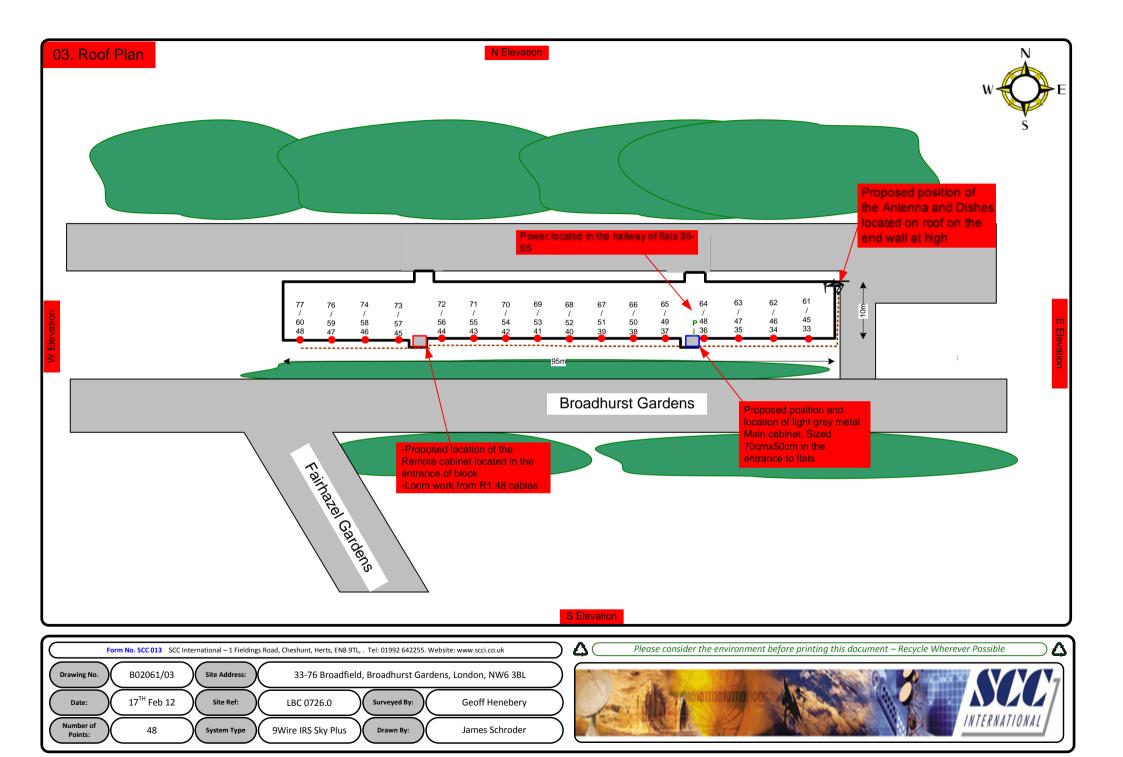

Cable Harness sizes

2-4 cables = 15mm

6-8 cables = 20mm


10-14 cables = 30mm

16-18 Cables = 35mm

20 cables = 40mm


40 cables = 65 mm

60 cables = 90mm

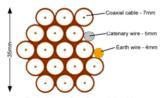

Typical loom for 16 coaxial cable + 1 earth wire, + 1 catenary wire



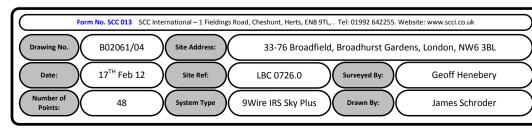



Cable Harness sizes

2-4 cables = 15mm

6-8 cables = 20mm


10-14 cables = 30mm


16-18 Cables = 35mm


20 cables = 40mm

40 cables = 65 mm

60 cables = 90mm

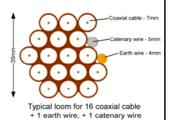

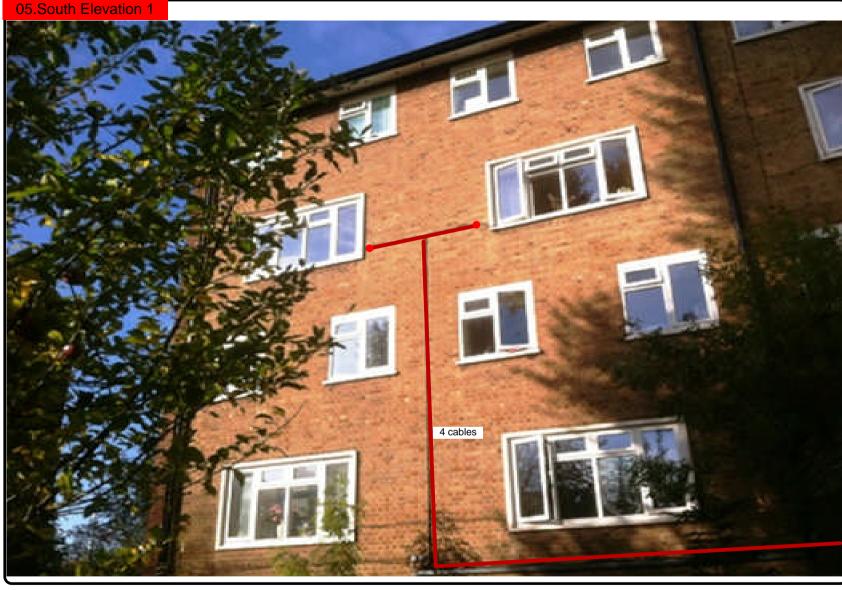

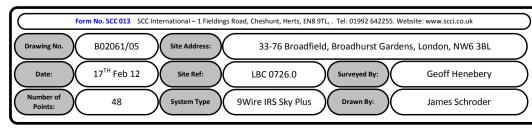



Cable Harness sizes

2-4 cables = 15mm

6-8 cables = 20mm


10-14 cables = 30mm

16-18 Cables = 35mm


20 cables = 40 mm

40 cables = 65mm

60 cables = 90mm

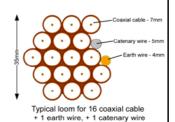



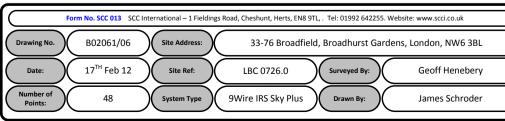



Cable Harness sizes

2-4 cables = 15mm

6-8 cables = 20mm


10-14 cables = 30mm

16-18 Cables = 35mm

20 cables = 40 mm

40 cables = 65 mm

60 cables = 90 mm

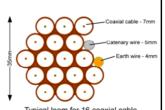



+ 1 earth wire, + 1 catenary wire

-Proposed location of the Remote cabinet located in the entrance of block
-Loom work from R1 57 cables

07. Internal Elevation

Proposed position and location of light grey metal Main cabinet. Sized 70cmx50cm in the entrance to flats

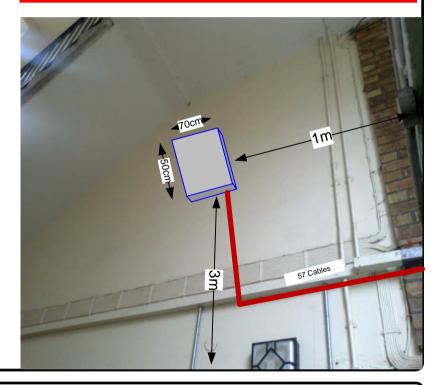

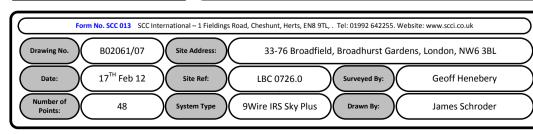



Cable Harness sizes

2-4 cables = 15mm

6-8 cables = 20mm


10-14 cables = 30mm

16-18 Cables = 35mm

20 cables = 40 mm


40 cables = 65 mm

60 cables = 90mm

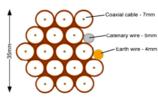

Typical loom for 16 coaxial cable + 1 earth wire, + 1 catenary wire



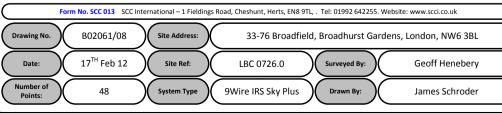



09. Antenna and Dishes Measurements

Proposed location of UHF Aerial on a 6m pole and 80cm dishes mounted on 70.5cmx50cm L-arm on the external face of flat 9.

