


## 00. INDEX

Drawing Number	Drawing Title	Description
B02060/00	Index	Index of Drawings.
B02060/01	Location Plan	Scale 1:1250 at A4.
B02060/02	Block Plan	Photo of Site from above.
B02060/03	Roof Plan	Drawing of block from above, showing equipment positions.
B02060/04	North Elevations	Description and location of the antenna and dishes
B02060/05	South Elevation 1	Description of Cable routes, loom sizes and entry points.
B02060/06	South elevation 2	Description of Cable routes, loom sizes and entry points.
B02060/07	South elevation 2	Description and location of the Main cabinet and remote cabinet size, colour + measurements.
B02060/08	Existing Equipments	View and location of existing equipment on site
B02060/09	Antenna, Dish Sizes & Typical Mounting Heights	Antenna and Dishes description, mounting, position, height and measurements.

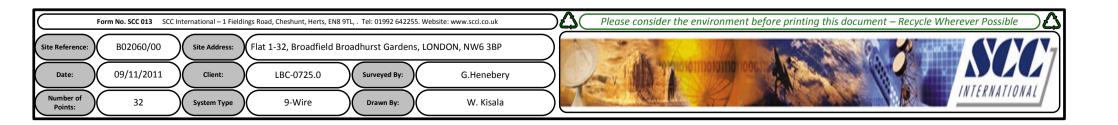



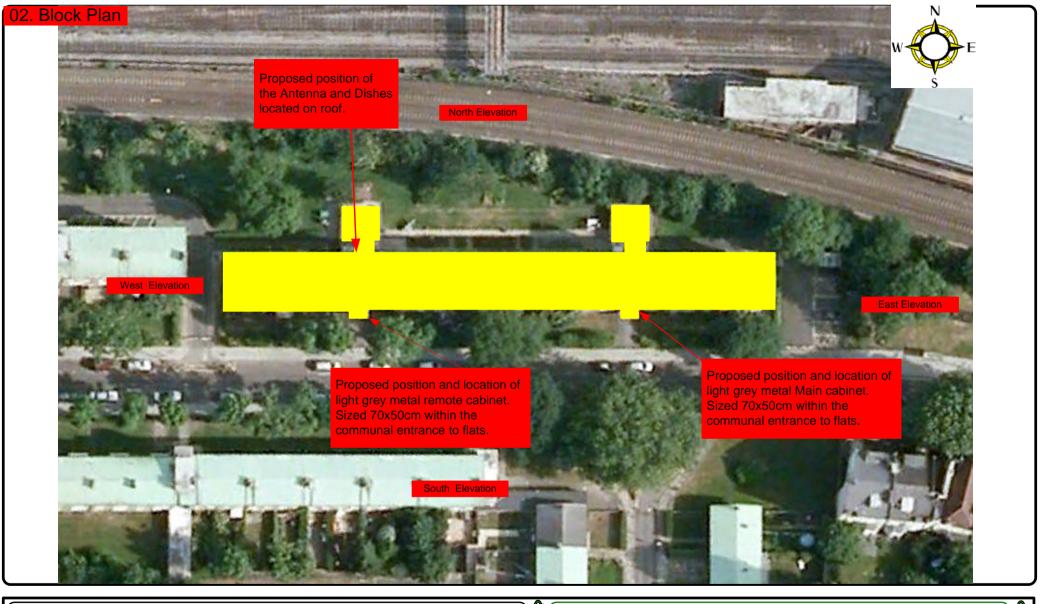

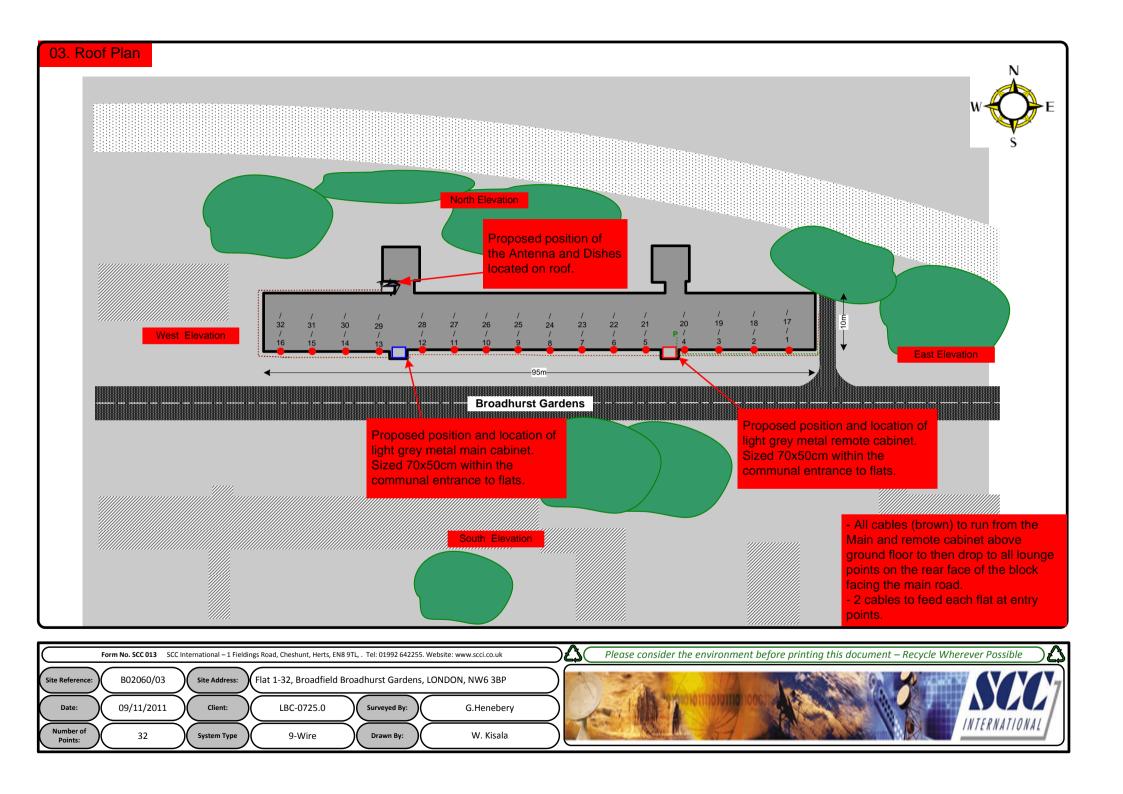

Cable Harness sizes

2-4 cables = 15mm

6-8 cables = 20mm


10-14 cables = 30mm

16-18 Cables = 35mm

20 cables = 40mm


40 cables = 65 mm

60 cables = 90mm

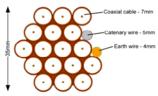

Typical loom for 16 coaxial cable + 1 earth wire, + 1 catenary wire



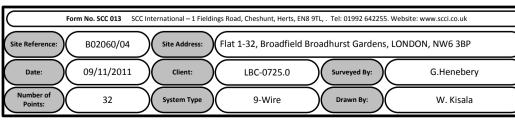



Cable Harness sizes

2-4 cables = 15mm

6-8 cables = 20mm


10-14 cables = 30mm

16-18 Cables = 35mm


20 cables = 40 mm

40 cables = 65mm

60 cables = 90mm

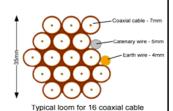



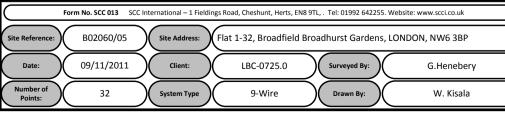



Cable Harness sizes

2-4 cables = 15mm

6-8 cables = 20 mm


10-14 cables = 30mm

16-18 Cables = 35mm

20 cables = 40mm


40 cables = 65 mm

60 cables = 90mm

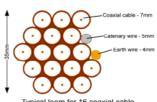

Typical loom for 16 coaxial cable + 1 earth wire, + 1 catenary wire



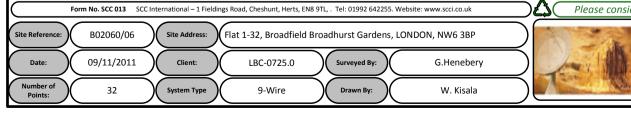



Cable Harness sizes

2-4 cables = 15mm

6-8 cables = 20mm


10-14 cables = 30mm

16-18 Cables = 35mm


20 cables = 40 mm

40 cables = 65 mm

60 cables = 90 mm

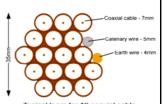



Typical loom for 16 coaxial cable

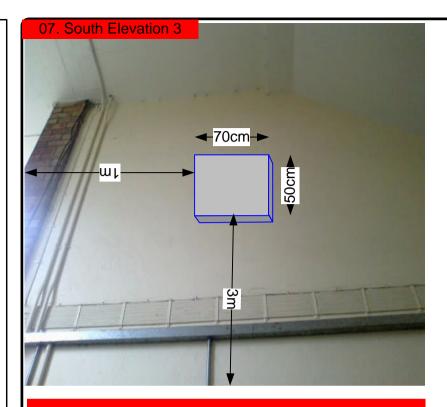

Proposed position and location of light grey metal remote cabinet. Sized 70x50cm within the communal entrance to flats.

Proposed position and location of light grey metal main cabinet. Sized 70x50cm within the communal entrance to flats.

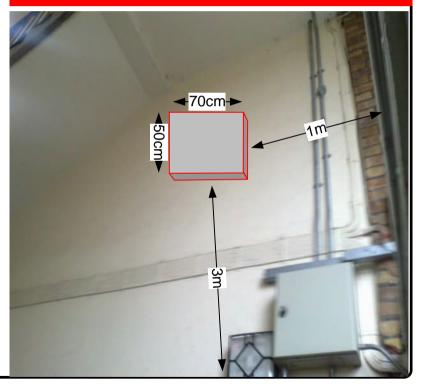

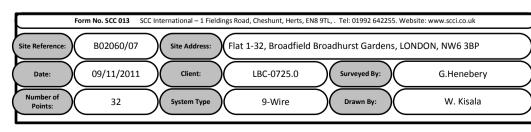



Cable Harness sizes

2-4 cables = 15mm

6-8 cables = 20 mm


10-14 cables = 30mm

16-18 Cables = 35mm

20 cables = 40 mm

40 cables = 65 mm

60 cables = 90 mm

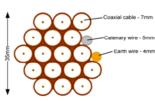

Typical loom for 16 coaxial cable + 1 earth wire, + 1 catenary wire



