

00. INDEX

Drawing Number	Drawing Title	Description
E45214/00	Index	Index of Drawings.
E45214/01	Location Plan	Scale 1:1250 at A4.
E45214/02	Block Plan	Photo of Site from above.
E45214/03	Roof Plan	Drawing of block from above, showing equipment positions.
E45214/04	South Elevation 1	Description and location of the antenna and dishes + mounting and measurements and description and location of the Main cabinet size, colour + measurements.
E45214/05	South Elevation 2	Description of Cable routes, loom sizes and entry points.
E45214/06	South Elevation 3	Description of Cable routes, loom sizes and entry points.
E45214/07	South Elevation 4	Description of Cable routes, loom sizes and entry points.
E45214/08	Existing Equipments	Description, location and view of the existing equipment on site before install.
E45214/09	Antenna, Dish Sizes & Typical Mounting Heights	Sketch of the Antenna and Dishes + mounting, position and height.

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Drawing No.	E45214/00	Site Address:	1-15 Victoria Mansions, London, NW6 1PD		
Date:	22 ND Jan 12	Site Ref:	LBC 0785.0	Surveyed By:	Paul Kenney
Number of Points:	15	System Type	9Wire IRS Sky Plus	Drawn By:	James Schroder



02. Block Plan



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Drawing No.	E45214/02	Site Address:	1-15 Victoria Mansions, London, NW6 1PD		
Date:	22 ND Jan 12	Site Ref:	LBC 0785.0	Surveyed By:	Paul Kenney
Number of Points:	15	System Type	9Wire IRS Sky Plus	Drawn By:	James Schroder




03. Roof Plan

N Elevation

Sandwell Crescent

-Loom work from H/E on the gable end of flat 12 in brown PVC cables to exit the H/E and run above 4th floor. To feed flats at front wall of the building.
-2 cables per flat at entry points.

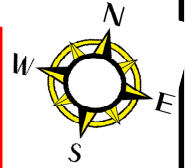

Intake cupboard for the power is located at the rear of the block


Proposed position and location of light grey metal Main cabinet. Sized 70cmx50cm on the gable end of flat 12.

Proposed position of the Antenna and Dishes located on the gable end of flat 14

E Elevation

West End Lane

W Elevation

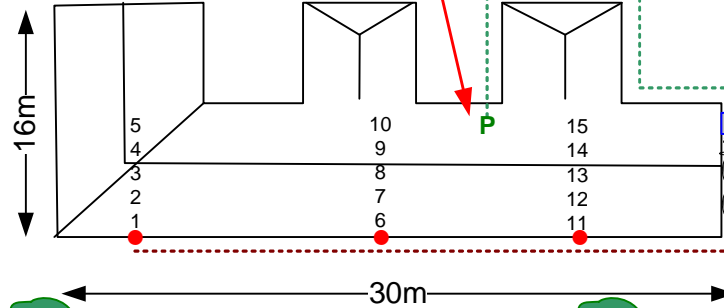

Sumatra Road

S Elevation

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Drawing No.	E45214/03	Site Address:	1-15 Victoria Mansions, London, NW6 1PD		
Date:	22 ND Jan 12	Site Ref:	LBC 0785.0	Surveyed By:	Paul Kenney
Number of Points:	15	System Type	9Wire IRS Sky Plus	Drawn By:	James Schroder



Each property will have two cables to lounge position.

Cable Harness sizes

2-4 cables = 15mm

6-8 cables = 20mm


10-14 cables = 30mm

16-18 Cables = 35mm


20 cables = 40mm

40 cables = 65mm

60 cables = 90mm

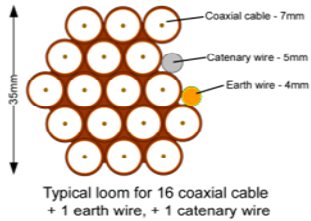

04.South Elevation.

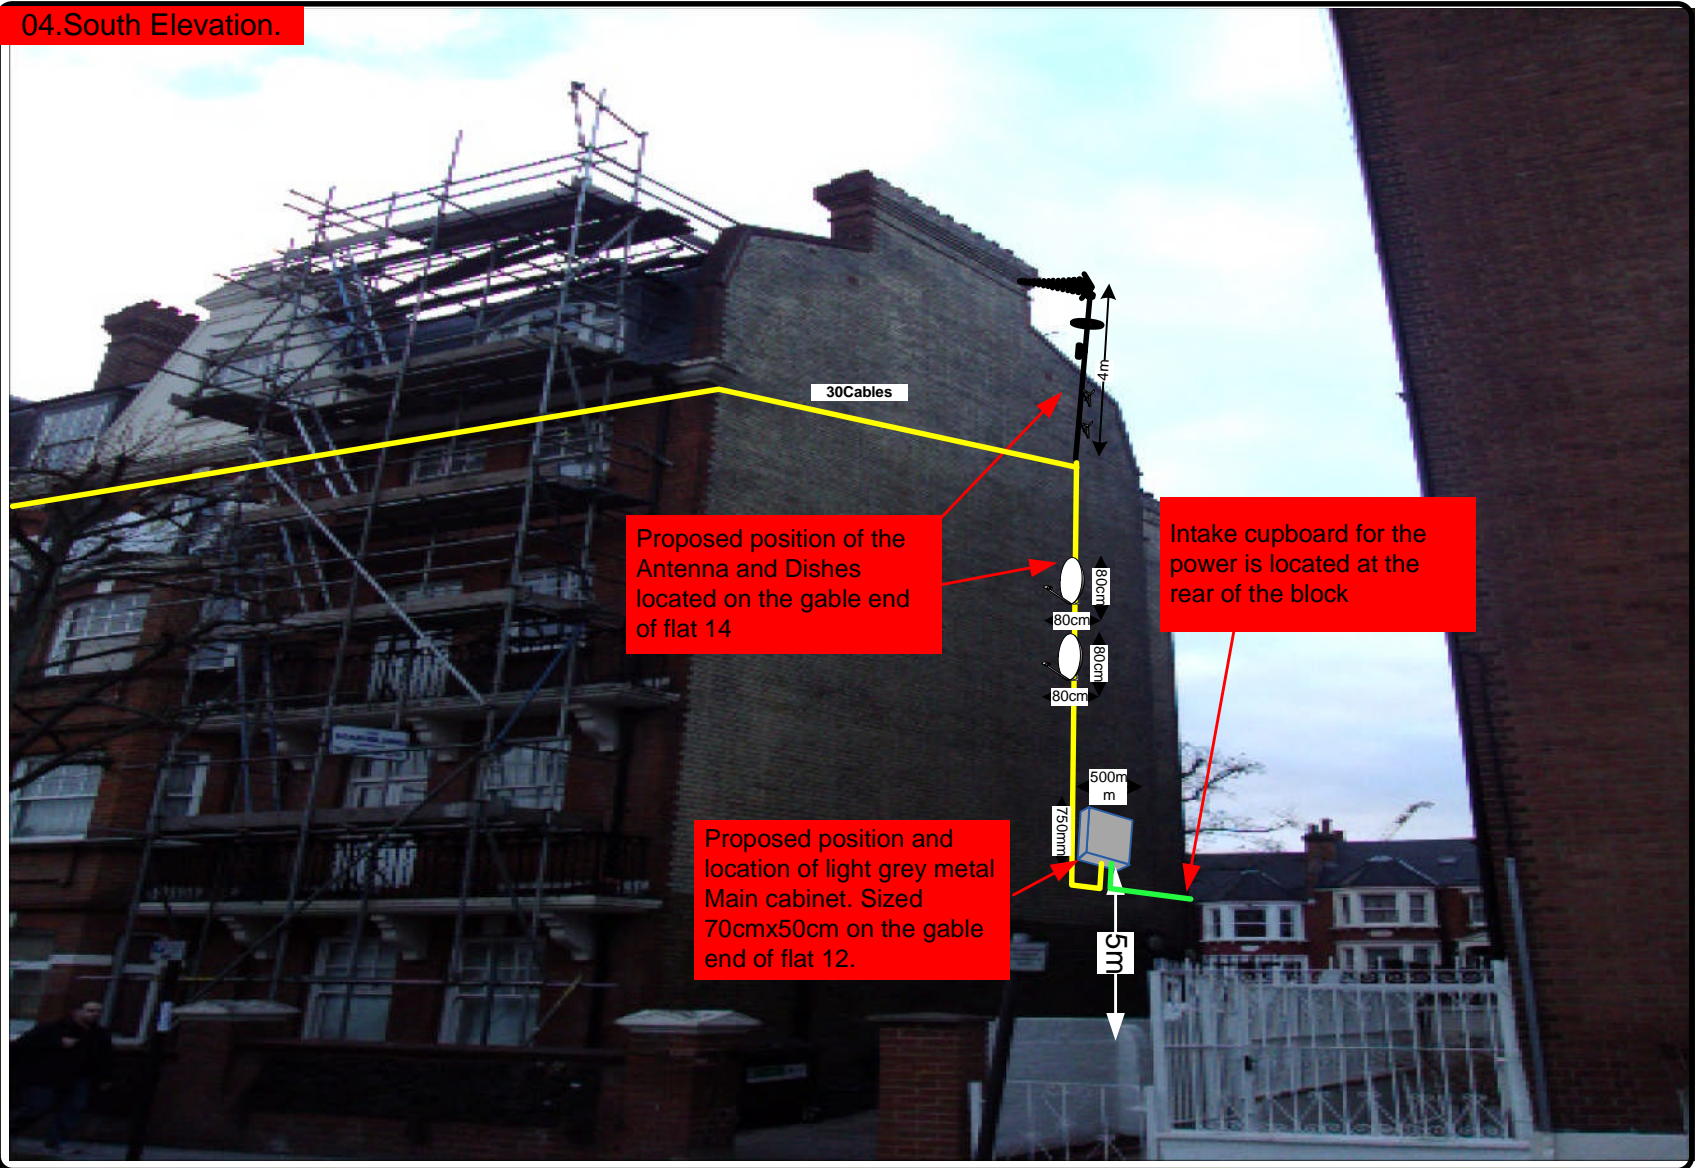

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Drawing No.	E45214/04	Site Address:	1-15 Victoria Mansions, London, NW6 1PD		
Date:	22 ND Jan 12	Site Ref:	LBC 0785.0	Surveyed By:	Paul Kenney
Number of Points:	15	System Type	9Wire IRS Sky Plus	Drawn By:	James Schroder



Each property will have two cables to lounge position.

Cable Harness sizes

2-4 cables = 15mm

6-8 cables = 20mm


10-14 cables = 30mm

16-18 Cables = 35mm

20 cables = 40mm

40 cables = 65mm

60 cables = 90mm

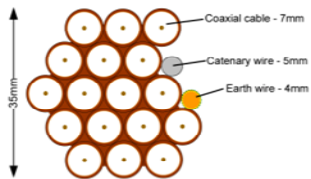

Typical loom for 16 coaxial cable + 1 earth wire, + 1 catenary wire

05. South Elevation 2

-Loom work from H/E on the gable end of flat 12 in brown PVC cables to exit the H/E and run above 4th floor. To feed flats at front wall of the building.
 -2 cables per flat at entry points.



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Date:	22 ND Jan 12	Site Ref:	LBC 0785.0	Surveyed By:	Paul Kenney
Number of Points:	15	System Type	9Wire IRS Sky Plus	Drawn By:	James Schroder



Each property will have two cables to lounge position.

Cable Harness sizes

2-4 cables = 15mm

6-8 cables = 20mm


10-14 cables = 30mm

16-18 Cables = 35mm

20 cables = 40mm

40 cables = 65mm


60 cables = 90mm

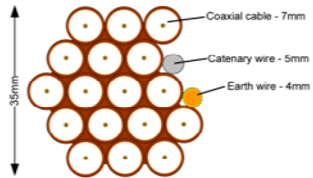

Typical loom for 16 coaxial cable + 1 earth wire, + 1 catenary wire

06. South Elevation 3

-Loom work from H/E on the gable end of flat 12 in brown PVC cables to exit the H/E and run above 4th floor. To feed flats at front wall of the building.
 -2 cables per flat at entry points.

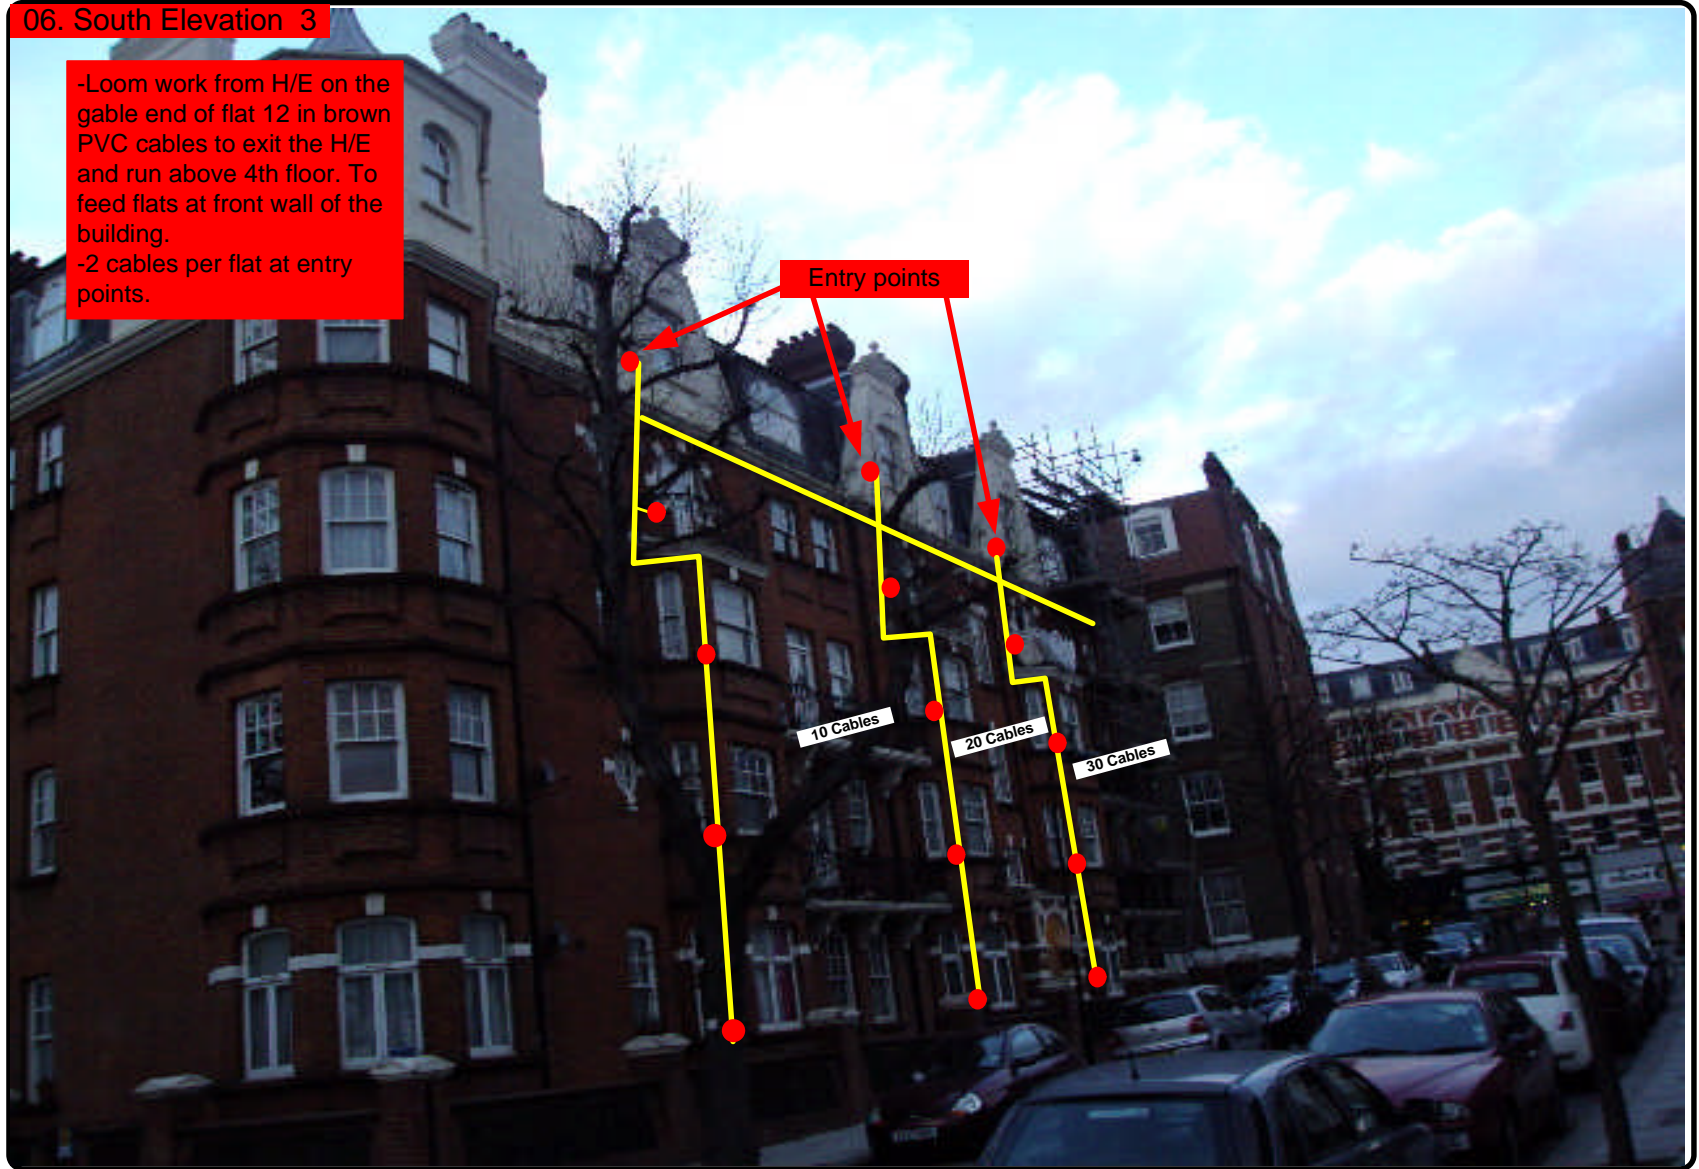

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Drawing No.	E45214/06	Site Address:	1-15 Victoria Mansions, London, NW6 1PD		
Date:	22 ND Jan 12	Site Ref:	LBC 0785.0	Surveyed By:	Paul Kenney
Number of Points:	15	System Type	9Wire IRS Sky Plus	Drawn By:	James Schroder



Each property will have two cables to lounge position.

Cable Harness sizes

2-4 cables = 15mm

6-8 cables = 20mm


10-14 cables = 30mm

16-18 Cables = 35mm

20 cables = 40mm

40 cables = 65mm

60 cables = 90mm

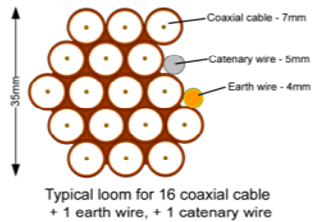

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Drawing No.	E45214/07	Site Address:	1-15 Victoria Mansions, London, NW6 1PD		
Date:	22 ND Jan 12	Site Ref:	LBC 0785.0	Surveyed By:	Paul Kenney
Number of Points:	15	System Type	9Wire IRS Sky Plus	Drawn By:	James Schroder



Each property will have two cables to lounge position.

Cable Harness sizes

2-4 cables = 15mm

6-8 cables = 20mm


10-14 cables = 30mm

16-18 Cables = 35mm

20 cables = 40mm

40 cables = 65mm

60 cables = 90mm

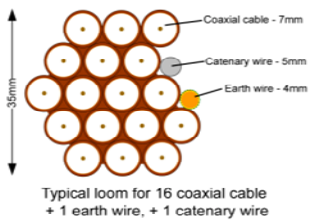

08. Existing Equipments



South Elevation



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Drawing No. E45214/08

Site Address: 1-15 Victoria Mansions, London, NW6 1PD

Date: 22ND Jan 12

Site Ref: LBC 0785.0

Surveyed By: Paul Kenney

Number of Points: 15

System Type: 9Wire IRS Sky Plus

Drawn By: James Schroder




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09. Antenna and Dishes Measurements

Digital TV,
FM & DAB Radio
Aerials

Proposed location of UHF Aerial on a 6m pole and 80cm dishes mounted on 70.5cmx50cm L-arm on the gable end of flat 14.



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Drawing No.	E45214/09	Site Address:	1-15 Victoria Mansions, London, NW6 1PD		
Date:	22 ND Jan 12	Site Ref:	LBC 0785.0	Surveyed By:	Paul Kenney
Number of Points:	15	System Type:	9Wire IRS Sky Plus	Drawn By:	James Schroder

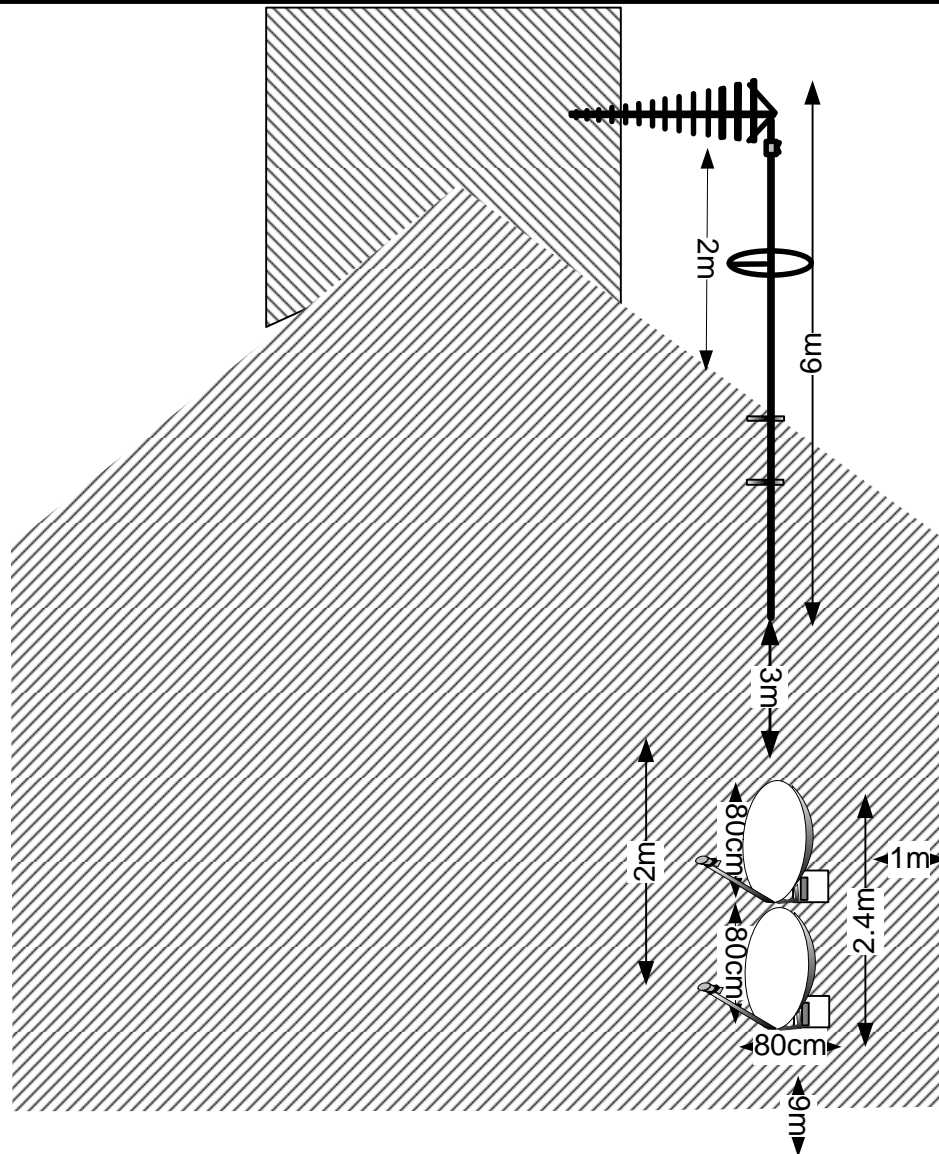