

00. INDEX

| Drawing Number | Drawing Title | Description |
|----------------|---|--|
| E45214/00 | Index | Index of Drawings. |
| E45214/01 | Location Plan | Scale 1:1250 at A4. |
| E45214/02 | Block Plan | Photo of Site from above. |
| E45214/03 | Roof Plan | Drawing of block from above, showing equipment positions. |
| E45214/04 | South Elevation 1 | Description and location of the antenna and dishes + mounting and measurements and description and location of the Main cabinet size, colour + measurements. |
| E45214/05 | South Elevation 2 | Description of Cable routes, loom sizes and entry points. |
| E45214/06 | South Elevation 3 | Description of Cable routes, loom sizes and entry points. |
| E45214/07 | South Elevation 4 | Description of Cable routes, loom sizes and entry points. |
| E45214/08 | Existing Equipments | Description, location and view of the existing equipment on site before install. |
| E45214/09 | Antenna, Dish Sizes & Typical Mounting Heights | Sketch of the Antenna and Dishes + mounting, position and height. |

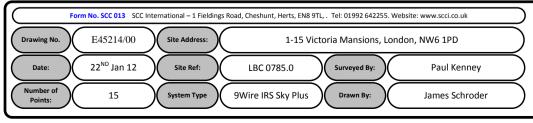




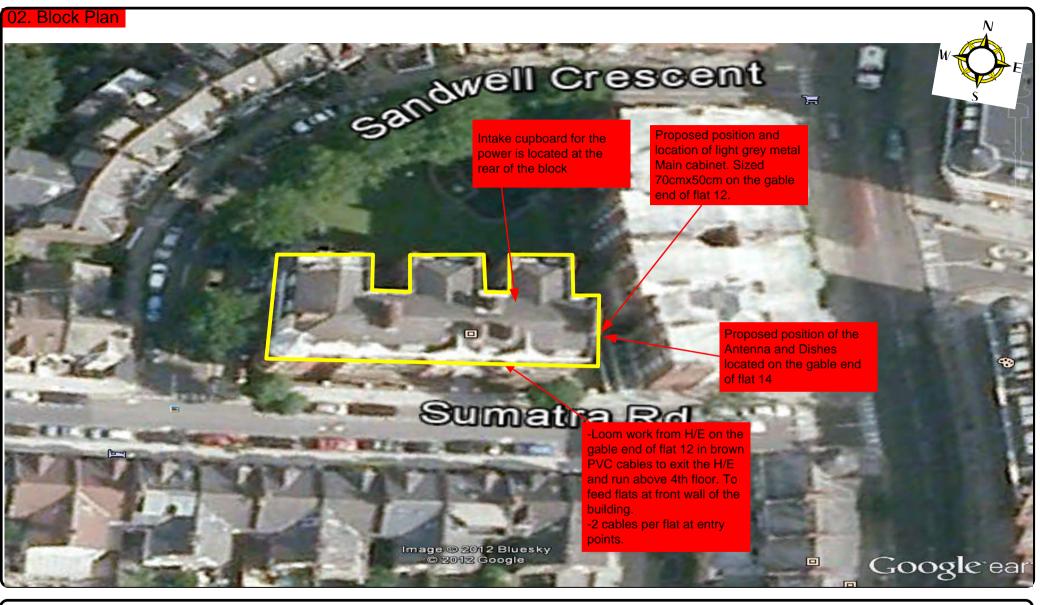





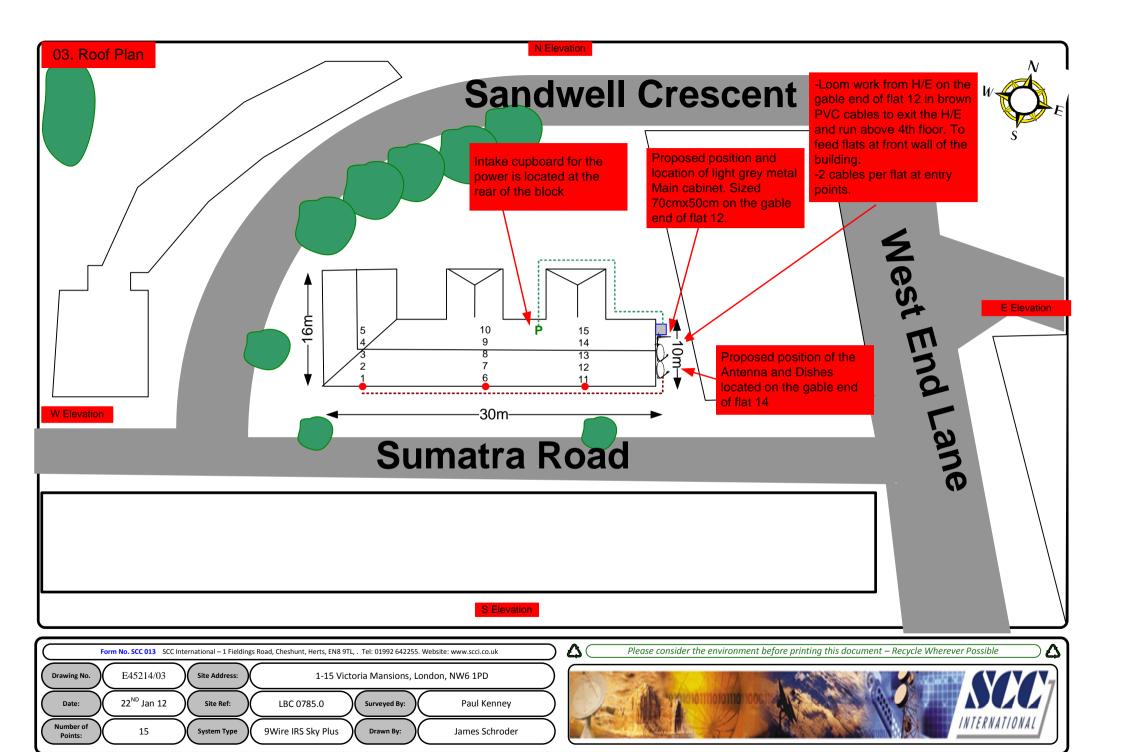

Cable Harness sizes

2-4 cables = 15mm

6-8 cables = 20mm


10-14 cables = 30mm

16-18 Cables = 35mm


20 cables = 40 mm


40 cables = 65 mm

60 cables = 90 mm

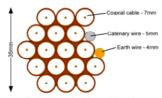

Typical loom for 16 coaxial cable + 1 earth wire, + 1 catenary wire

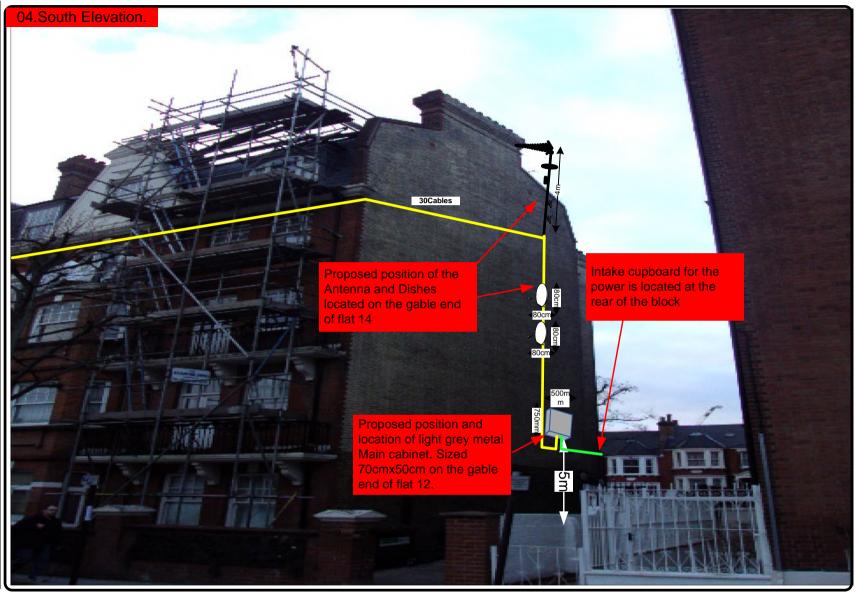

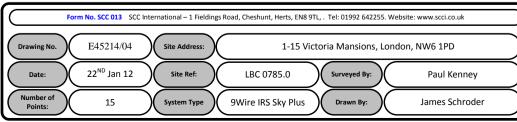



Cable Harness sizes

2-4 cables = 15mm

6-8 cables = 20mm


10-14 cables = 30mm

16-18 Cables = 35mm


20 cables = 40 mm

40 cables = 65 mm

60 cables = 90mm

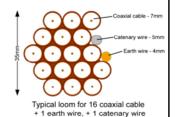



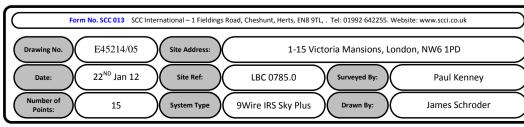



Cable Harness sizes

2-4 cables = 15mm

6-8 cables = 20mm


10-14 cables = 30mm

16-18 Cables = 35mm


20 cables = 40 mm

40 cables = 65 mm

60 cables = 90 mm

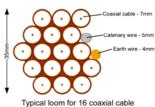

Typical loom for 16 coaxial cable + 1 earth wire, + 1 catenary wire

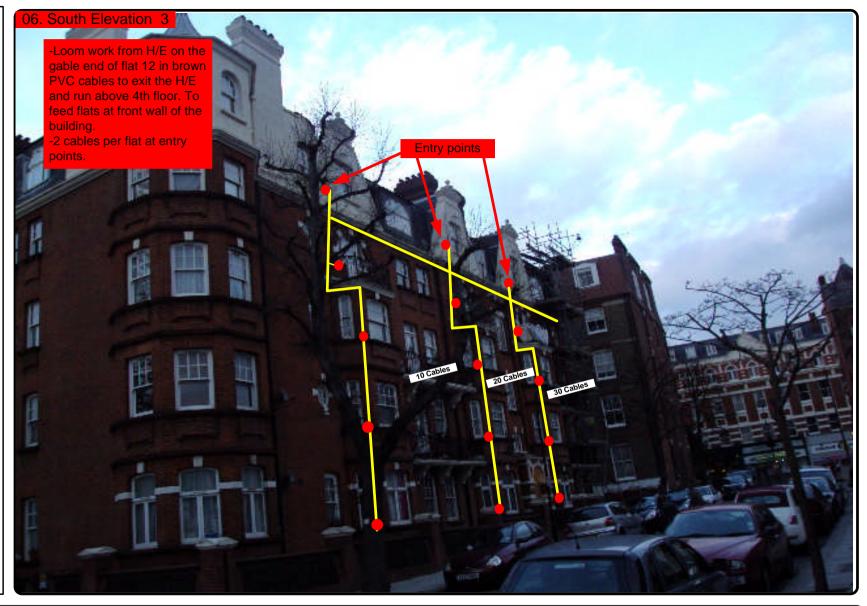





Cable Harness sizes

2-4 cables = 15mm

6-8 cables = 20mm


10-14 cables = 30mm

16-18 Cables = 35mm

20 cables = 40 mm


40 cables = 65 mm

60 cables = 90 mm

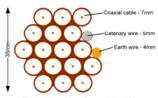

Typical loom for 16 coaxial cable + 1 earth wire, + 1 catenary wire



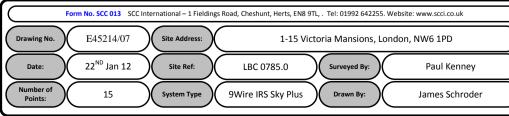



Cable Harness sizes

2-4 cables = 15mm

6-8 cables = 20mm


10-14 cables = 30mm

16-18 Cables = 35mm

20 cables = 40 mm


40 cables = 65mm

60 cables = 90mm

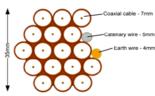

Typical loom for 16 coaxial cable + 1 earth wire. + 1 catenary wire



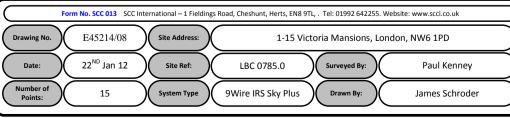





Proposed location of UHF Aerial on a 6m pole and 80cm dishes mounted on 70.5cmx50cm L-arm on the gable end of flat 14.

