





1 ALMA STREET OS PLAN
Scale: 1:1250




2 ALMA STREET BLOCK PLAN
Scale: 1:1250

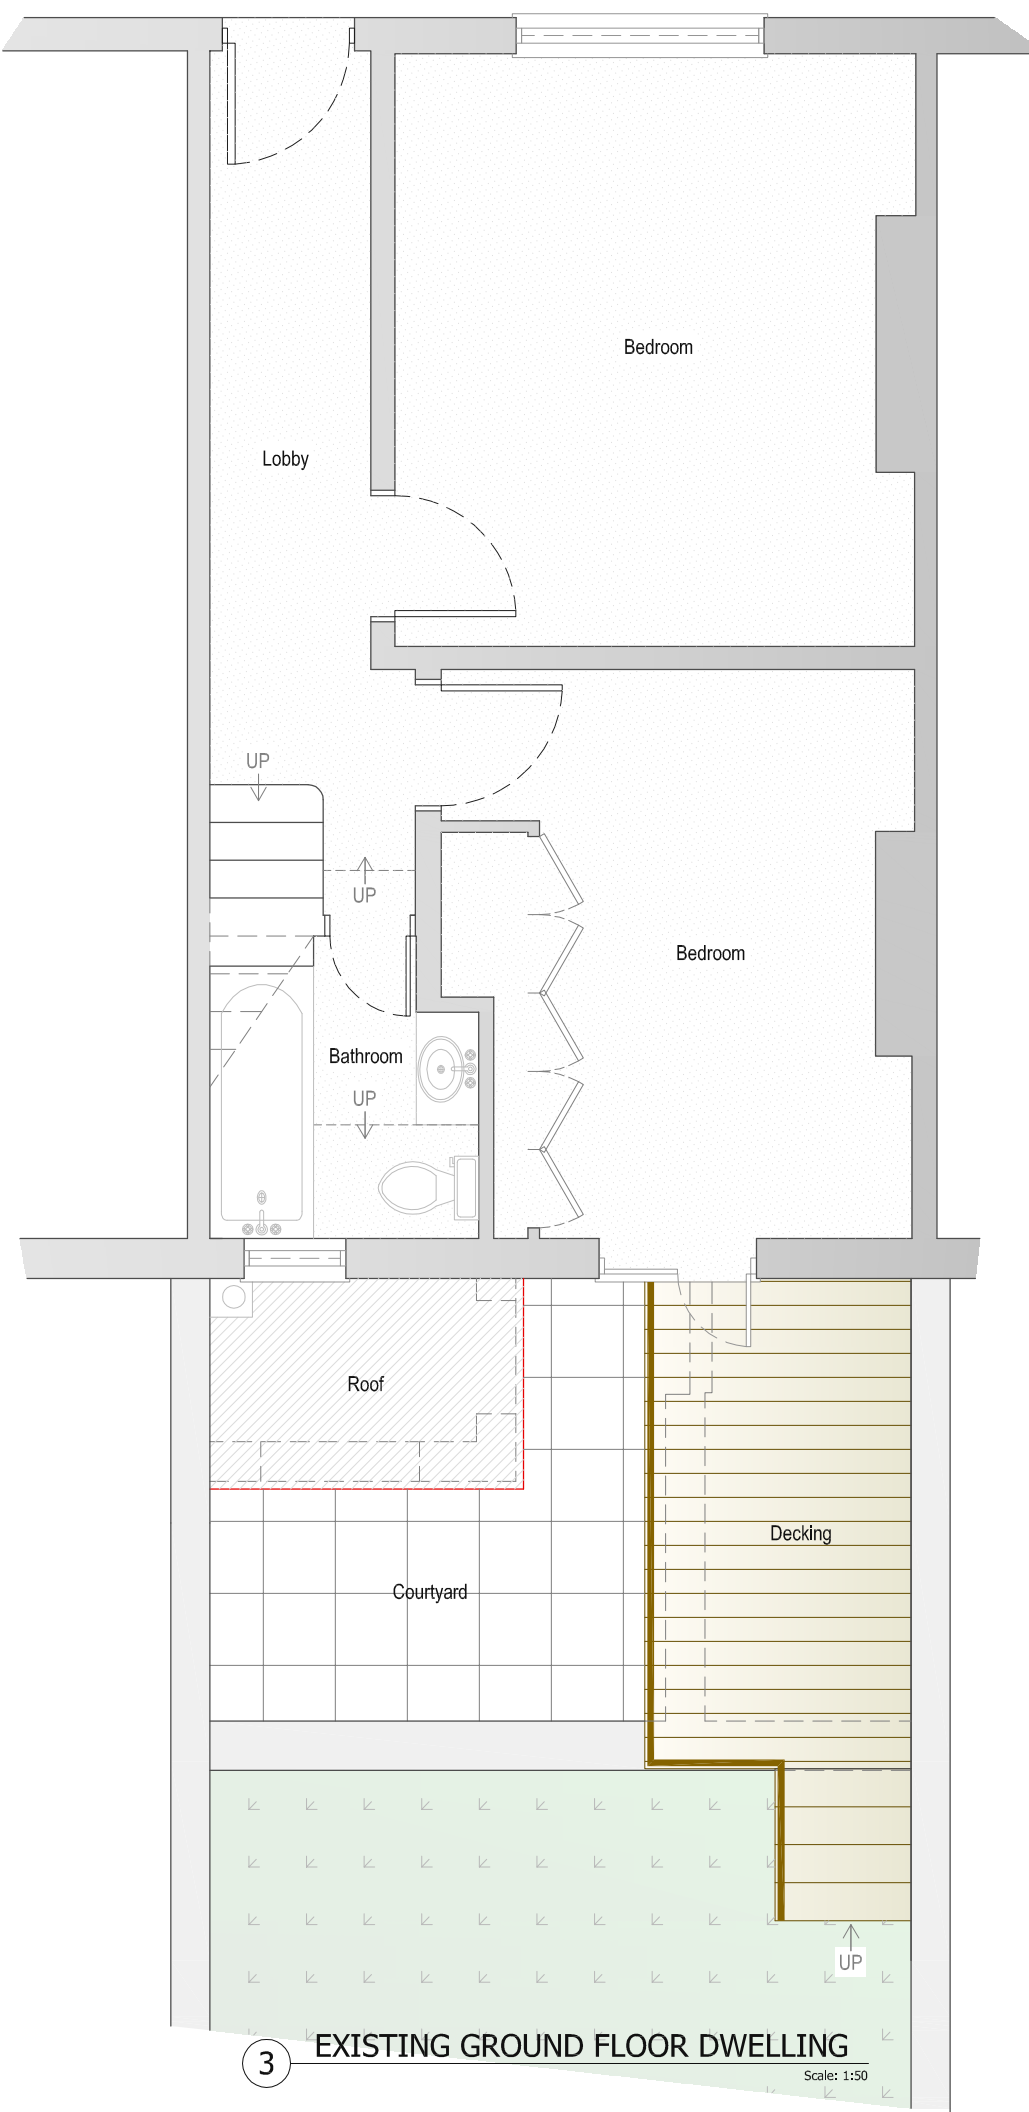


3 EXISTING GROUND FLOOR DWELLING
Scale: 1:150

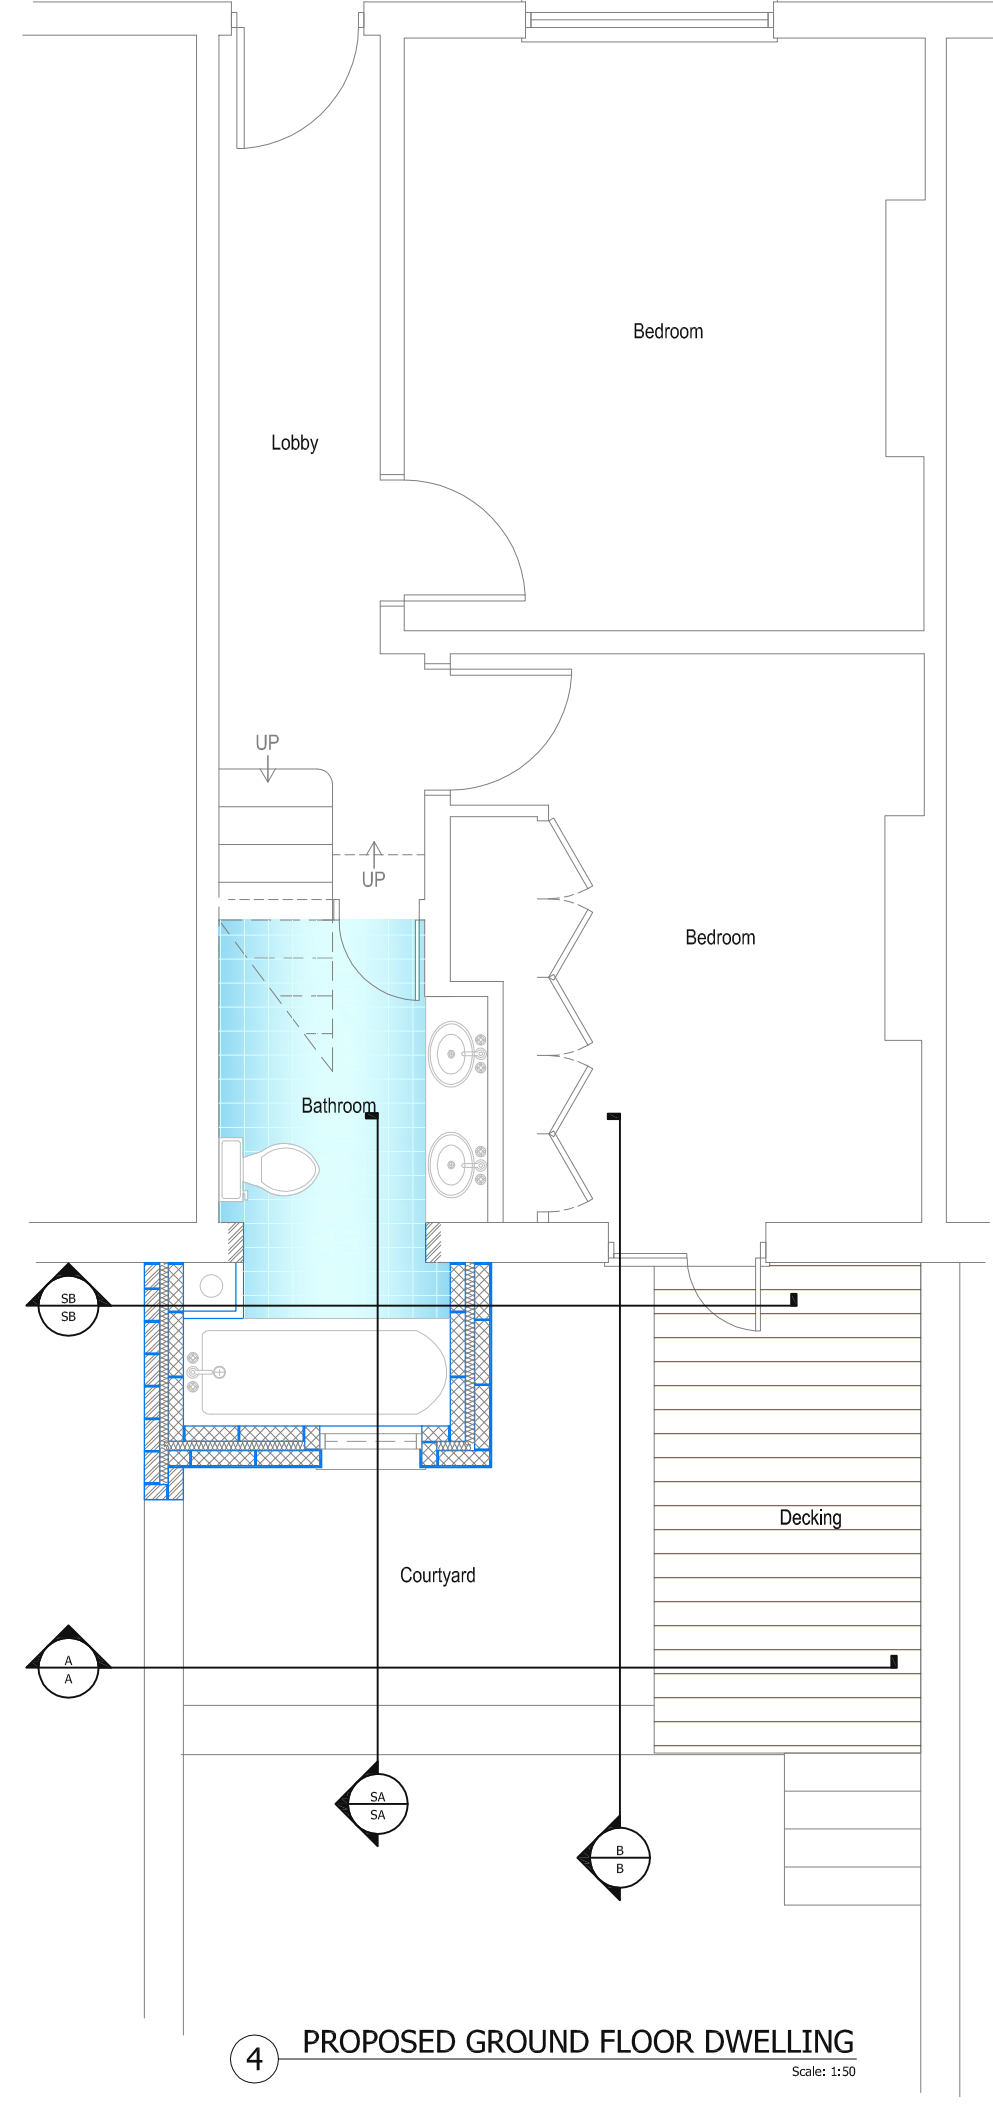


4 PROPOSED GROUND FLOOR DWELLING
Scale: 1:150

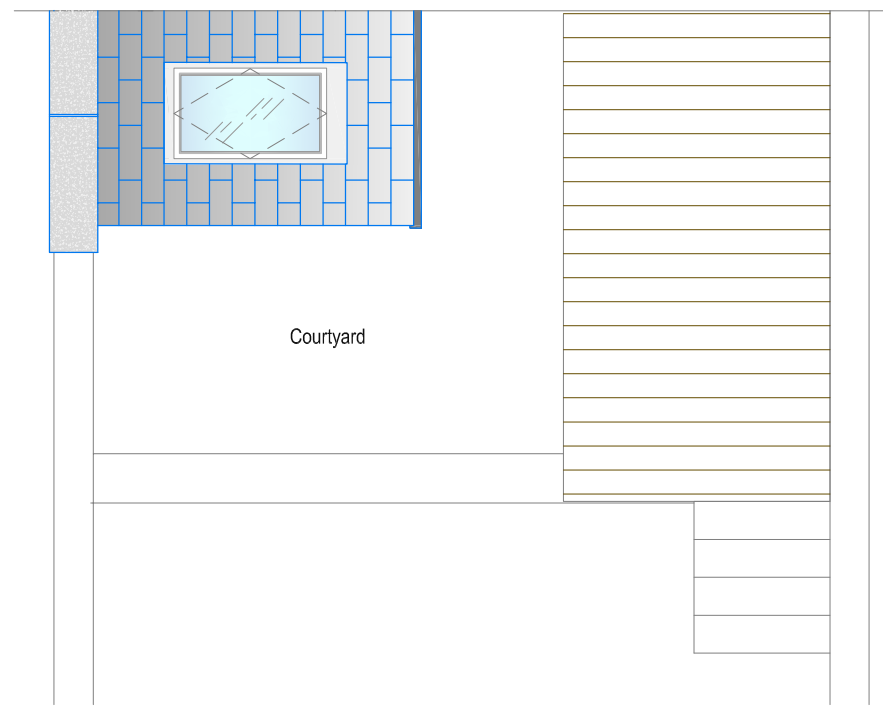


5 PROPOSED ROOF PLAN
Scale: 1:150

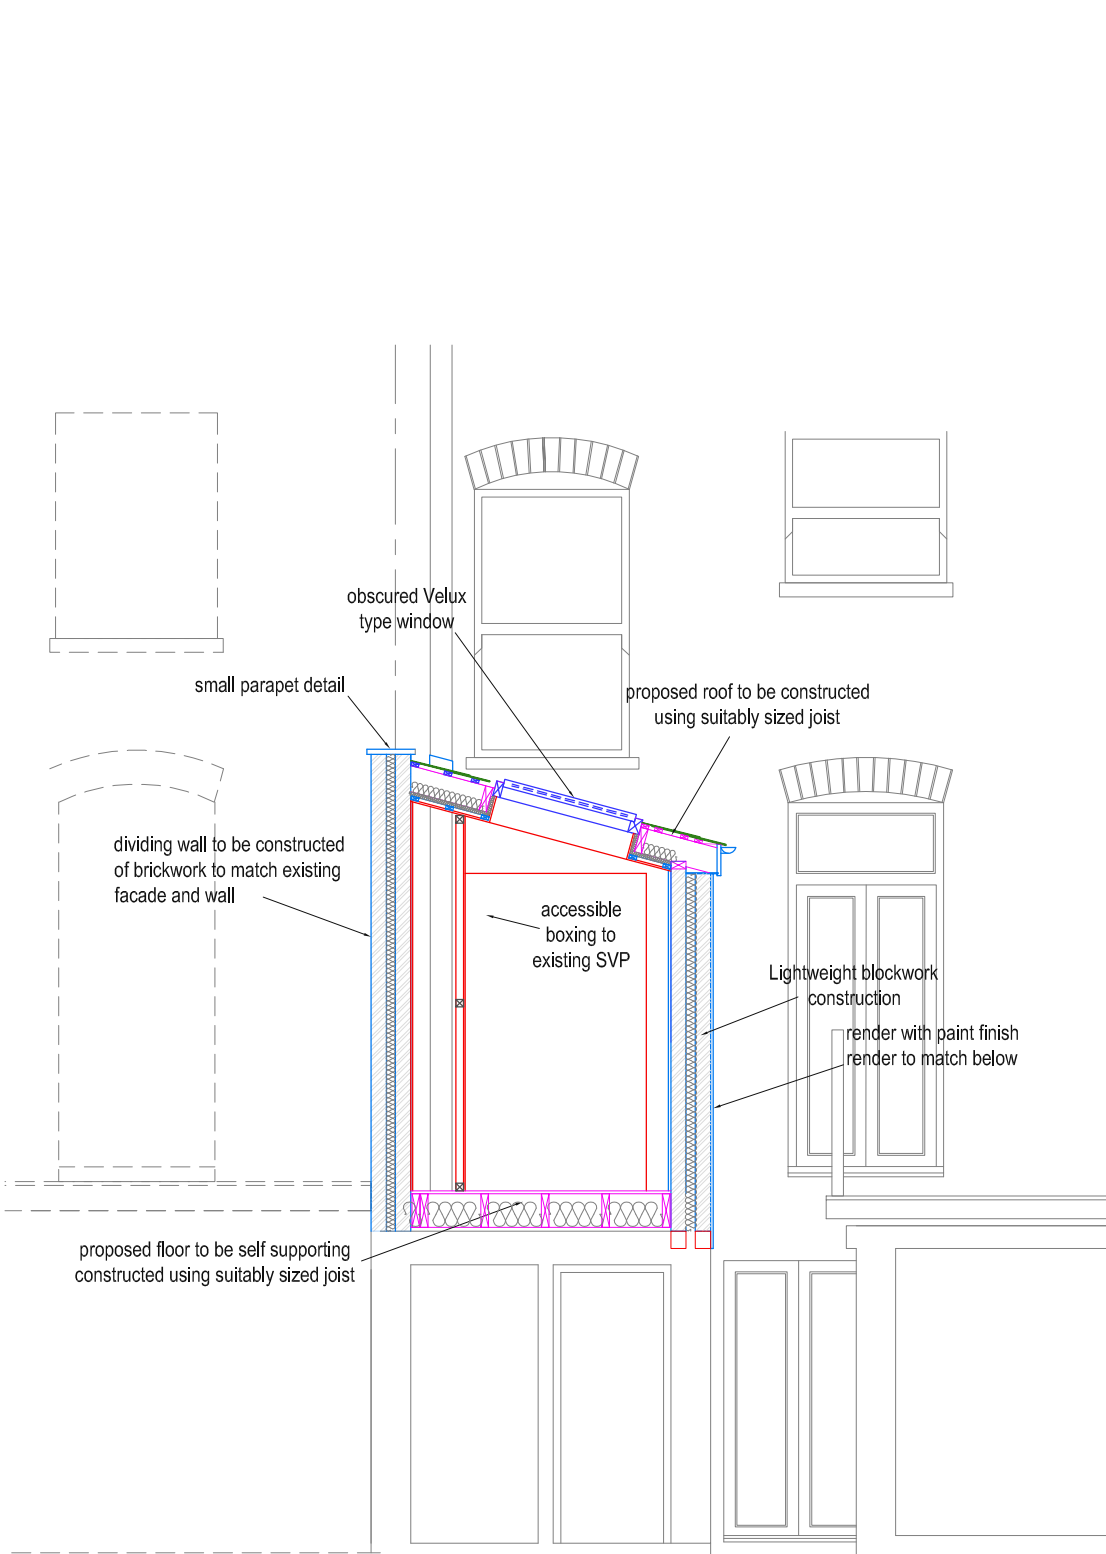


SB SECTION B
Scale: 1:150

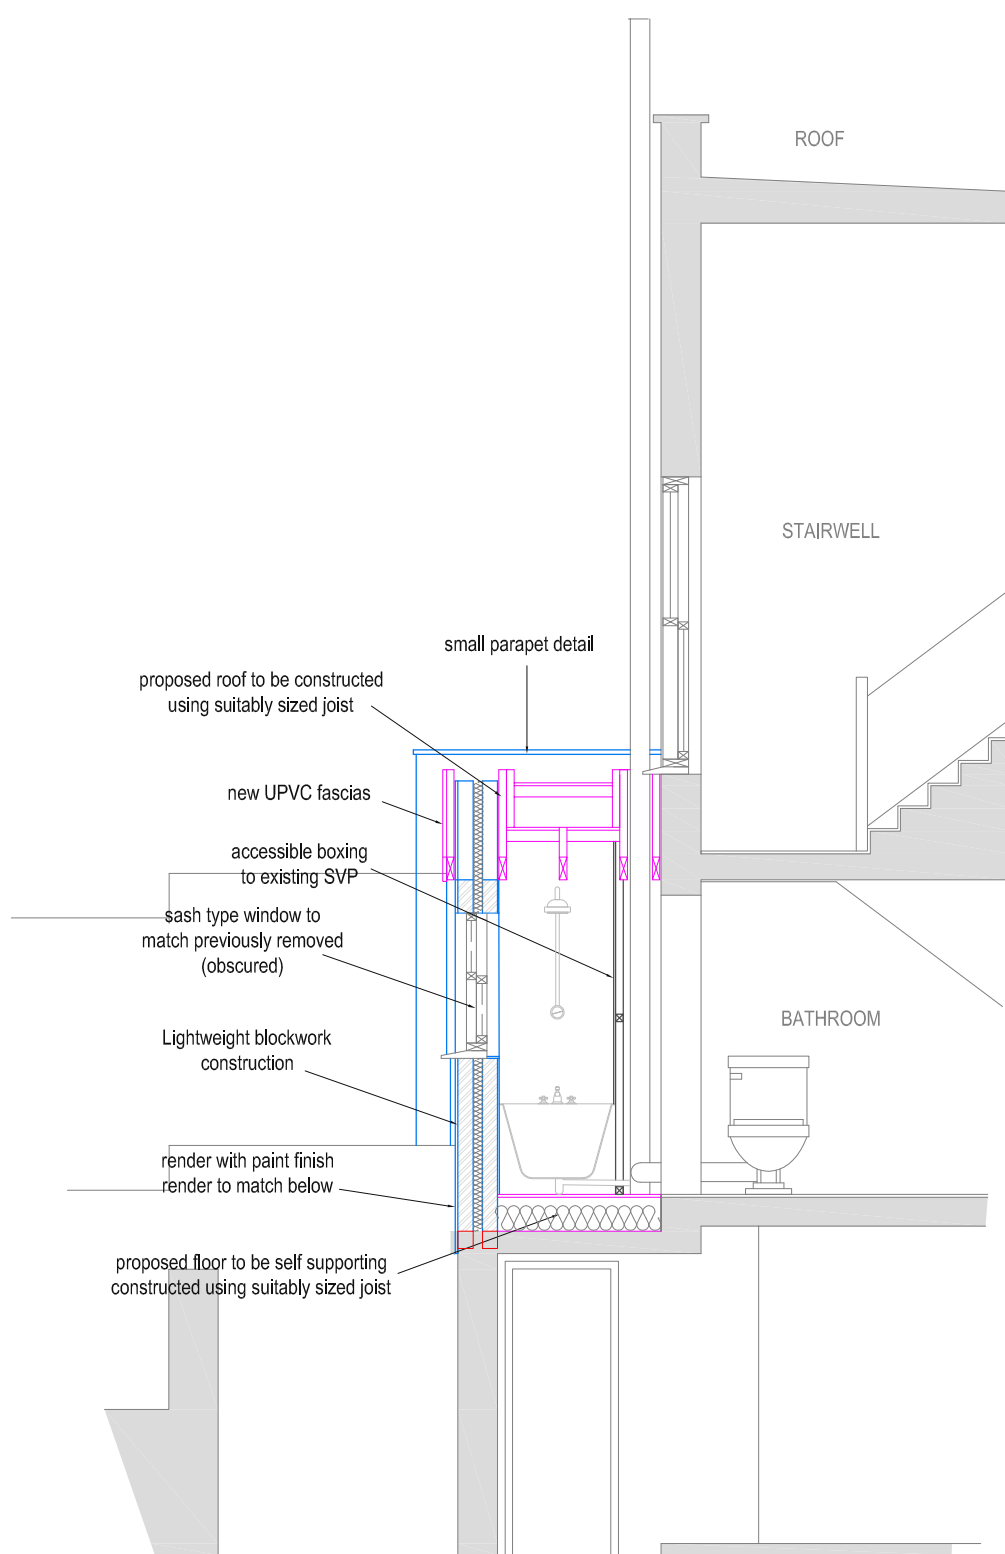

SA SECTION A
Scale: 1:150

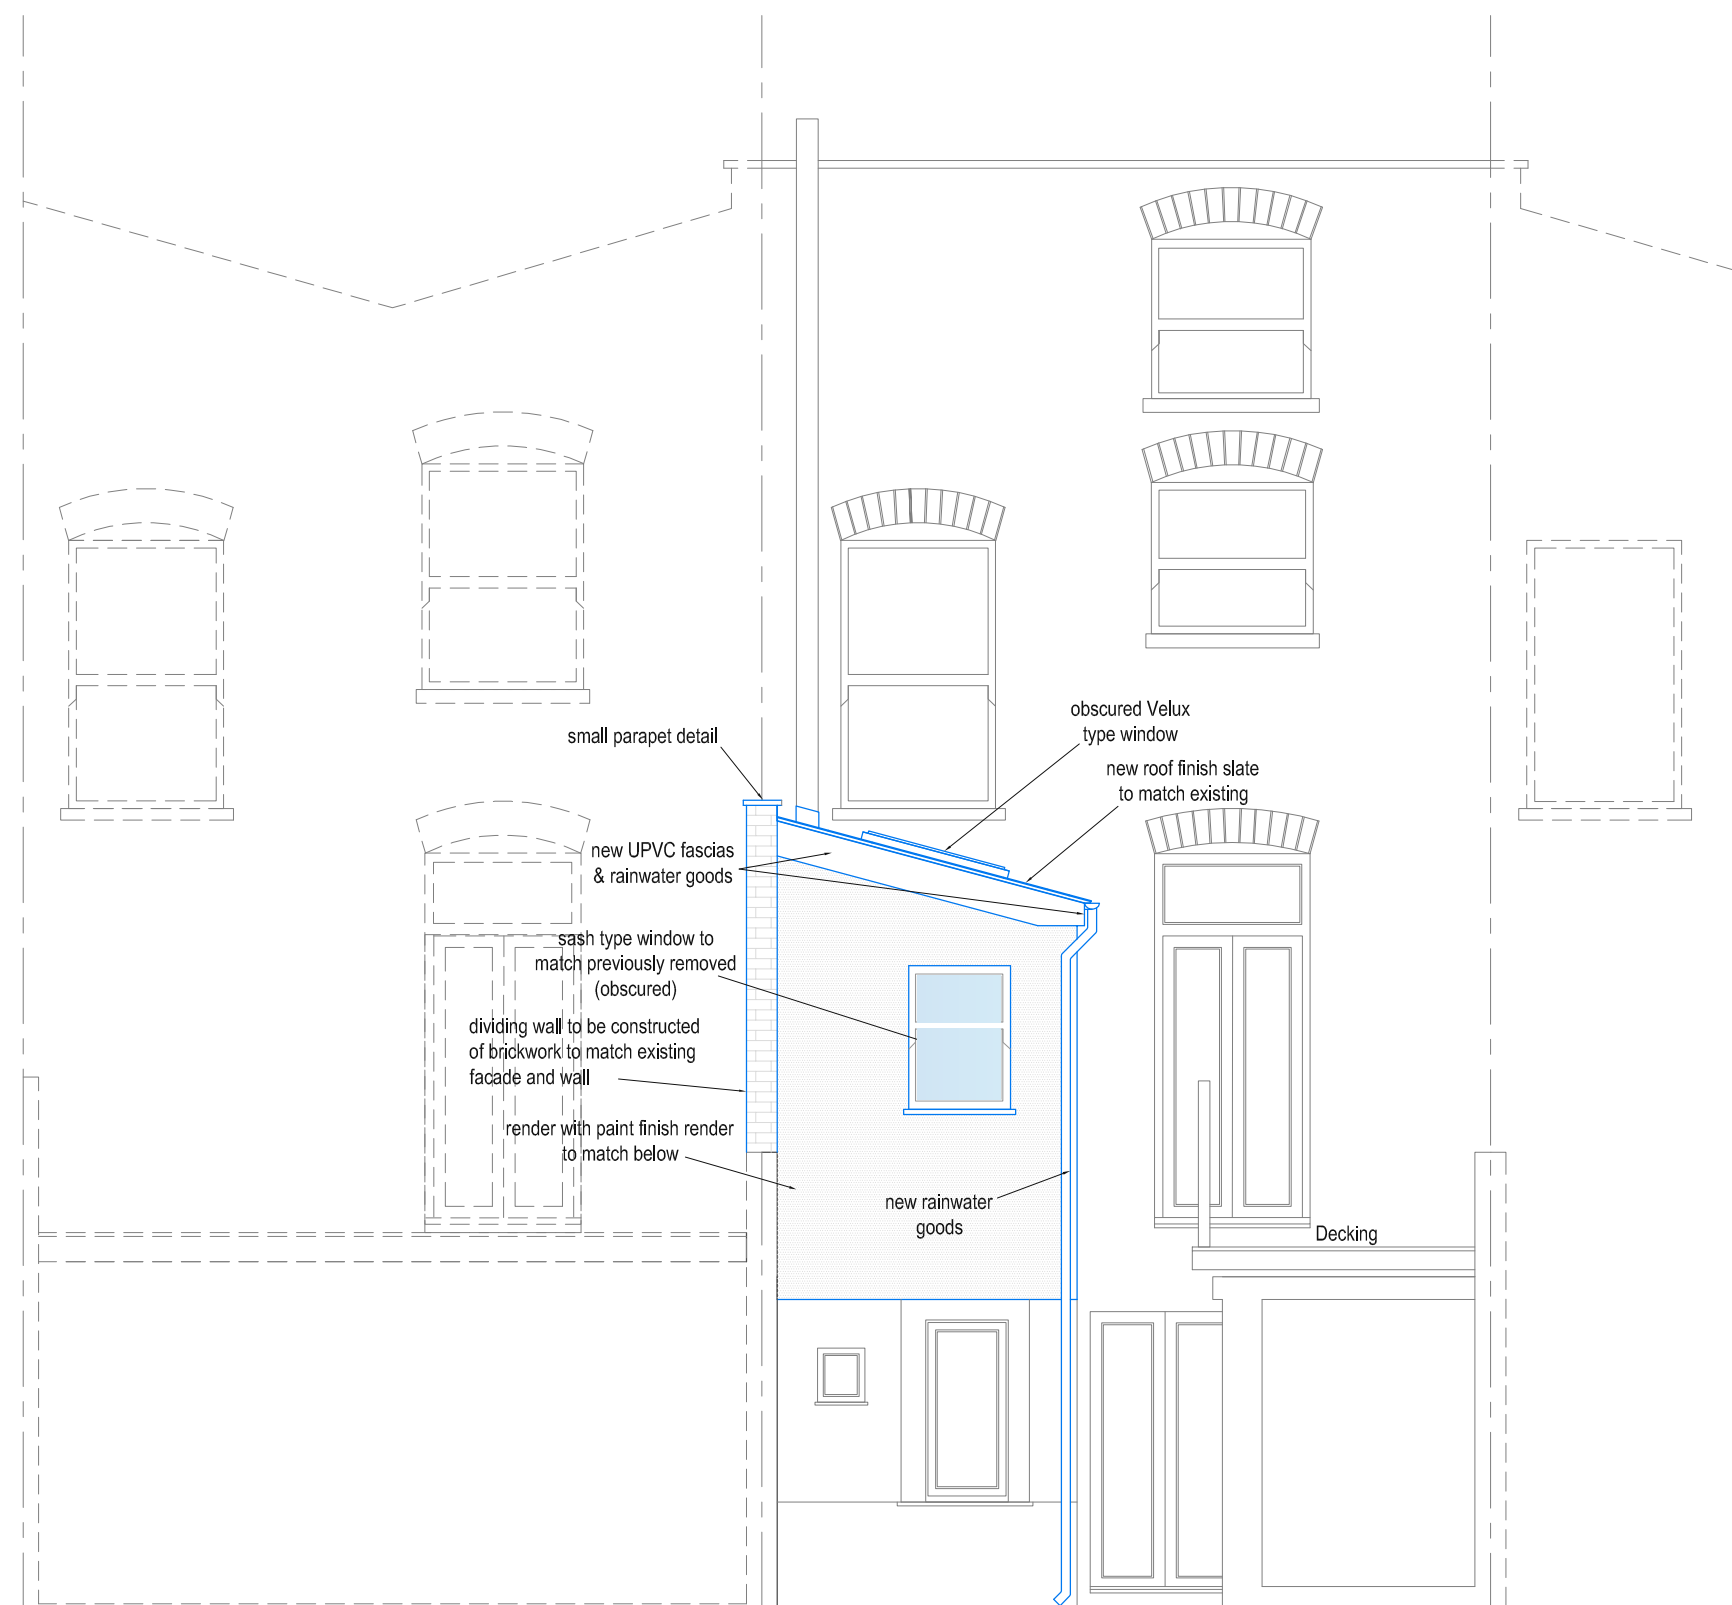

A-A PROPOSED REAR ELEVATION
Scale: 1:150

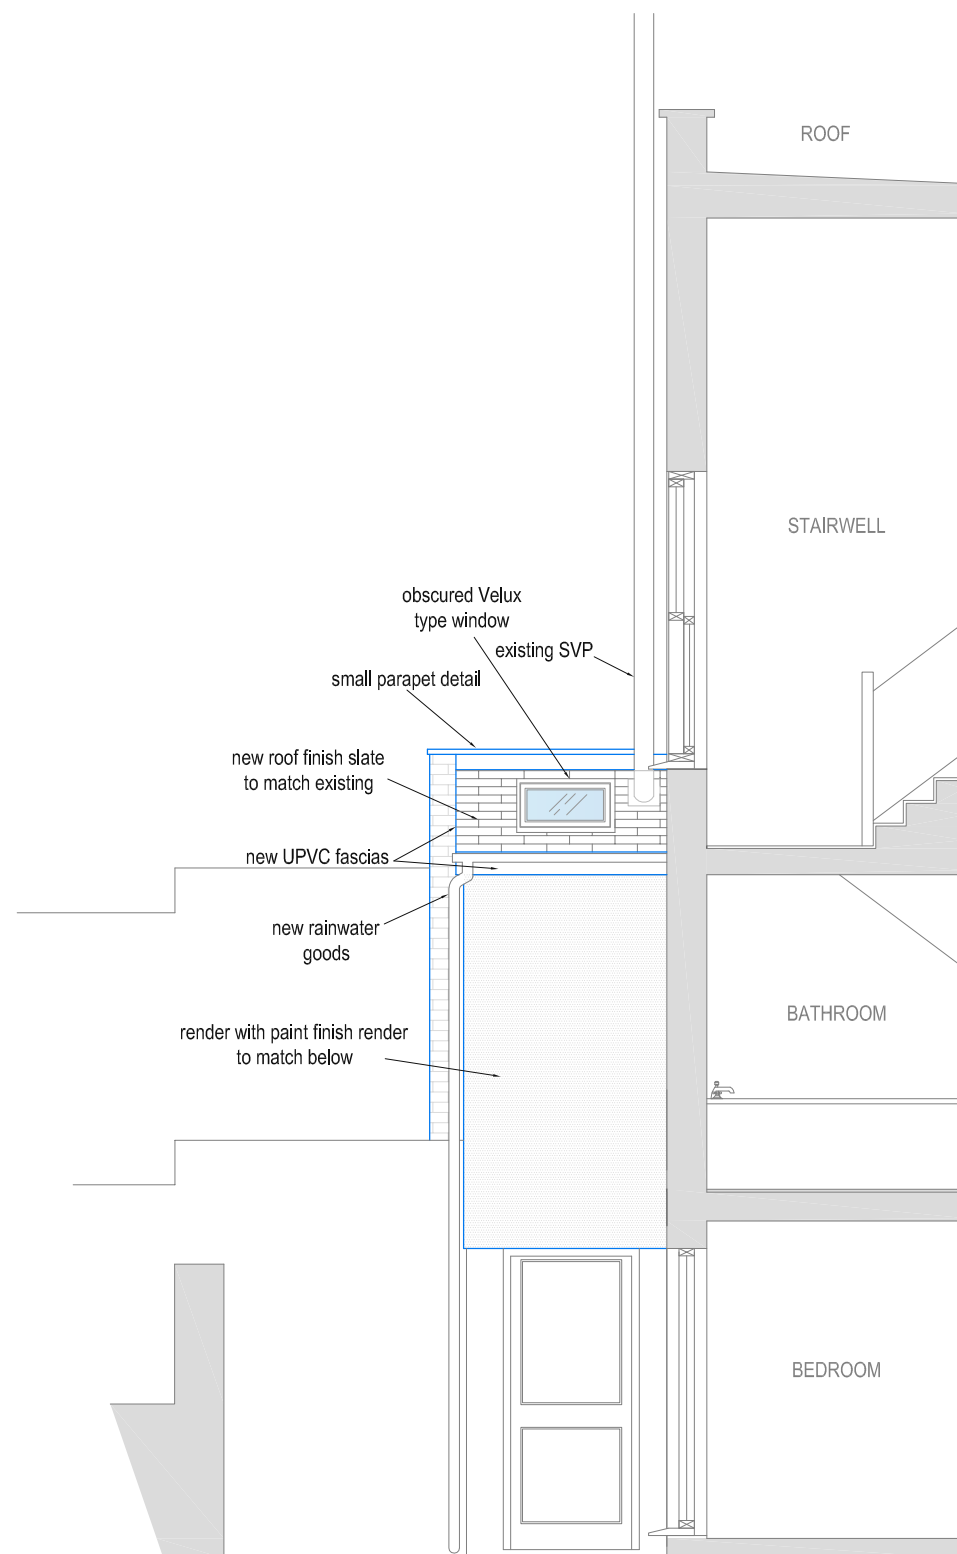

B-B PROPOSED SIDE ELEVATION
Scale: 1:150

DO NOT SCALE THIS DRAWING. CHECK ALL DIMENSIONS ON SITE.
This drawing is to be read in conjunction with all relevant specifications and drawings issued. For discrepancies or omissions contact the client.
The contractor is to check and verify all building and site dimensions and check levels before work commences.

Date:	Revised:	Dr:
Client:	CAROLINE GAYWOOD	
Drawing Issue:	PLANNING	
Project:	30 ALMA ROAD PROPOSED EXTENSION	
Drawing Title:	EXISTING & PROPOSED PLANS ELEVATIONS & SECTIONS	
Scale:	Drawing Nr:	ALMA002
Drawn:	Authorised by:	CO
Revised:	Date:	MAY 2012
Drawing Ref:		