Site No. GLN7446 Site Name. LAMPOST WEST HEATH ROAD

	DAY	17											
	MONTH	05											
DRAWING LIST	YEAR	12											
PLANNING	DRG No.	RE	REVISION:										
DRAWING TRANSMITTAL SHEET	DTS	ü											
LOCATION PLANS	GLN7446/GA/101	А											
SITE PLANS	GLN7446/GA/102	А											
SITE ELEVATIONS	GLN7446/GA/103	А											
EQUIPMENT LAYOUT	GLN7446/GA/104	А											
EQUIPMENT LAYOUT	GLN7446/GA/200	А											
OTHER DOCUMENTS:													
SCHEDULE 'E' RISK ASSESSMENT													
DSR													

DISTRIBUTION & NUMBER OF COPIES

DISTRIBUTION	COMPANY	MEDIA								
Site File	OPCS	E-Mail	ü							
Gary Lanahan	Galliford Try	E-Mail	ü							
RECORD COPY			ü							

PURPOSE OF ISSUE

PLANNING	ü							
CONSTRUCTION								
LEGAL								
AS BUILT								
INFORMATION								



Everything Everywhere Ltd Hatfield Business Park Hatfield AL10 9BW

Site No. GLN7446

WEST HEATH ROAD HAMPSTEAD LONDON NW3 7XD



ICNIRP DESIGN CLASSIFICATION: PUBLIC

Declaration of Conformity with ICNIRP Public Exposure Guidelines ("ICNIRP Declaration")



Everything Everywhere Ltd Hatfield Business Park Hatfield AL10 9BW

Certifies that the proposed equipment and installation as detailed in drawing numbers GLN7446/GA/101-104 inclusive within the attached planning/GPDO application at:

WEST HEATH ROAD HAMPSTEAD LONDON NW3 7XD

is designed to be in full compliance with the requirements of the radio frequency (RF) public exposure guidelines of the International Commission on Non-Ionising Radiation Protection (ICNIRP), as expressed in EU Council recommendation of 12 July 1999 * "on the limitation of exposure of the general public to electromagnetic fields (0 Hz to 300 GHz)"

*Reference:

Date: 17th May 2012

Signed:

For and on behalf of Everything Everywhere Ltd

Name: Chris Padfield Position: Design Engineer Company: Infra Projects

ICNIRP Design Declaration

Orange Statement

Orange policy is to abide by compliance limits set by ICNIRP for both PUBLIC and Occupational environments. The ICNIRP PUBLIC recommendations have been interpreted by the European Commission and this guidance accepted by the UK government and the IEGMP (Stewart Report). All operators in the UK will now work to these guidelines for PUBLICLY accessible areas.

Due to the wide variety of equipment, design configurations and potential future upgrades that need to be considered in order to prove compliance with the ICNIRP PUBLIC recommendations Orange have included Site Design Requirements in Spec1838 and Spec201.

Orange PCS Ltd. can confirm that when a site is designed and constructed strictly in accordance with these documents, it will satisfy the compliance limits set by ICNIRP for PUBLIC environments.

				T.Smith								
				Design Manager - Access Network								
				EverythingEverywhere Ltd								
Designers Stat	<u>ement</u>											
This is to confi	rm that:											
Site No. GLN7446 Site Name LAMPOST WEST HEATH ROAD												
				Upgrade No.								
Designed On	17.05.12		Ву:	Chris Padfield								
	e following drav	wings:	Α	GLN7446/GA/101 - LOCATION PLANS								
(Include all rev	ision numbers)		Α	GLN7446/GA/102 - SITE PLANS								
			Α	GLN7446/GA/103 - SITE ELEVATIONS								
			Α	GLN7446/GA/104 - EQUIPMENT LAYOUT								
			Α	GLN7446/GA/200 - EQUIPMENT LAYOUT								

This site is designed in accordance with Orange Documentation:


Spec1838 RF Exposure for Orange Sites - Design Guide Spec201 Safety & Information Signage Specification Version current at design date given above.


ICNIRP ACCESS CLASSIFICATION	ICNIRP DESIGN CLASSIFICATION
PUBLIC	PUBLIC


With no variations:

Note - full details of any variations must be attached and signed by the Orange Network Planner as being required and meeting the compliance limits set by ICNIRP for PUBLIC environments.

Signed:	Print Name:	Company Address:
1.h	Chris Padfield	Infra Projects
Position:	Date:	4200 Waterside Centre, Solihull Parkway, Birmingham Business Park, Birmingham, B37 7YN
Design Engineer	17.05.12	Tel: +44 (0121) 717 4771

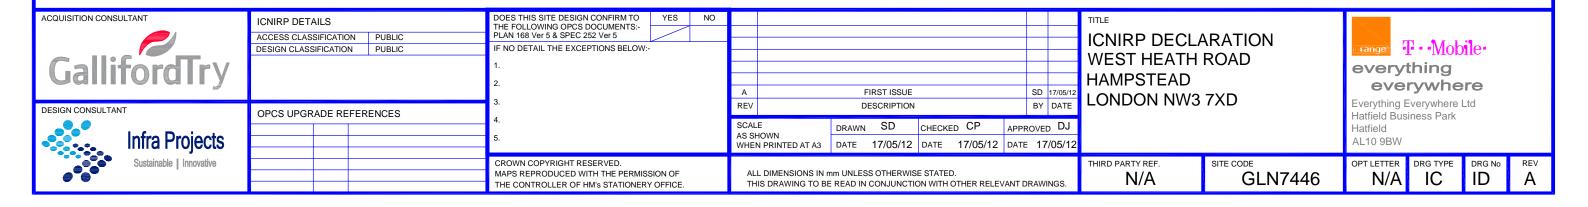

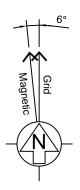

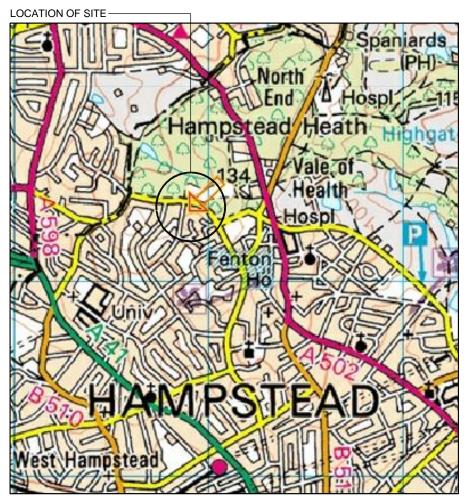


LOCATION PLAN


BASED UPON 1:50000 LANDRANGER MAP SERIES SCALE 1:50000

CROWN COPYRIGHT RESERVED. REPRODUCED WITH THE PERMISSION OF THE CONTROLLER OF H.M STATIONARY OFFICE


DIRECTIONS TO SITE:


Head southeast on M1. Take the A406 (E) ramp to N. Circular/C. London/Wood Green/Golders Green 0.2 mi. Merge onto N Circular Rd/A406 0.2 mi. Take the A41 exit toward Aylesbury/Centre London W 0.1 mi. At the roundabout, take the 3rd exit onto Brentfield Gardens 0.3 mi. Take the ramp onto Brent Cross Flyover/A41 Continue to follow A41 1.4 mi. Turn right onto Finchley Rd/A41 0.1 mi. Sharp left onto Platt's Ln Go through 1 roundabout 0.5 mi. Continue onto W Heath Rd Destination will be on the right

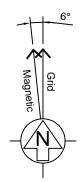


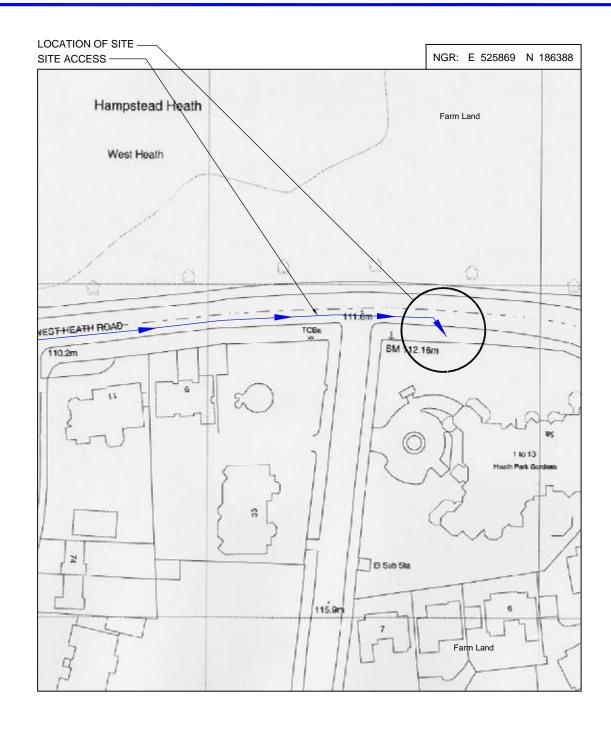


BLOCK PLAN SCALE 1:1250

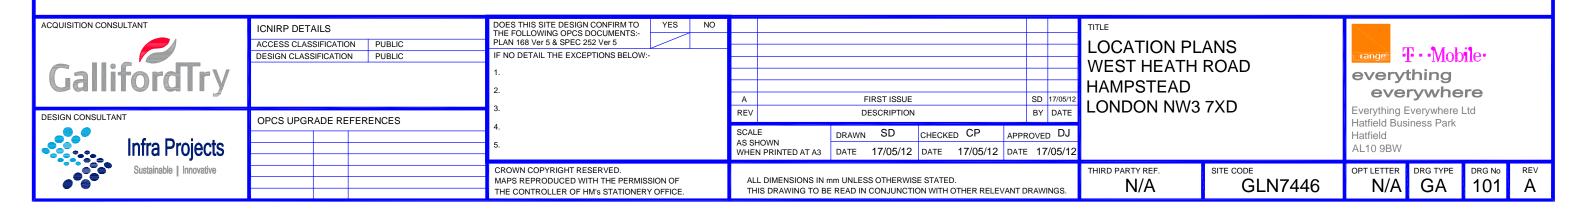


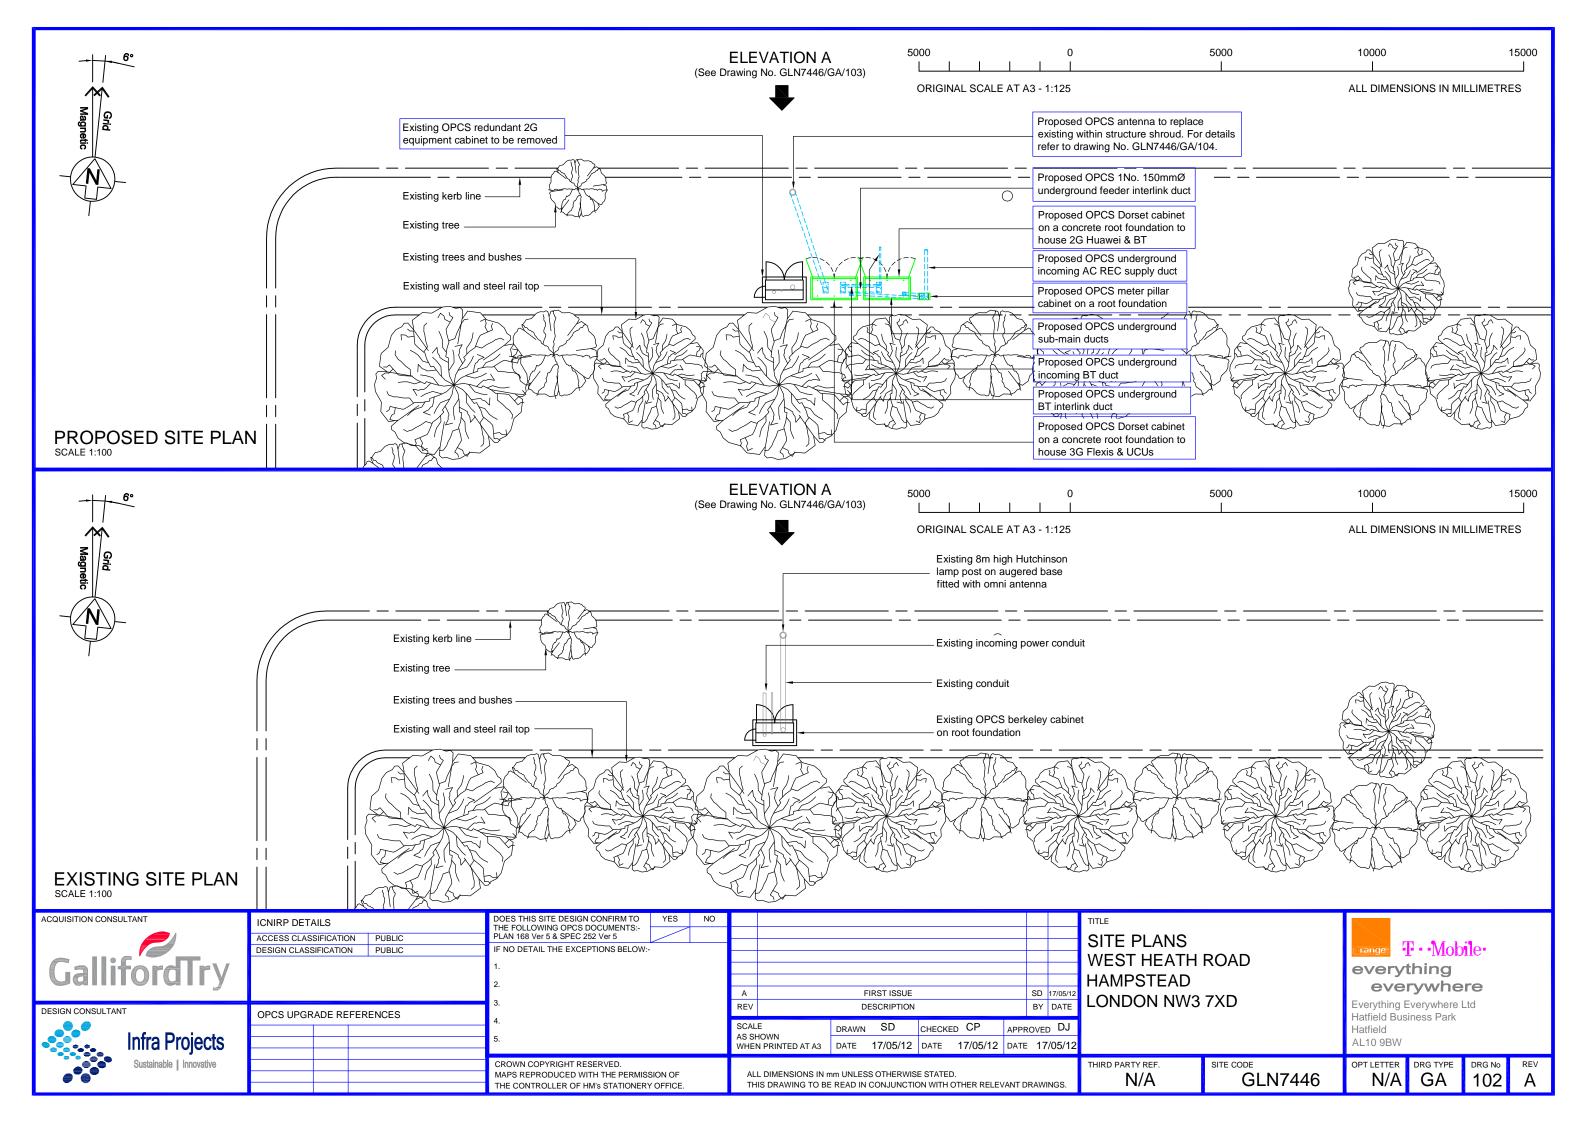


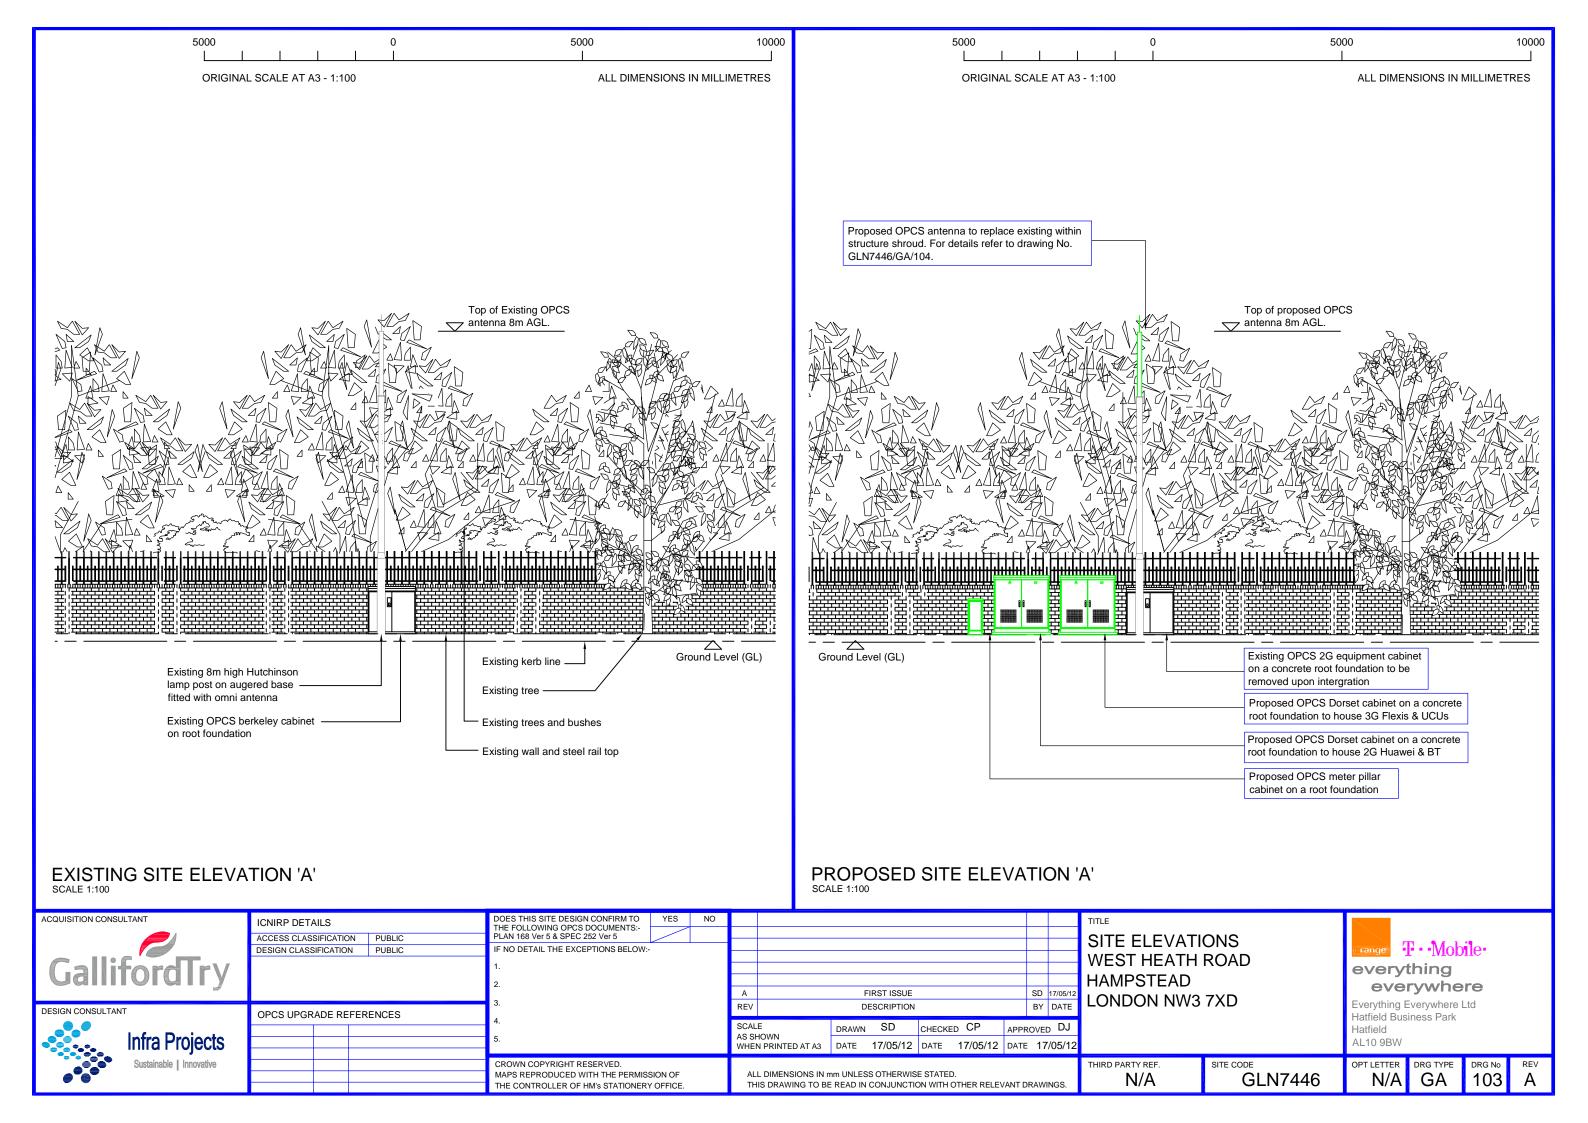

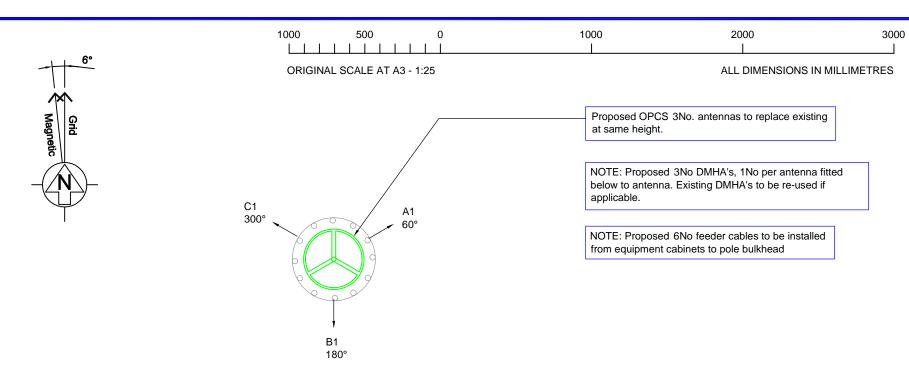

PROPOSED PLAN VIEW OF OPCS ANTENNA AT 8m AGL

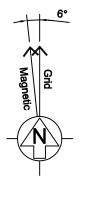

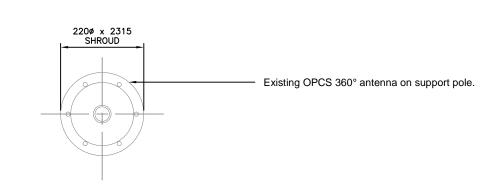

	EXISTING OPCS ANTENNA TO BE SWAPPED OUT														
ITEM	ANTENNA REF	FUNCTION	TYPE/SECTOR	BEAR		HEIGHT TO TOP OF ANTENNA FROM G/L	DOWN TILT	MHA'S (R IF REMOTE)	FEEDER TYPE	FEEDER LENGTH	No OF FEEDERS				
1	A1	TX/RX	IK0103A_360_3	0°- 360	° EGN	8.0m	-	-	LDF4-50	< 12.0m	2				
-	-	-	-	-		-	-	-	-	-	-				
-	-	-	-	-		-	-	-	-	-	-				
-	-	-	-	-		-	-	-	-	-	-				
-	-	-	-	-		-	-	-	-	-	-				
-	-	-	-	-		-	-	-	-	-	-				
			PF	ROPOS	SED OPCS ANTENNA KEY										
ITEM	ANTENNA REF			RING	HEIGHT TO TOP OF ANTENNA FROM G/L	DOWN TILT	MHA'S (R IF REMOTE)	FEEDER TYPE	FEEDER LENGTH	No OF FEEDERS					
1	A1	TX/RX	NNNOX310RV1	0° E	GN	8m	-	1	LDF4-50	< 12.0m	2				
2	B1	TX/RX	NNNOX310RV1	120° I	EGN	8m	-	1	LDF4-50	< 12.0m	2				
3	C1	TX/RX	NNNOX310RV1	240° I	EGN	8m	-	1	LDF4-50	< 12.0m	2				
-	-	-	-	-		-	-	-	-	-	-				
-	-	-	-	-		-	-	-	-	-	-				
-	-	-	-	-		-	-	-	-	-	-				
EXISTING DISH SCHEDULE															
ITEM	DISH BEARING HEIGHT TO C/L REF BEARING OF DISH FROM G/L					SI	ZE		OTHER INFORMATION						
-	-	-		-			-		-						
-	-	-		-			-		-						
-	-	-		-			-	-							
-	-	-		-			-		-						
						DISH SCHED	ULE								
ITEM	DISH REF	BEARING	i OF	HT TO C/L DISH DM G/L		SI	ZE		OTHER INFORMATION						
-	-	-		-			-		-						
-	-	-		-			-			-					
-	-	-		-			-			-					
-	-	-		-			-			-					
			PRO	POSE	D EQL	JIPMENT SCH	HEDU	LE							
ITEM			YPE		No. OF	-	HxWxD			ER INFORMA					
1	NSN FLE	XI MODULES	WITHIN DORSET CABIN	ET	7	1500x14	450x650		COL	OUR - STAND	ARD				
2	HUAWEI		WITHIN DORSET CABIN	IET	1		450x650			OUR - STAND					
3		ELECTRICAL	METER PILLAR		1	O/A Height 950	x 390 x	220mm	COL	OUR - STAND	ARD				
-			-		-		-			-					
-			-		-		-			-					
		NOTE: INFO	ORMATION HELD ON	IMS TAK	ES PRECI	EDENCE OVER ALL	KEYS	AND SCHE	DULES SHO	WN					

EXISTING PLAN VIEW OF OPCS ANTENNA AT 8m AGL

