




Proposed Front Elevation
Scale 1:100

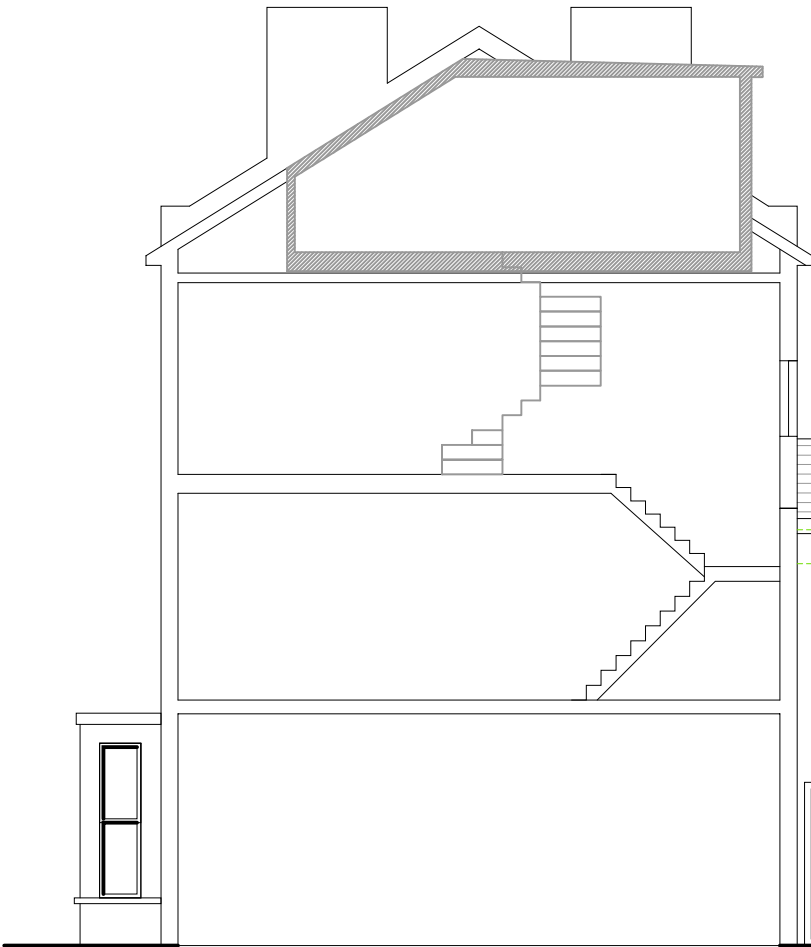


Proposed Side Elevation
Scale 1:100

Rear Dormer, Front Roof Lights and Conversion
into 2 Self Contained Flats Approved Previously
Under Planning Ref: 2012/3108/P.

Tile to Match
Existing

Brick to Match
Existing

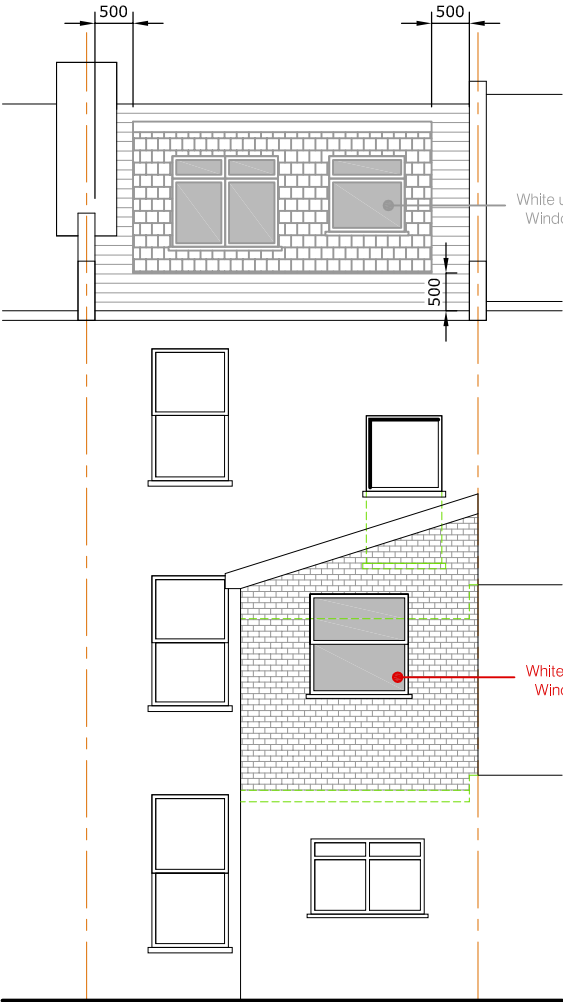

Proposed Rear Elevation
Scale 1:100



Meters 1:100

IMPORTANT GENERAL NOTE
The specification is to be read in conjunction with the plans/section details, and other associated Structural details as may be provided.
All work is to be carried out to the Local Authority Planning and Building Regulations Approval, and the Codes of Practice and British Standards as necessary.
All dimensions, levels, sizes, positions and locations of particulars as indicated on drawings are to be verified by the appointed Contractor on site prior to engaging in works. Any discrepancies must be reported to the Architect/Surveyor/Engineer or responsible person/s immediately.
The Contractor is responsible for ensuring compliance with the CDM Regulations, and appropriate Health & Safety on site precautions.
The Client/Building Owner must obtain any necessary PARTY WALL AGREEMENTS, prior to engaging in the works on site.

Revision	Date	Description	Scale
A	25.04.13	Previous Approvals Annotated	A3 @ 1:100
			Revision
			A
			Mar-13
			Drawn By
			AP

Client	K Patel
Proposed Elevations	
Site Address	64 Lloveridge Road London NW6 2DT

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Drawing Number LR64-2004A