

Title	Rev	Α	В		
	Rev Date	19/04/13	10/05/13		
	Description	19/04/13 New Scheme - Maj. New Build	0/05/13 Smaller B to GF Wall Offset		
	Арр	ild			

Construction

Flank Wall Sections

Martin Redston Associates Consulting Civil & Structural Engineers

6 Hale Lane, London NW7 3NX ☐ Tel: 020-8959 1666 Fax: 020-8906 8503 3 Edward Square, London N1 OSP ■ Tel: 020-7837 5377 Fax: 020-7837 3211


36 Heath Drive, London

ယ Sheet No.


Job No. 12-302

Scale 1:50 @A3

TEMPORARY WORKS PROPOSAL TO CONSTRUCT NEW R. C. BASEMENT INLULDING RETAINING WALL CLOSE TO EXISTING MASONRY PARTY WALL (SECTION Y-Y)

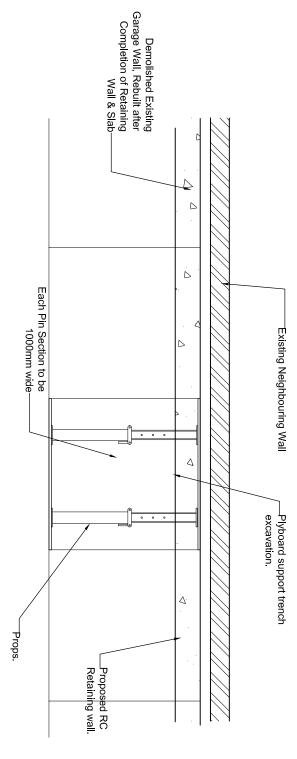

Plan of each Pin in section Y-Y.

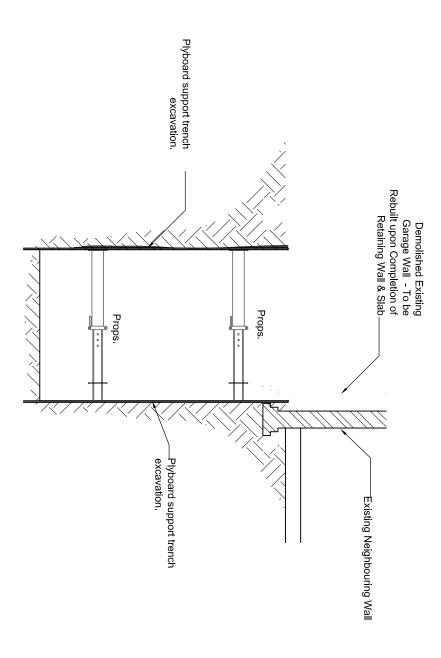

SEQUENCE OF CONSTRUCTION

- .EXCAVATE IN SEQUENCE TO CONSTRUCT NEW R.C RETAINING WALL.
- 2.STABILISED EXCAVATION PLYBOARDS AND PROPS HTIW
- 3.CAST SECTION OF RC BASE WITH 75mm KICKER AND WATER BAR.
- 4. CAST SECTION OF RC RET WALL TO UNDERSIDE OF PROPOSED NEW SUSPENDED SLAB [AINING
- 5. CONTINUE CONTINUE SEC EXCAVATE, PROPOSED AND WALL IS CONSTRUCTED. (CONSTRUCTION). RETAINING WALL UNTILL THE ENTIRE RETAINING UENCE

EXCAVATION FOR REINFORCED CONCRETE RETAINING WALLS

- 1. WORKING IN STRIPS NOT EXCEEDING 1M LONG EXCAVATE TO REQUIRED DEPTH ADJACENT EXISTING STRUCTURE.
- 2.CAST NEW CONCRETE BASE AND ALLOW 24 HOURS TO CURE. STARTER BARS TO EXTEND 404 ABOVE BASE FOR LAPPING PURPOSES (SEE DETAILS FOR BAR SIZES).
- 3.VERTICAL & HORIZONTAL REINFORCEMENT TO BE CONSTRUCTED IN ACCORDANCE WITH DESIGN INFORMATION AND ANY REINFORCEMENT SCHEDULES PROVIDED BY THE ENGINEER.
- LSHUTTERING & PROPPING TO BE DESIGNED BY CONTRACTOR.
- S.CAST NEW CONCRETE WALL ENSURING GROUND BEHIND NEW FOUNDATION & WALL IS FULLY BACKFILLED AND COMPACTED. CHECK AT REGULAR INTERVALS TO ENSURE THIS DURING CONSTRUCTION.
- 6.NEVER EXCAVATE TWO ADJACENT STRIPS WITHOUT ALLOWING 3 DAYS BETWEEN OPERATIONS.
- NAMEN ADJACENT SECTIONS ARE OPENED UP THE EXPOSED CONCRETE SURFACES SHOULD BE THOROUGHLY CLEANED OF ALL LOOSE MATERIAL & SCABBLED TO FORM A GOOD KEY.
- ALL REASONABLE CARE IS TO BE TAKEN TO PREVENT INJURIES TO PERSONS WORKING NEAR EXPOSED BARS ETC. (THREADED COUPLERS WOULD BE SUITABLE).
- .ALL NEW CONCRETE BELOW GROUND TO BE SULPHATE RESISTING CEMENT CONC. GRADE 35.
- 10. TRIAL PIT TO BE EXCAVATED TO CONFIRM EXISTANCE OF ANY EXISTING STRUCTURE. 1. REINFORCEMENT SHALL BE TO BS-\$110 WITH MAIN BARS TO BE GRADE 460 (HIGH YIELD).
- 2. READY MIX CONCRETE MUST BE OBTAINED FROM A PLANT THAT HOLDS A CURRENT CERTIFICATE OF ACCREDITATION UNDER THE QUALITY SCHEME FOR READY MIX CONCRETE.
- 13. NO CONCRETE IS TO BE PLACED WHEN THE AMBIENT AIR TEMPERATURE IS LESS THAN 5 DEGREES C.

Preliminary

	Title Temporary works/Undernin	Temi	Title
App	Description	Rev Date	Rev
	0/05/13 Smaller B to GF Wall Offset	10/05/13	Α
ı	1	_	-
	-	_	1

emporary works/ oriderpin

Consulting Civil & Structural Engineers Martin Redston Associates


6 Hale Lane, London NW7 3NX □ Tel: 020-8959 1666 Fax: 020-8906 8503 3 Edward Square, London N1 OSP ■ Tel: 020-7837 5377 Fax: 020-7837 3211


Date 07/09/2012 Job No. 12-302 Scale Sheet No.

Project

36 Heath Drive, London

Section Stage .1

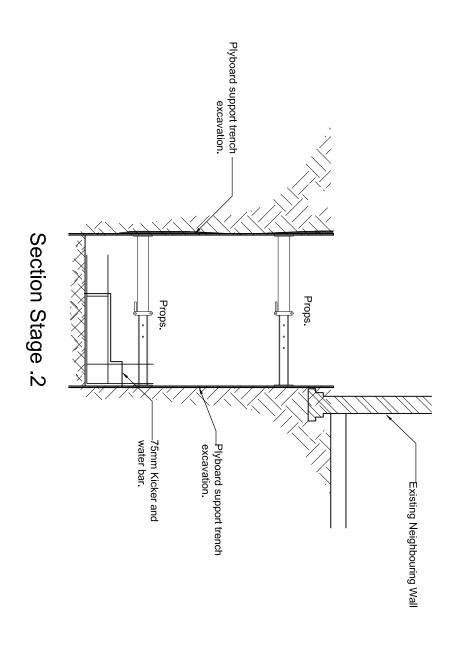

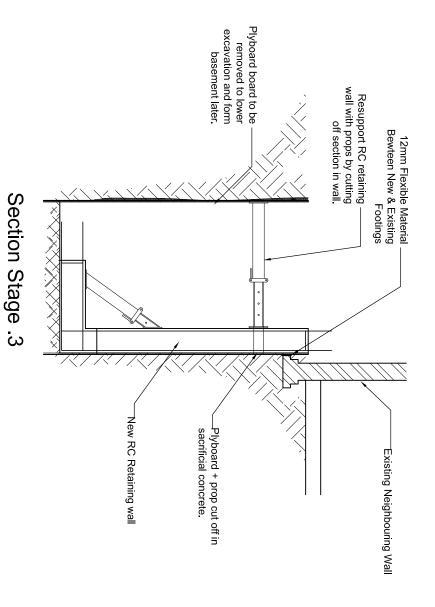

6. EXCAVATE BY LOWERING THE EARTH IN TWO STAGE.

COTINUED FROM DRAWING 1

7.INSTALL HORIZONTAL
SUPPORT (MABEY SUPER
PROP) TO TOP R.C.
RETAINING WALL

8.EXCAVATE THE REMAINING EARTH TO THE UNDERSIDE OF R.C. BASEMENT SLAB.

9. INSTALL HORIZONTAL SUPPORT (MABEY SUPER PROP) TO BOTTOM OF R.C. RETAINING WALL.

10. CAST SECTION OF R.C. BASEMENT SLAB.

Preliminary

Į.	Α	ı			
Rev Date	10/05/13	-			
Description	10/05/13 Smaller B to GF Wall Offset	1			٩
App		ı			

le Temporary works/ Underpin

Martin Redston Associates Consulting Civil & Structural Engineers

3 Edward Square, London N1 OSP Tel: 020-7837 5377 Fax: 020-7837 3211 6 Hale Lane, London NW7 3NX □ Tel: 020-8959 1666 Fax: 020-8906 8503


Tel: 020-8959 1666 Fax: 020-8906 8503

Date 07/09/2012 Sheet No. Rev

Eng. SG Scale TP2 A

Project 36 Heath Drive, London

Job No. 12-302

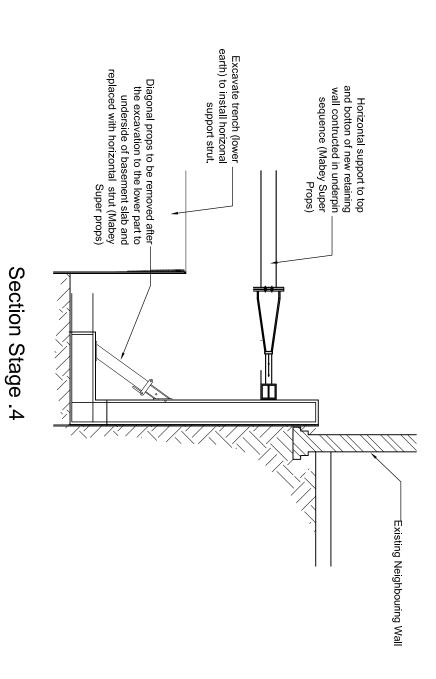


11.REMOVE BOTTOM HORIZONTAL STRUT (MABEY SUPER PROP).

COTINUED FROM DRAWING 1

12.CAST R.C SUSPENDED
BASEMENT SLAB TO
COMPLETE BASEMENT BOX.

13. REMOVE TOP HORIZONTAL STRUT.

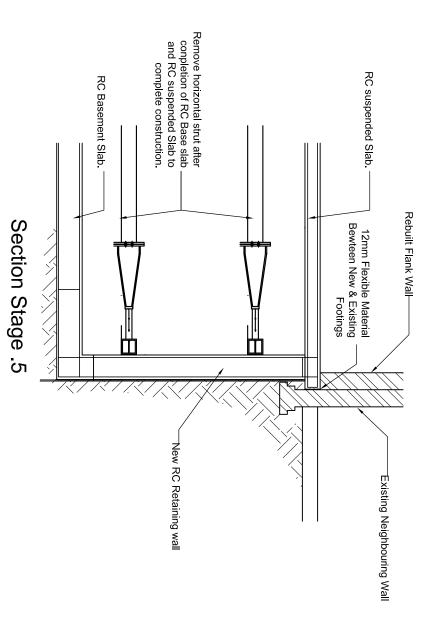

Preliminary

- - - - - - - - - - A 10/05/13 Smaller B to GF Wall Offset Rev Date Description App

Title Temporary works/ Underpin


Martin Redston Associates
Consulting Civil & Structural Engineers


3 Edward Square, London N1 OSP
Tel: 020-7837 5377 Fax: 020-7837 3211
6 Hale Lane, London NW7 3NX
Tel: 020-8959 1666 Fax: 020-8906 8503

Date 07 / 09 / 2012 Sheet No. Rev Eng. SG Scale TP3 A


Job No. 12-302 TP3 A

Project 36 Heath Drive, London

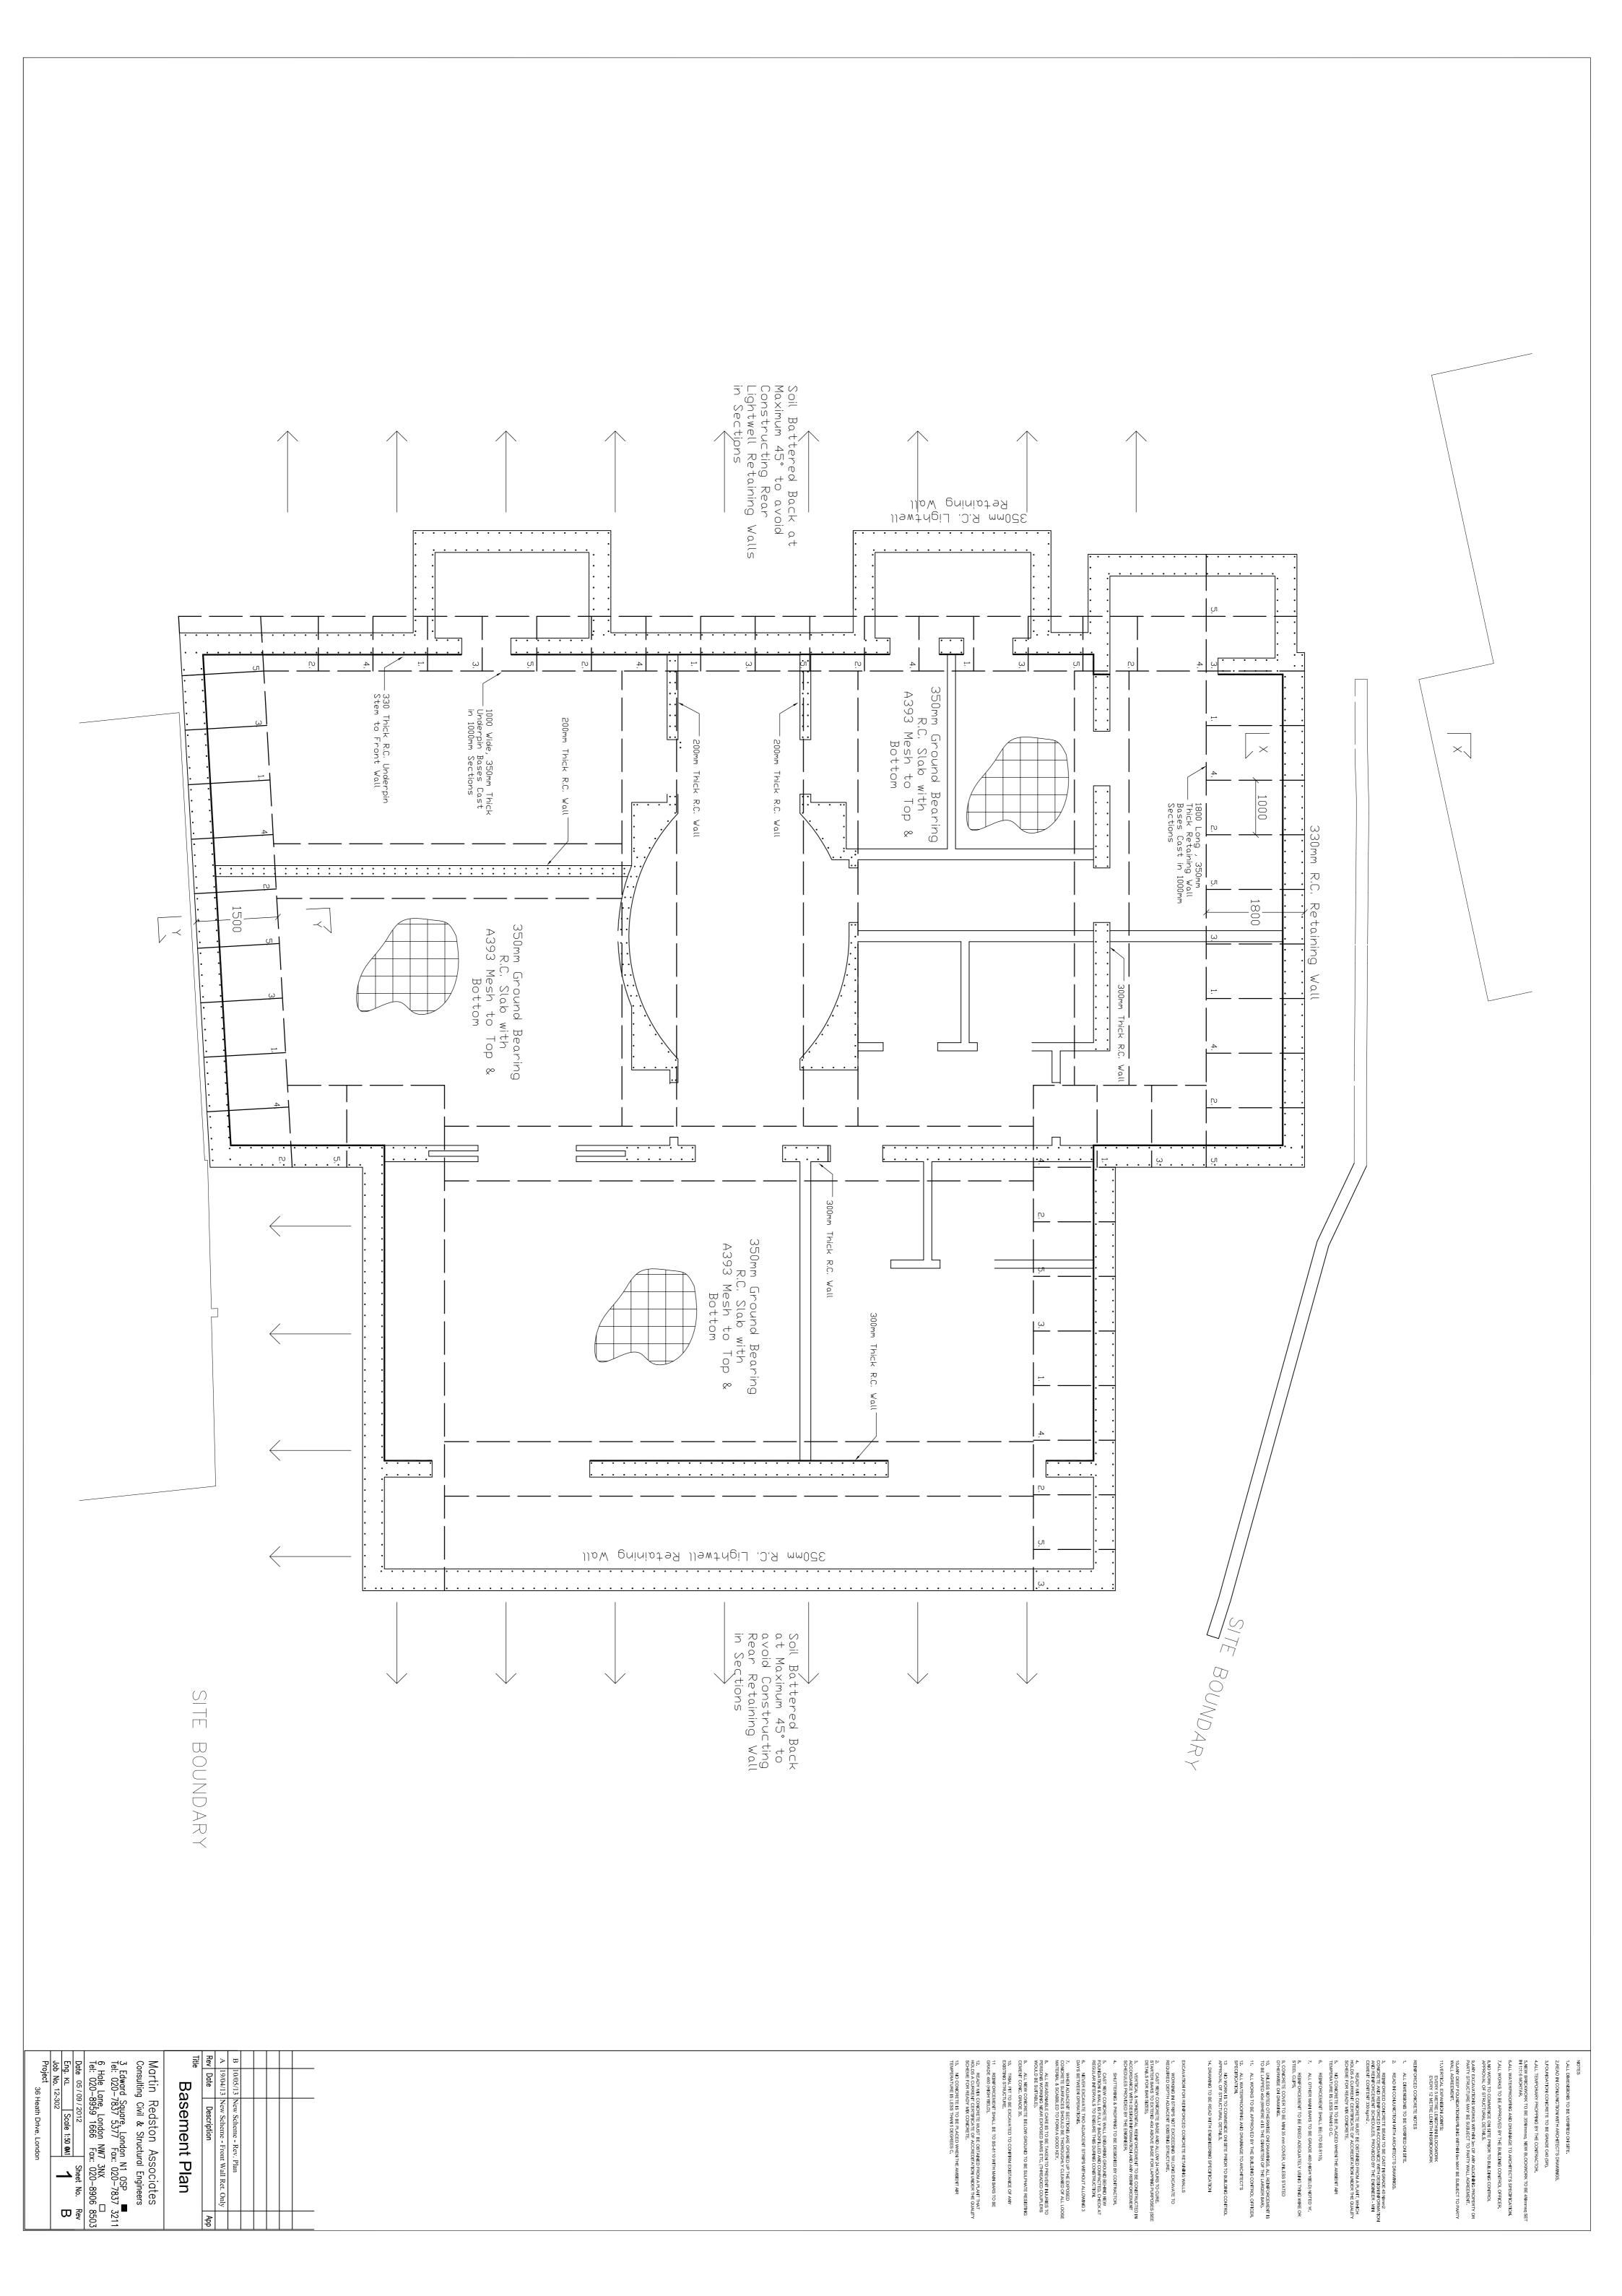


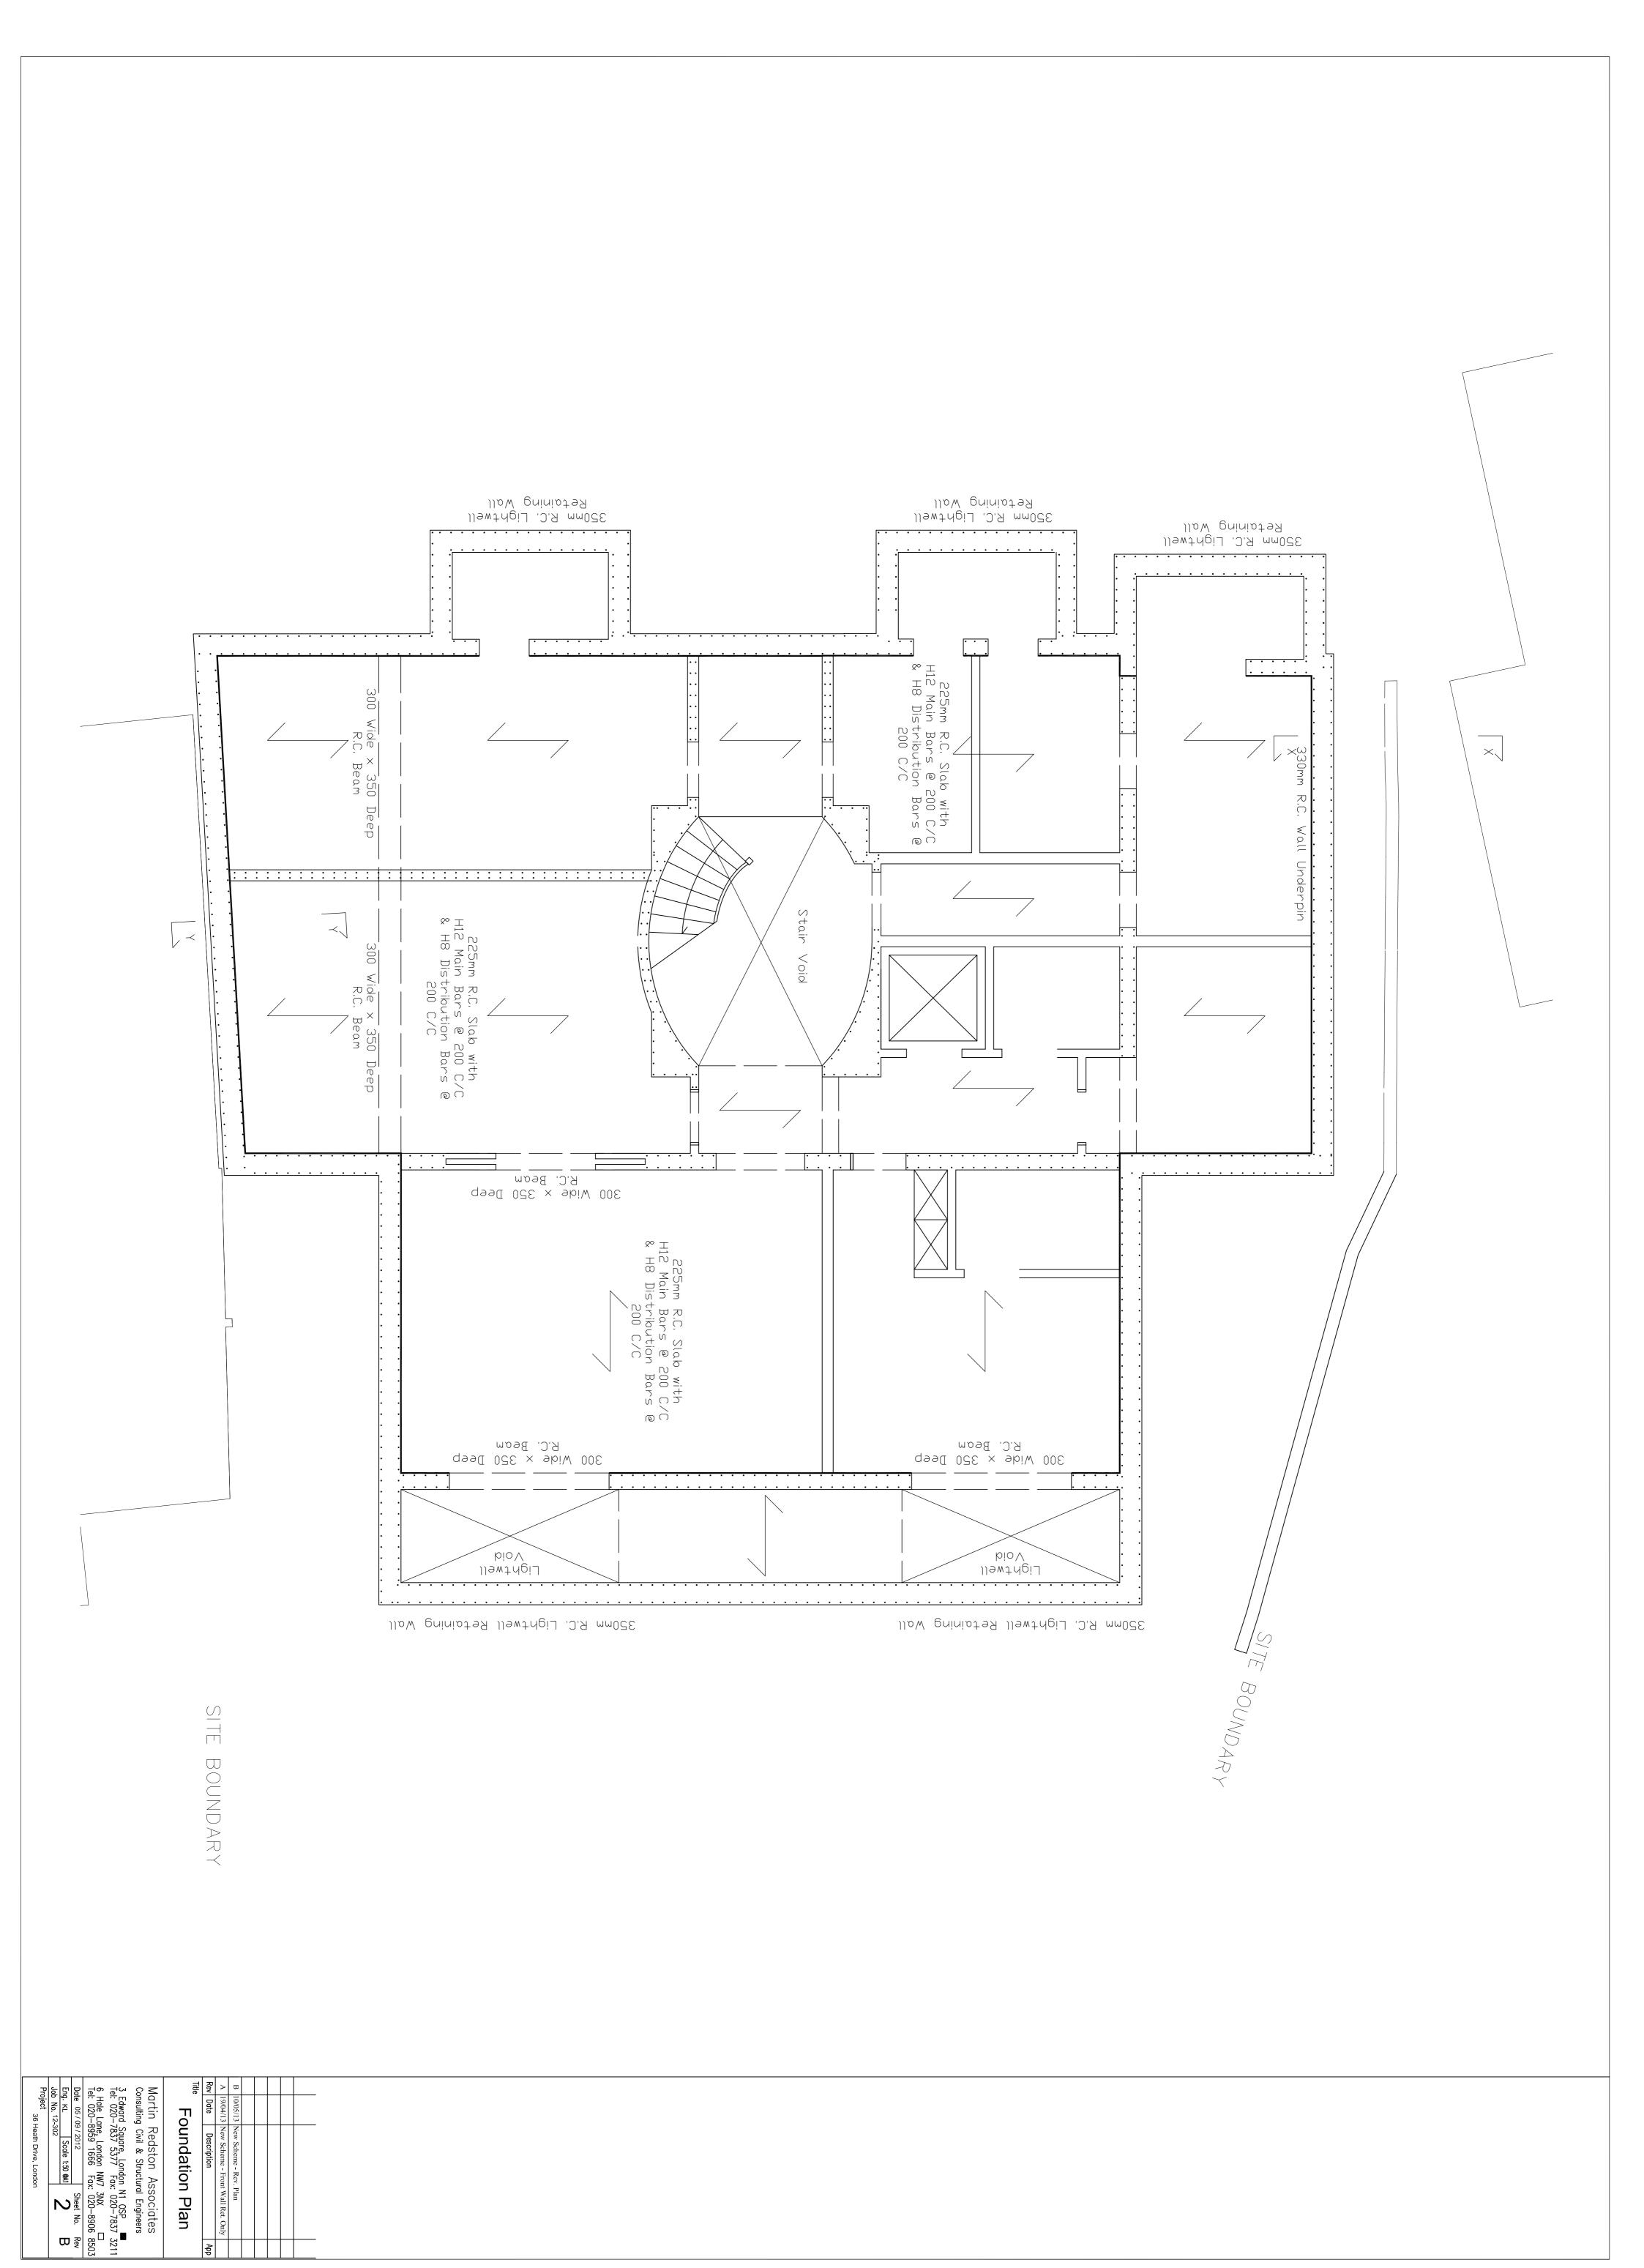

TEMPORARY WORKS PROPOSAL TO CONSTRUCT NEW R. C. BASEMENT INLULDING RETAINING WALL CLOSE TO EXISTING MASONRY PARTY WALL (SECTION X-X)

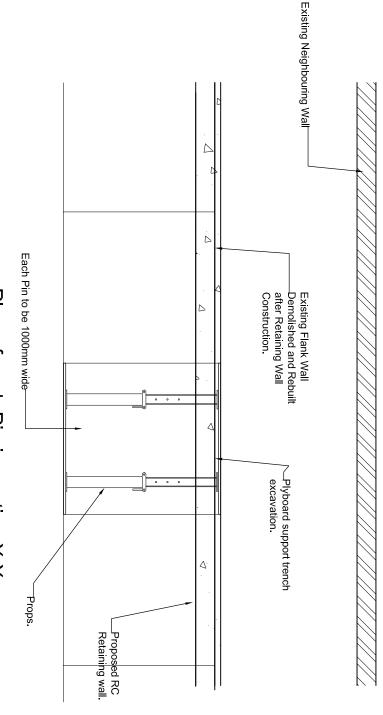

Plan of each Pin in section X-X.

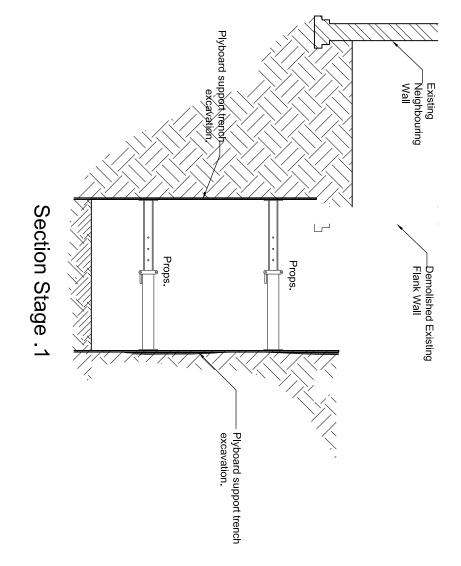

SEQUENCE OF CONSTRUCTION

- 1.EXCAVATE IN SEQUENCE TO CONSTRUCT NEW R.C RETAINING WALL.
- 2.STABILISED EXCAVATION PLYBOARDS AND PROPS HTIW N
- 3.REMOVE ANY LOOSE EXISTING CONCRETE NEAR UNDERSIDE OF BRICK CORBEL IF ANY.
- 4.CAST SECTION OF RC BASE SLAB WITH 75mm KICKER AND WATER WITH 75mm KICKER AND
- 5. CAST SECTION OF RC RETAINING RECEIVE SLAB. WALL TO TOP, READY TO

EXCAVATION FOR REINFORCED CONCRETE RETAINING WALLS

- . WORKING IN STRIPS NOT EXCEEDING 1M LONG EXCAVATE TO REQUIRED DEPTH ADJACENT EXISTING STRUCTURE.
- CAST NEW CONCRETE BASE AND ALLOW 24 HOURS TO CURE. STARTER BARS TO EXTEND 40d ABOVE BASE FOR LAPPING PURPOSES (SEE DETAILS FOR BAR SIZES).
- VERTICAL & HORIZONTAL REINFORCEMENT TO BE CONSTRUCTED IN ACCORDANCE WITH DESIGN INFORMATION AND ANY REINFORCEMENT SCHEDULES PROVIDED BY THE ENGINEER.
- SHUTTERING & PROPPING TO BE DESIGNED BY CONTRACTOR.
- S.CAST NEW CONCRETE WALL ENSURING GROUND BEHIND NEW FOUNDATION & WALL IS FULLY BACKFILLED AND COMPACTED. CHECK, AT REGULAR INTERVALS TO ENSURE THIS DURING CONSTRUCTION.
- . NEVER EXCAVATE TWO ADJACENT STRIPS WITHOUT ALLOWING 3 DAYS BETWEEN OPERATIONS.
- WHEN ADJACENT SECTIONS ARE OPENED UP THE EXPOSED CONCRETE SURFACES SHOULD BE THOROUGHLY CLEANED OF ALL LOOSE MATERIAL & SCABBLED TO FORM A GOOD KEY.
- ALL REASONABLE CARE IS TO BE TAKEN TO PREVENT INJURIES TO PERSONS WORKING NEAR EXPOSED BARS ETC. (THREADED COUPLERS WOULD BE SUITABLE).
- 0. TRIAL PIT TO BE EXCAVATED TO CONFIRM EXISTANCE OF ANY EXISTING STRUCTURE. ALL NEW CONCRETE BELOW GROUND TO BE SULPHATE RESISTING CEMENT CONC. GRADE 35.
- I. REINFORCEMENT SHALL BE TO BS-8110 WITH MAIN BARS TO BE GRADE 460 (HIGH YIELD).
- . READY MIX CONCRETE MUST BE OBTAINED FROM A PLANT THAT HOLDS A CURRENT CERTIFICATE OF ACCREDITATION UNDER THE QUALITY SCHEME FOR READY MIX CONCRETE.

Preliminary

| Title | Rev | A | 1 | | | |
|---------------------------|-------------|----------------------------|---|--|--|---|
| | Rev Date | 10/05/13 | _ | | | |
| Temporary works/ Hadernia | Description | 0/05/13 Flank Wall Rebuilt | _ | | | |
| | Арр | | Ι | | | |
| | | | | | | _ |


Temporary works/ Underpin


Martin Redston Associates Consulting Civil & Structural Engineers

6 Hale Lane, London NW7 3NX □ Tel: 020-8959 1666 Fax: 020-8906 8503 3 Edward Square, London N1 OSP ■ 1el: 020-7837 5377 Fax: 020-7837 3211

Job No. 12-302 Date 07/09/2012 TP101

Project 36 Heath Drive, London

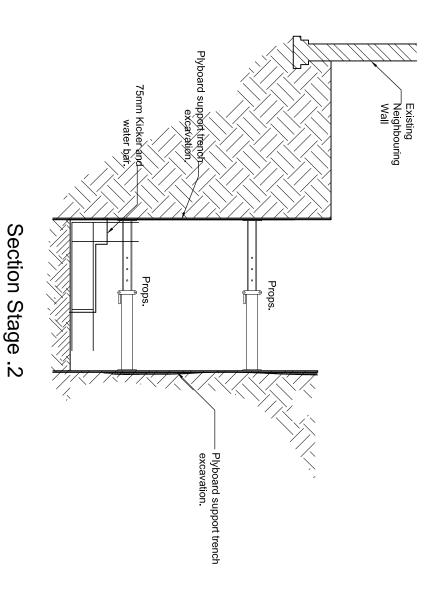

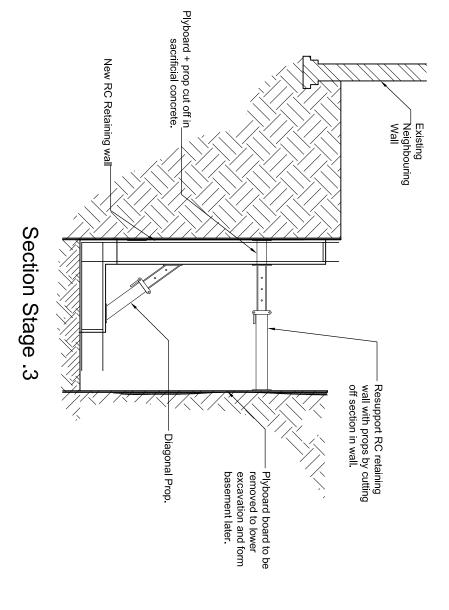

6.ADEQUATE REBAR INLUDING LAP (IF REQUIRED) TO RECEIVE SLAB.

COTINUED FROM DRAWING 101

7. CONTINUE SEQUENCE UNTILL THE ENTIRE RETAINING WALL IS CONSTRUCTED. (EXCAVATE, PROPOSED AND RETAINING WALL CONSTRUCTION).

8. EXCAVATE BY LOWERING THE CENTRAL AREA SOIL (FIRST OF TWO STAGES).

9.INSTALL HORIZONTAL SUPPORT (MABEY SUPER PROP) TO TOP R.C. RETAINING WALL

10.EXCAVATE THE REMAINING SOIL TO THE UNDERSIDE OF R.C. BASEMENT SLAB.

11. INSTALL HORIZONTAL
SUPPORT (MABEY SUPER PROP)
TO BOTTOM OF R.C. RETAINING
WALL.

Preliminary

| | Rev | Α | ı | ı | | |
|-----|-------------|-----------------------------|---|---|--|--|
| ł | Rev Date | 0/05/13 | _ | _ | | |
| . , | Description | .0/05/13 Flank Wall Rebuilt | - | _ | | |
| | Арр | | | | | |
| | | | | | | |


Title Temporary works/ Underpin

Martin Redston Associates Consulting Civil & Structural Engineers


3 Edward Square, London N1 OSP Tel: 020-7837 5377 Fax: 020-7837 3211
6 Hale Lane, London NW7 3NX □
1el: 020-8959 1666 Fax: 020-8906 8503

| Date | 07 / 09 / 2012 | Sheet No. | Rev | Eng. | SG | Scale | TP102 | A | Job No. | 12-302

36 Heath Drive, London

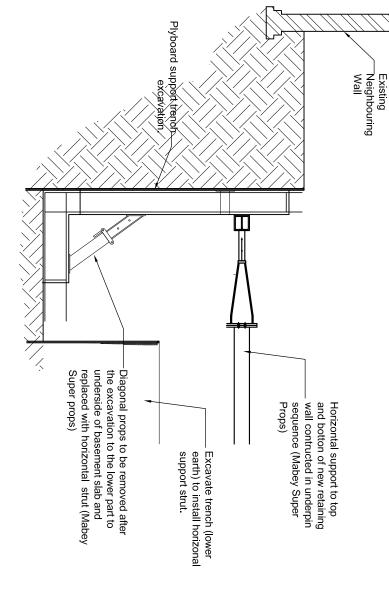

Section Stage .4

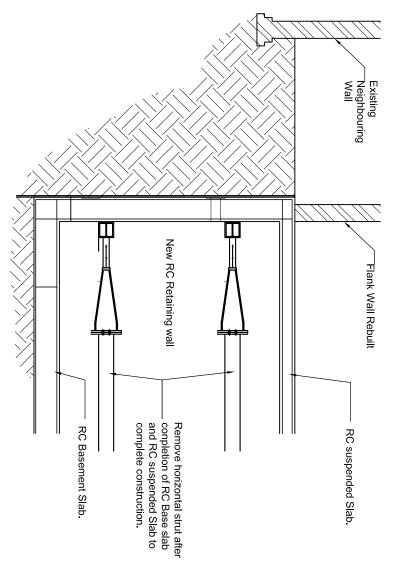

Section Stage .5

12.CAST REINFORCED CONCRETE BASEMENT SLAB

COTINUED FROM DRAWING 101

13.REMOVE BOTTOM HORIZONTAL STRUT (MABEY SUPER PROP).

14.CAST R.C SUSPENDED BASEMENT SLAB TO COMPLETE BASEMENT BOX.

15. REMOVE TOP HORIZONTAL STRUT.

16.CONSTRUCT NEW FLANK WALL AT GROUND LEVEL WALL. ON TOP OF RETAINING

Preliminary

| | | i elli illi eli y | |
|-----|----------|-----------------------------|-----|
| | | | |
| | | | |
| | | | |
| | | | |
| | | | |
| Α | 0/05/13 | 10/05/13 Flank Wall Rebuilt | |
| Rev | Rev Date | Description | App |
| 1 | | | |

Title Temporary works/ Underpin

Martin Redston Associates Consulting Civil & Structural Engineers

3 Edward Square, London N1 OSP Tel: 020-7837 5377 Fax: 020-7837 3211 6 Hale Lane, London NW7 3NX □ 161: 020-8959 1666 Fax: 020-8906 8503

Date 07/09/2012 Scale TP103 Sheet No. Rev \triangleright

Project 36 Heath Drive, London