


NOTE

ALL WORK TO BE IN ACCORDANCE WITH CURRENT BUILDING REGULATIONS, HEALTH & SAFETY, BRITISH STANDARDS, I.E.E. WIRING REGULATIONS AND CDM REGULATIONS.

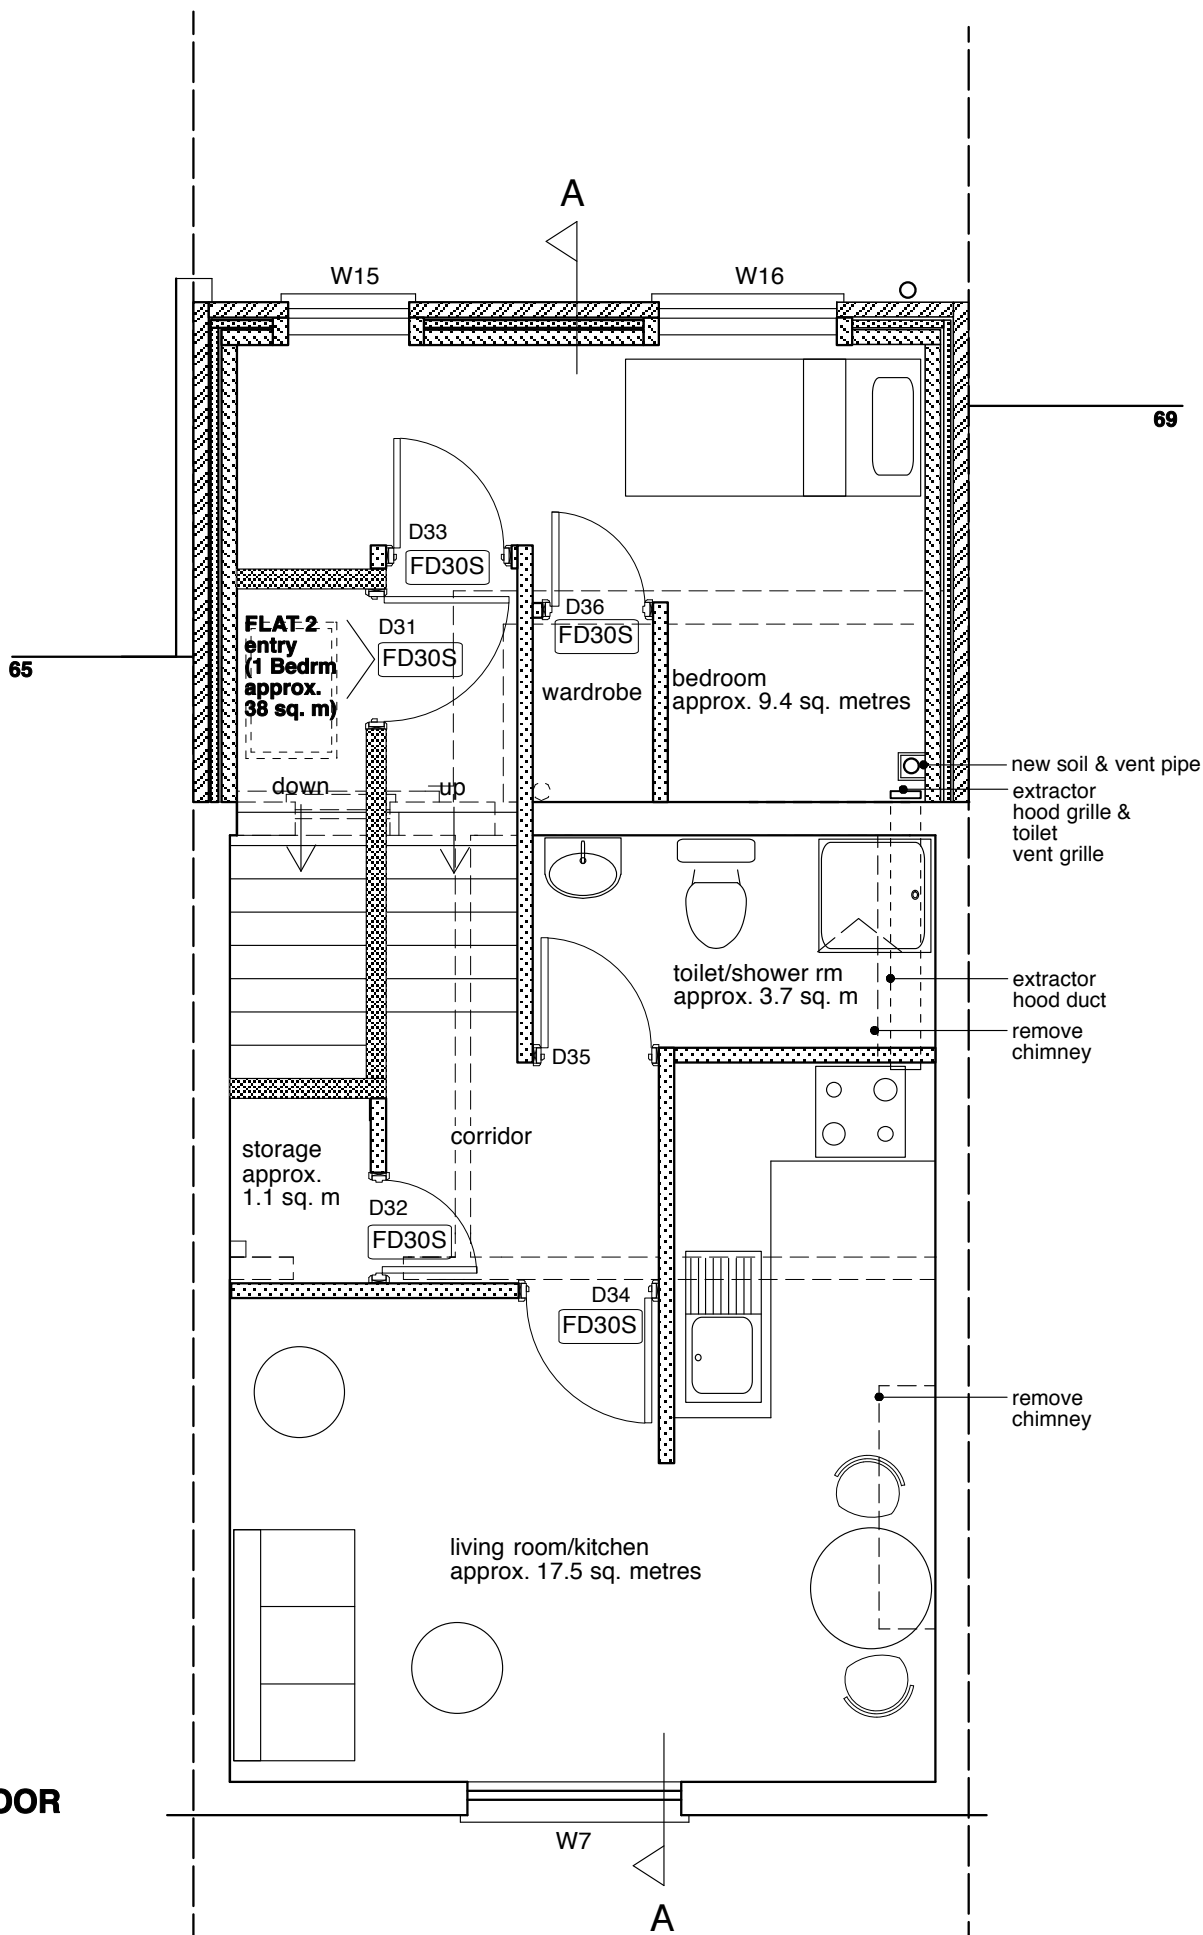



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
W7 window number


D31 door number

FD30S half hour fire/smoke resistant standard

 New cavity wall with brickwork exterior to match existing, insulation in cavity, blockwork interior with 12.7mm British Gypsum plasterboard dry lining finish. Cavity reveals to Building Regulations 14, C2, L1A.

 One layer of 15mm BG Gyproc Fireline board to each side. Boards to be taper edged, tape and jointed - all to achieve half hour fire resistance.

 Two layers of 12.5mm BG Gyproc Soundbloc each side with 50mm Isowool 1200 cavity insulation. Boards to be taper edged, tape and jointed all installed to manufacturers recommendations.

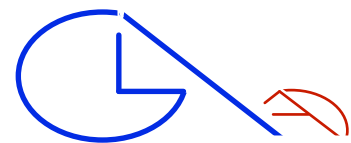

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Client ALL SAINTS GREEK ORTHODOX CATHEDRAL		
Main Contractor		
Project TWO & A HALF STOREY REAR EXTENSION & BASMENT ALTERATIONS TO CREATE 3 NO. FLATS - 67 BAYHAM STREET, LONDON NW1 0AA		
Drawing Title PROPOSED SECOND FLOOR PLAN		
Scale 1:50@A3	Date May 2013	Drawn By GA
Project No. 0726	Drawing No. 26	Rev. A-
DO NOT SCALE THIS DRAWING. ALL DIMENSIONS TO BE CHECKED ON SITE © Copyright		
DRAWING STATUS		
A SCHEME - Outline/Scheme drawings for proposals, budgets, etc.		
B DESIGN DEVELOPMENT - Evolving final design drawings for approvals, tenders, billing etc.		
C CONSTRUCTION - Fully developed drawings issued under instruction for construction.		
ONLY STATUS C DRAWINGS TO BE USED FOR CONSTRUCTION PURPOSES		

SECOND FLOOR