




1 SIDE ELEVATION
SCALE: 1:20@A3

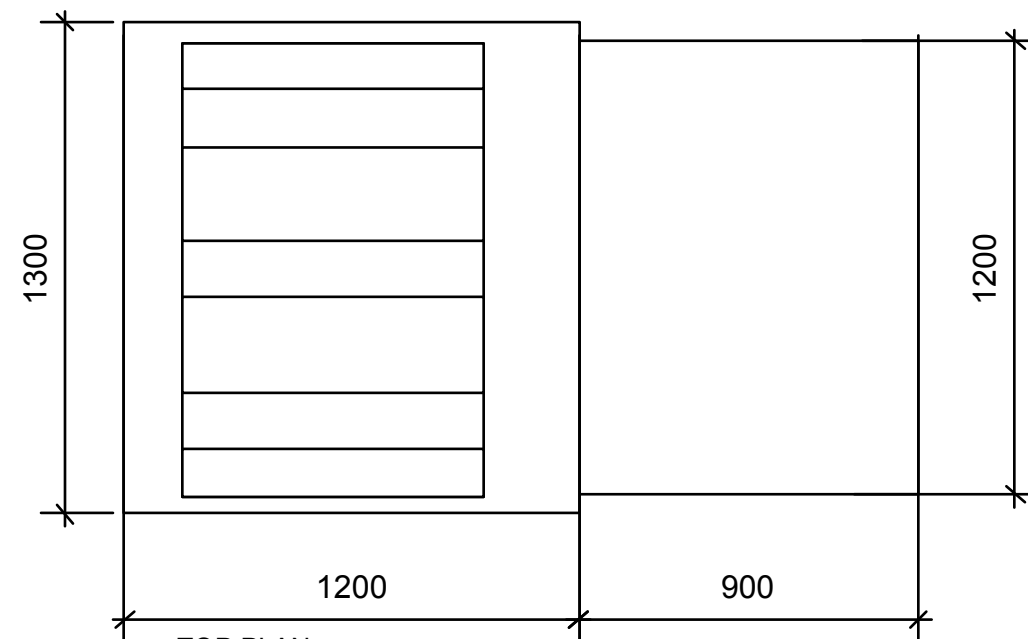

2 TOP PLAN
SCALE: 1:10@A3

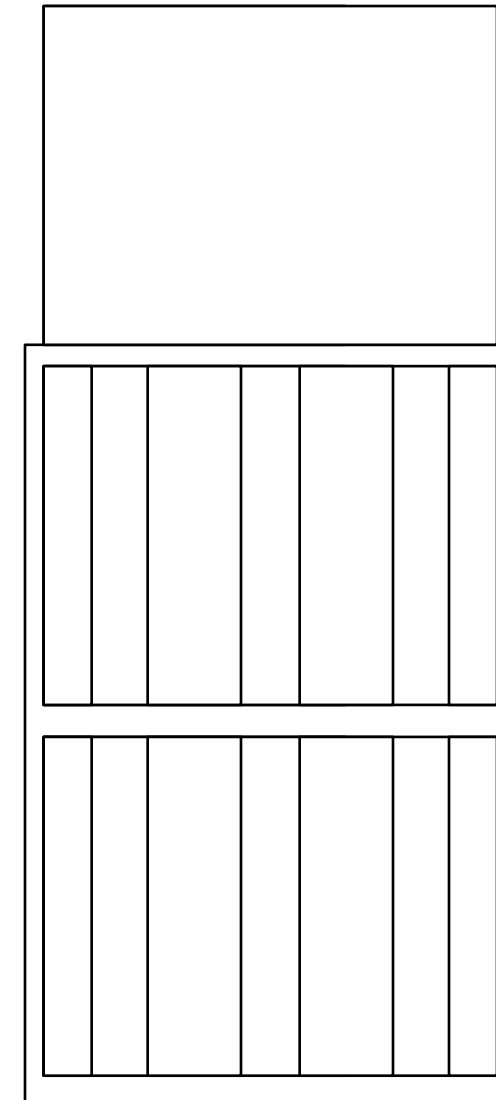

3 FRONT ELEVATION
SCALE: 1:20@A3

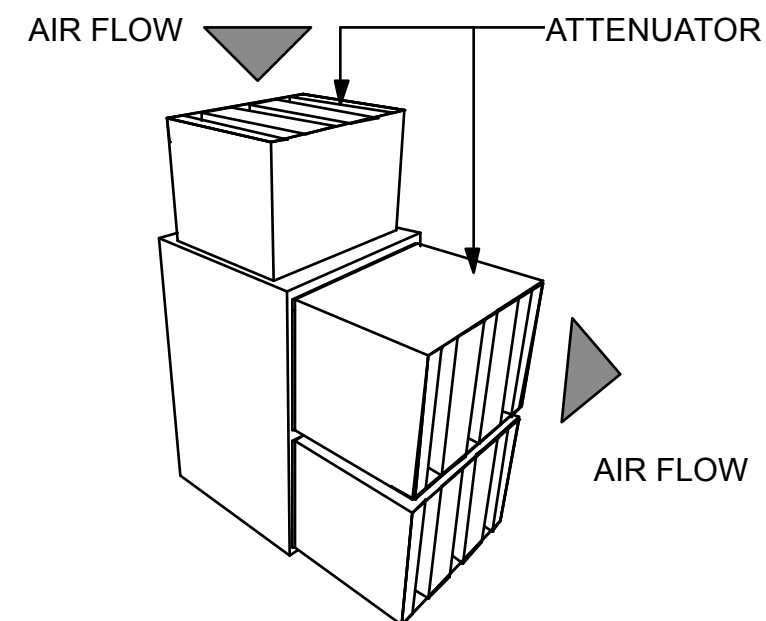

4 VISUAL
SCALE: 1:20@A3

A-3.6

NOTE:
ALL DIMENSIONS TO BE
CHECKED ON SITE PRIOR TO
ANY WORK COMMENCING
DRAWINGS TO BE READ IN
CONJUNCTION WITH ALL
REFERENCED DRAWINGS,
MATERIALS AND FINISHES
SCHEDULES

ACOUSTIC ENCLOSURE
SPECIFICATION.
FORMED OF AND ALUMINIUM
FRAMEWORK WITH 45MM THICK
PANELS WITH QUICK RELEASE
HATCHES FOR ACCESS PANEL AND
45MM THICK PANELS WITH TEK
SCREWS QUICK WHERE NO
ACCESS IS REQUIRED.

ATTENUATORS
CASED ATTENUATOR
MANUFACTURED FROM PRE
GALVANISED STEEL SHEET.

DRAWING ISSUE FOR PLANNING

Portland Design Associates Ltd First Floor 63 Gee Street London EC1V 3RS T +44(0)20 7017 8780 F +44(0)20 7017 8781			
Revision	Date	Amendment	Signature
Client: JCREW			
Project: 38 LAMBS CONDUIT STREET, LONDON, WC1N 3LD			
Drawing Title: ACOUSTIC ENCLOSURE			
Date	Scale	Signature	
2009.13	1:20 @ A3	CJ	
Doc Number	Drawing Number		
04037	A-3.3		
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All dimensions and site levels on this drawing to be checked on site and any discrepancies reported to the designer prior to commencement of the work.			
No dimensions to be scaled from this drawing, if in doubt ask.			

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