




REFLECTED CEILING PLAN

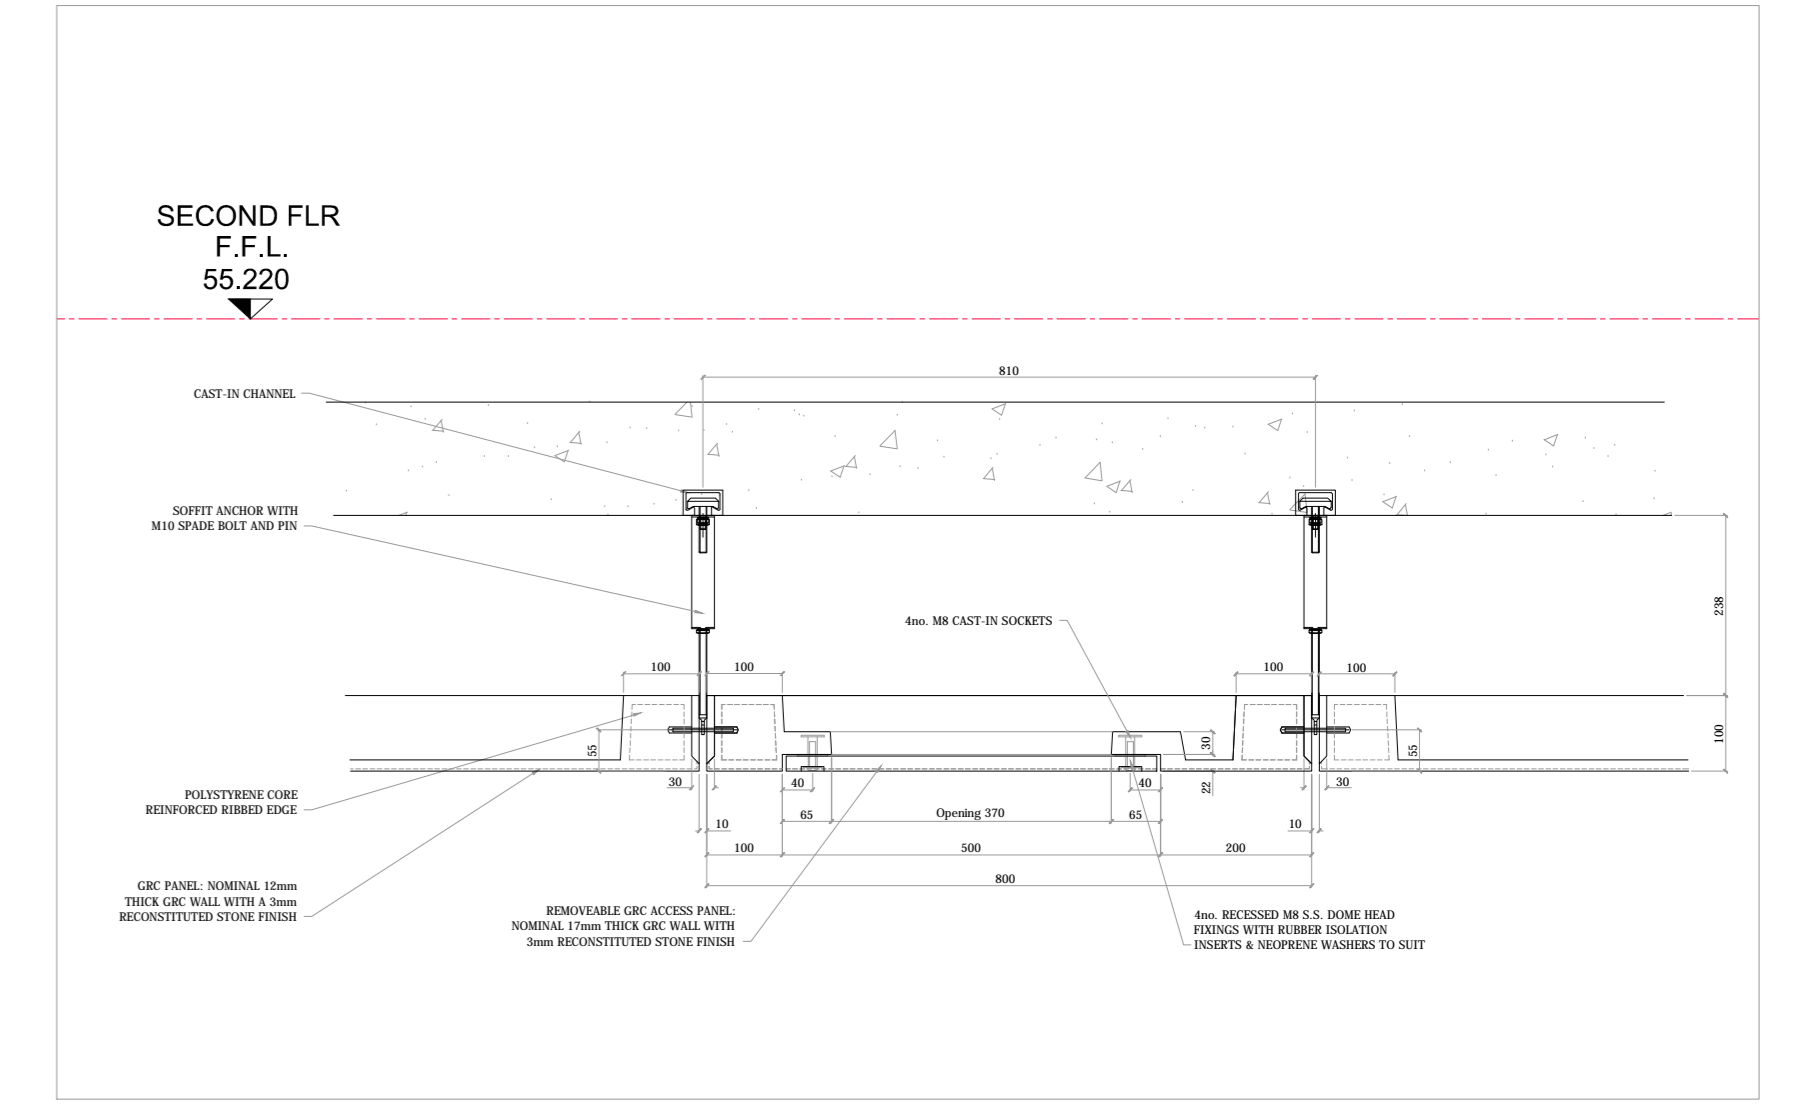


ACCESS PANEL DETAIL

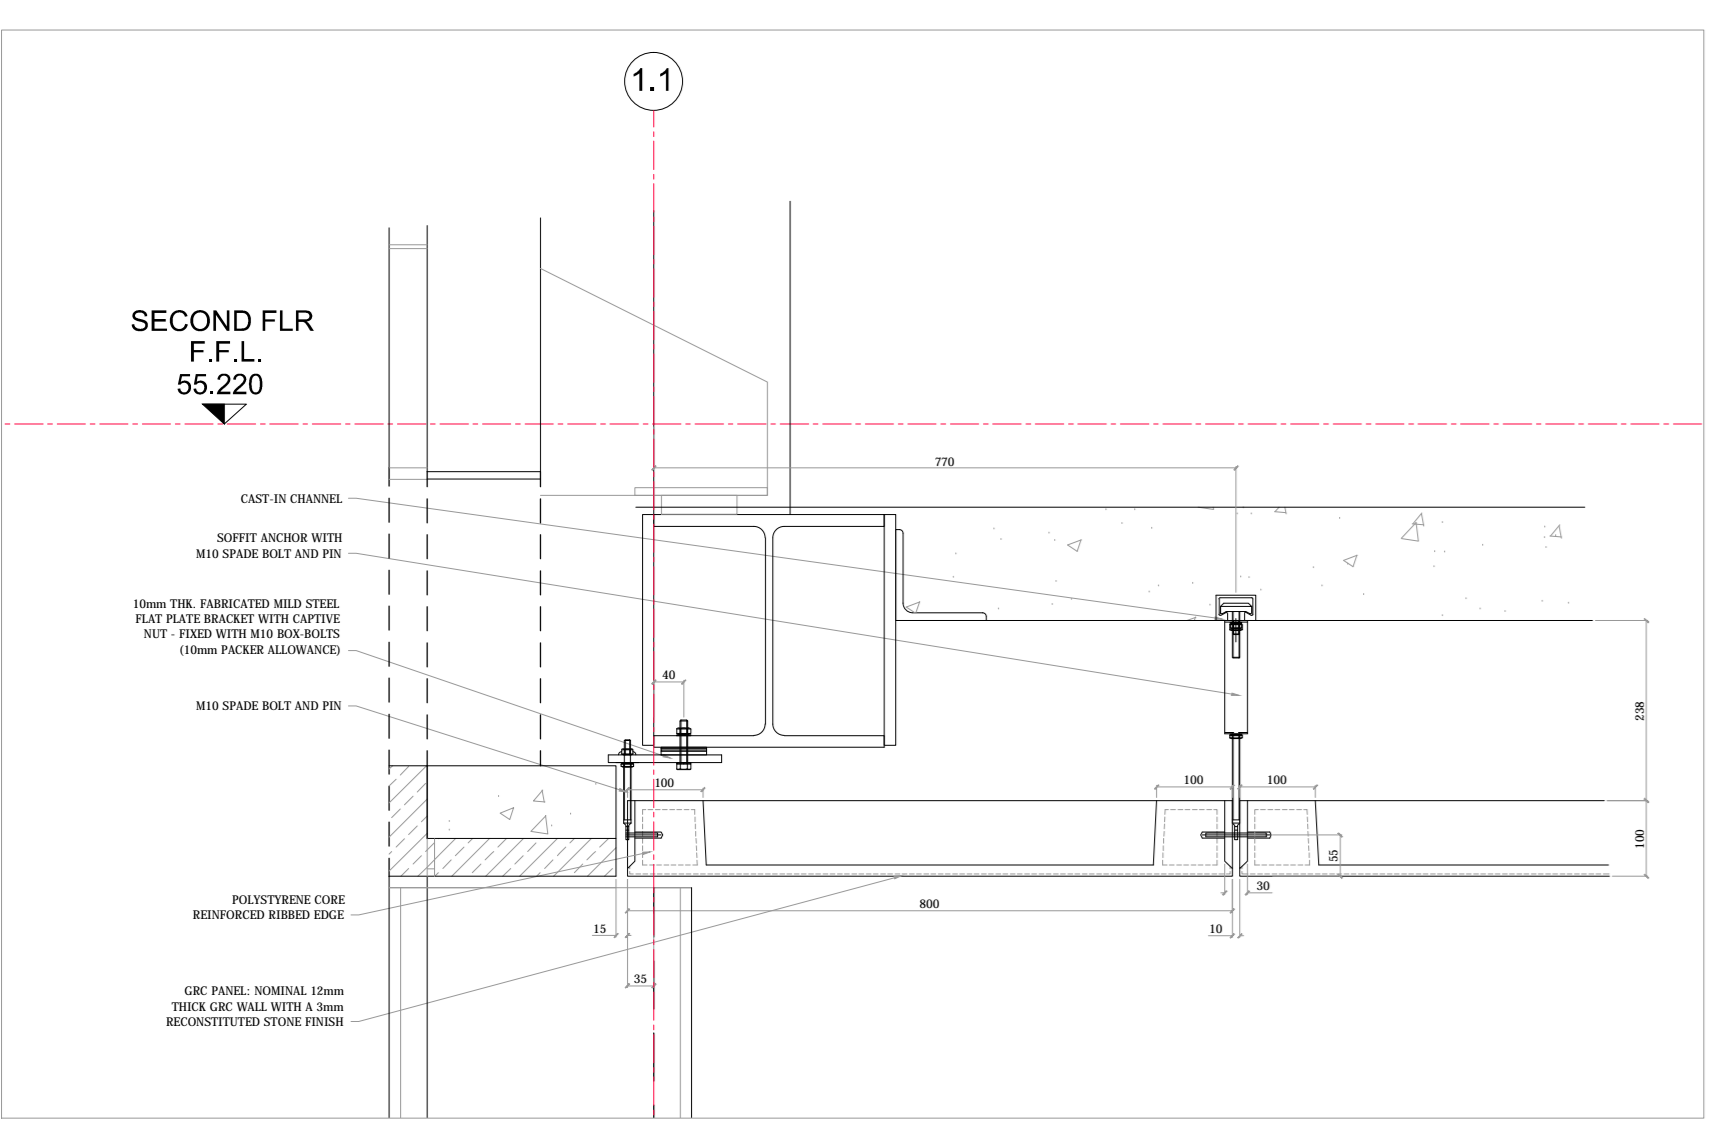


TYPICAL SECTION (ALONG GRIDLINE - 1.1)

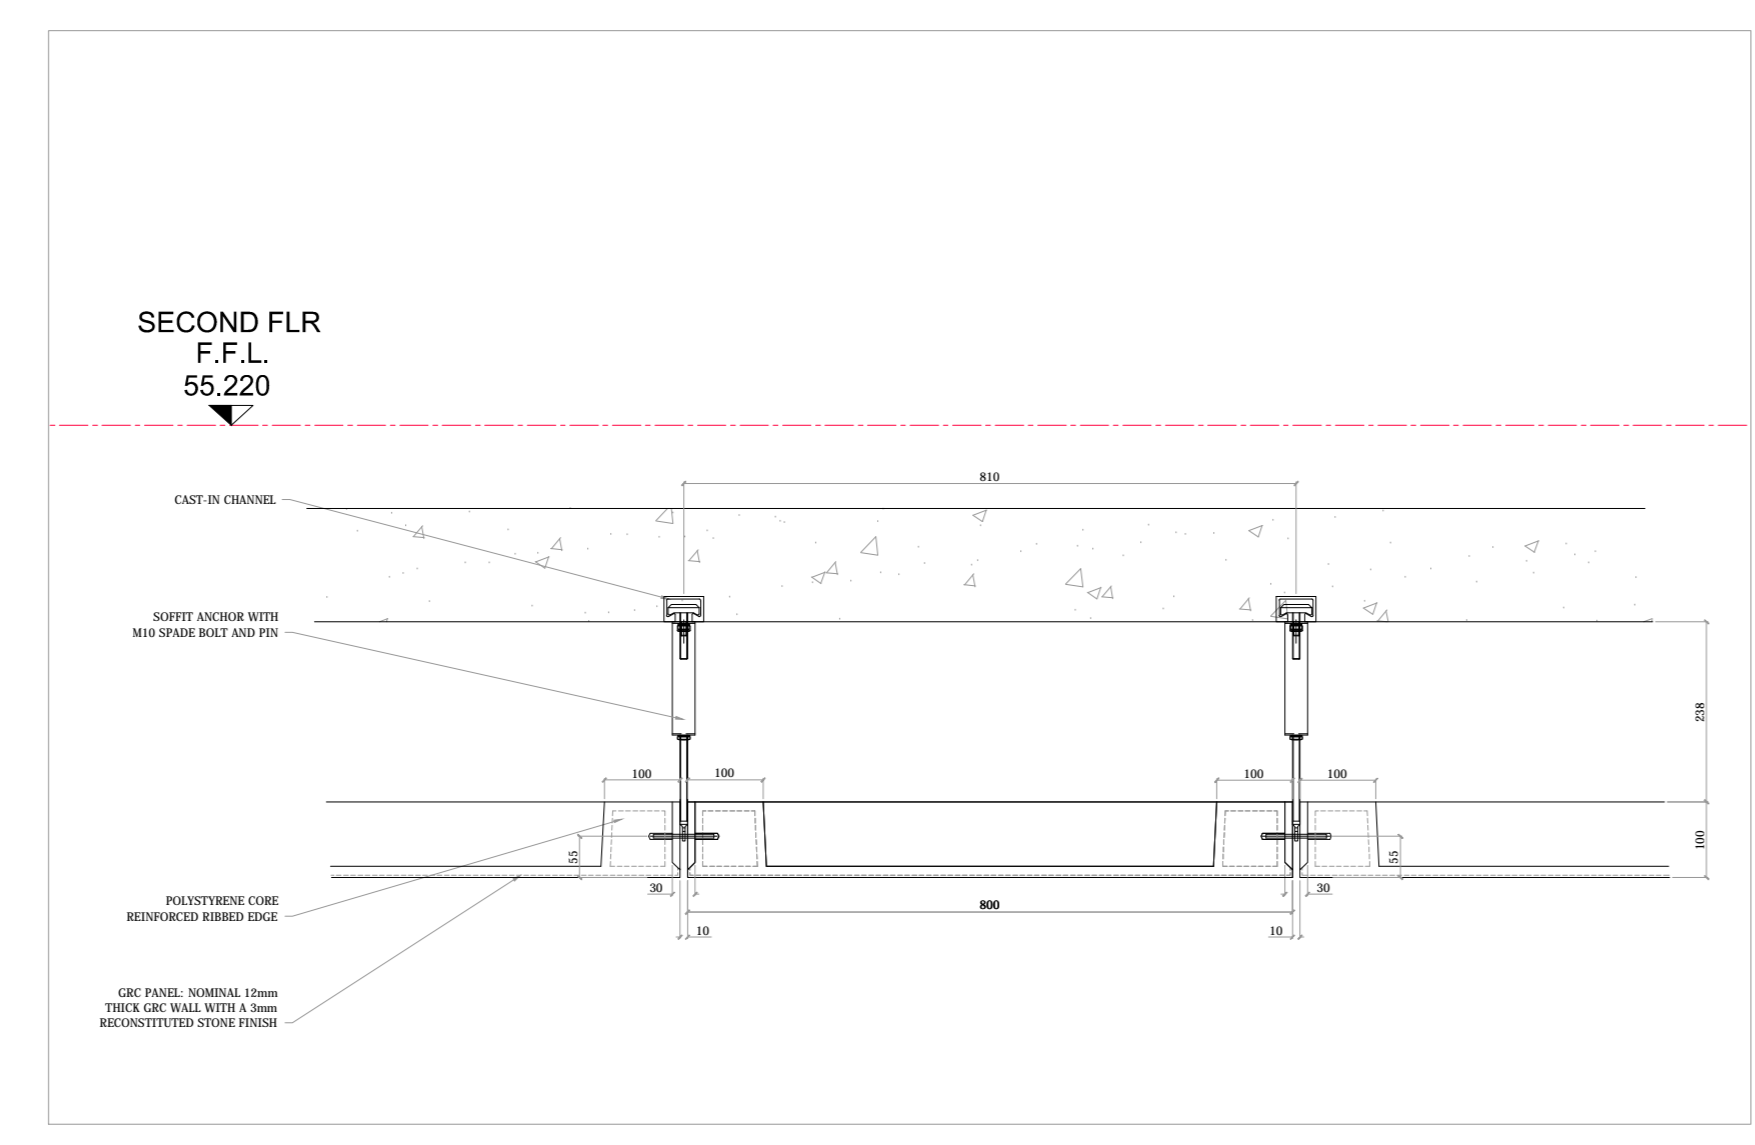

TYPICAL SECTION (ACROSS PANEL JOINTS)

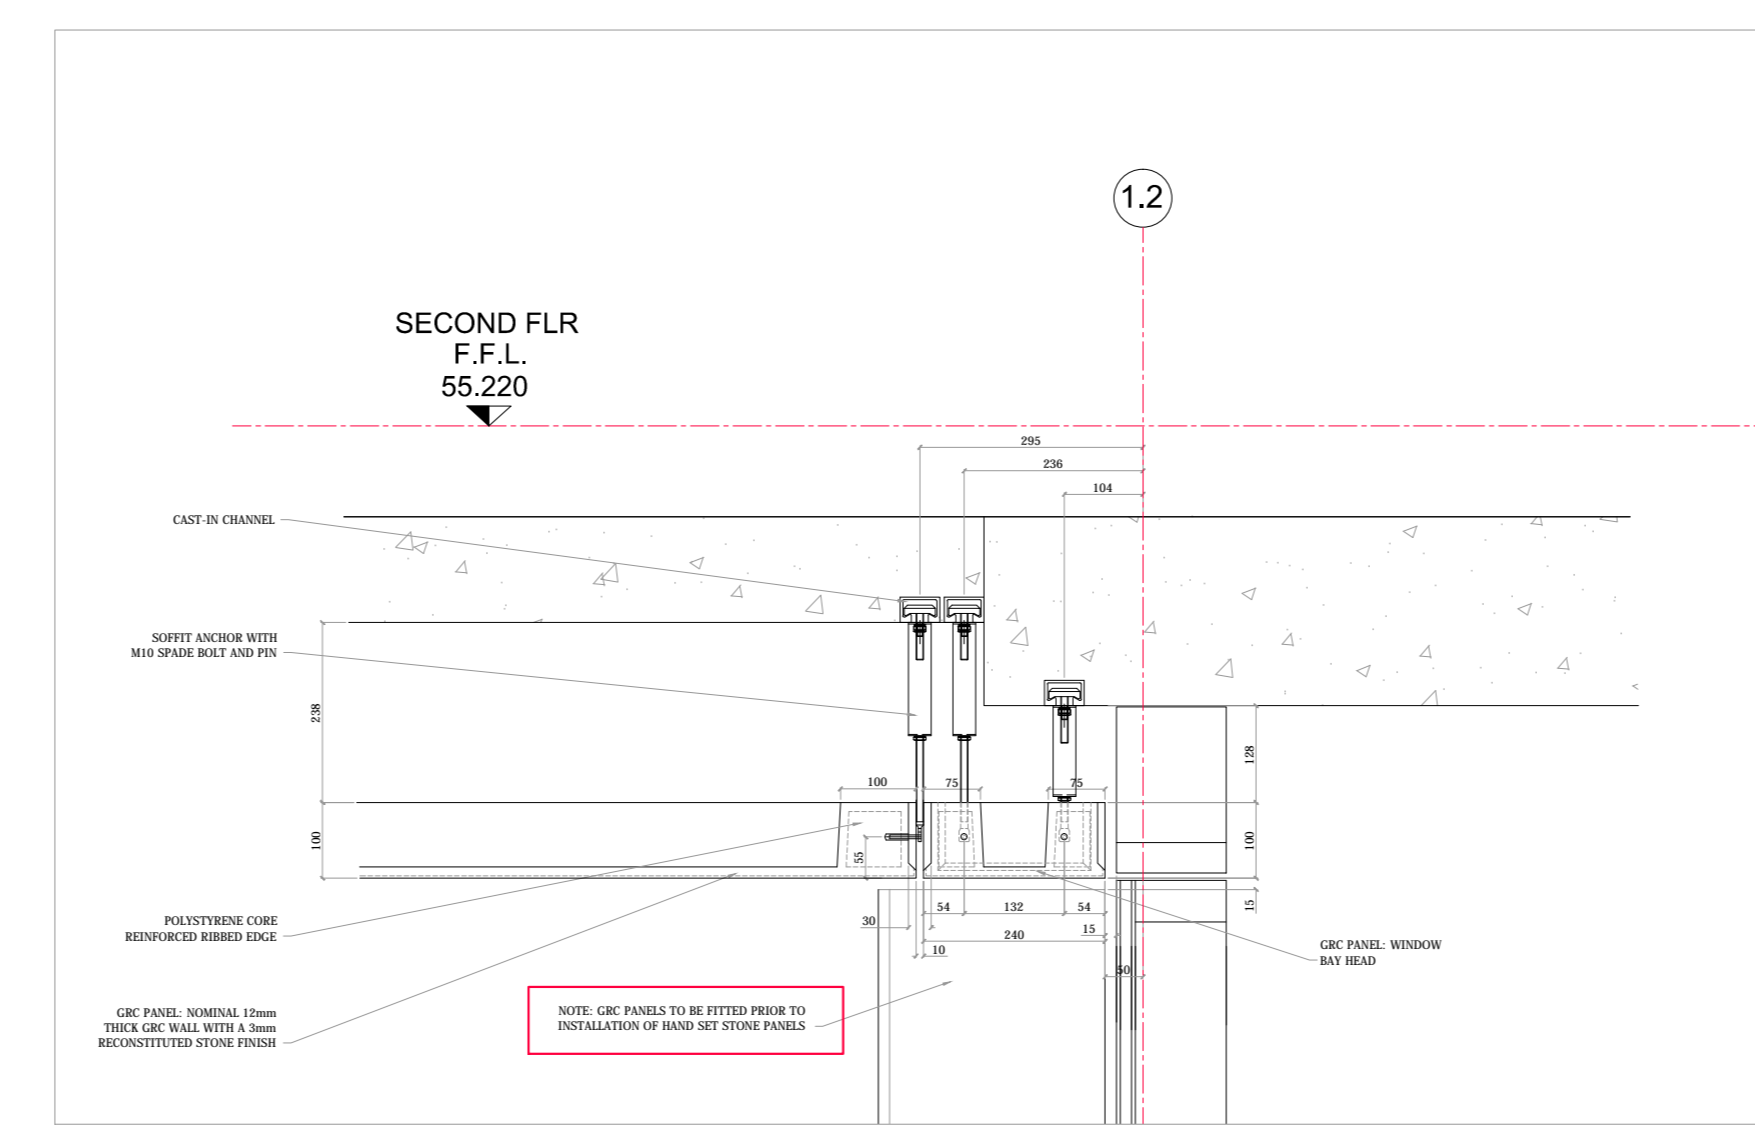

TYPICAL SECTION (ALONG GRIDLINE - 1.2)

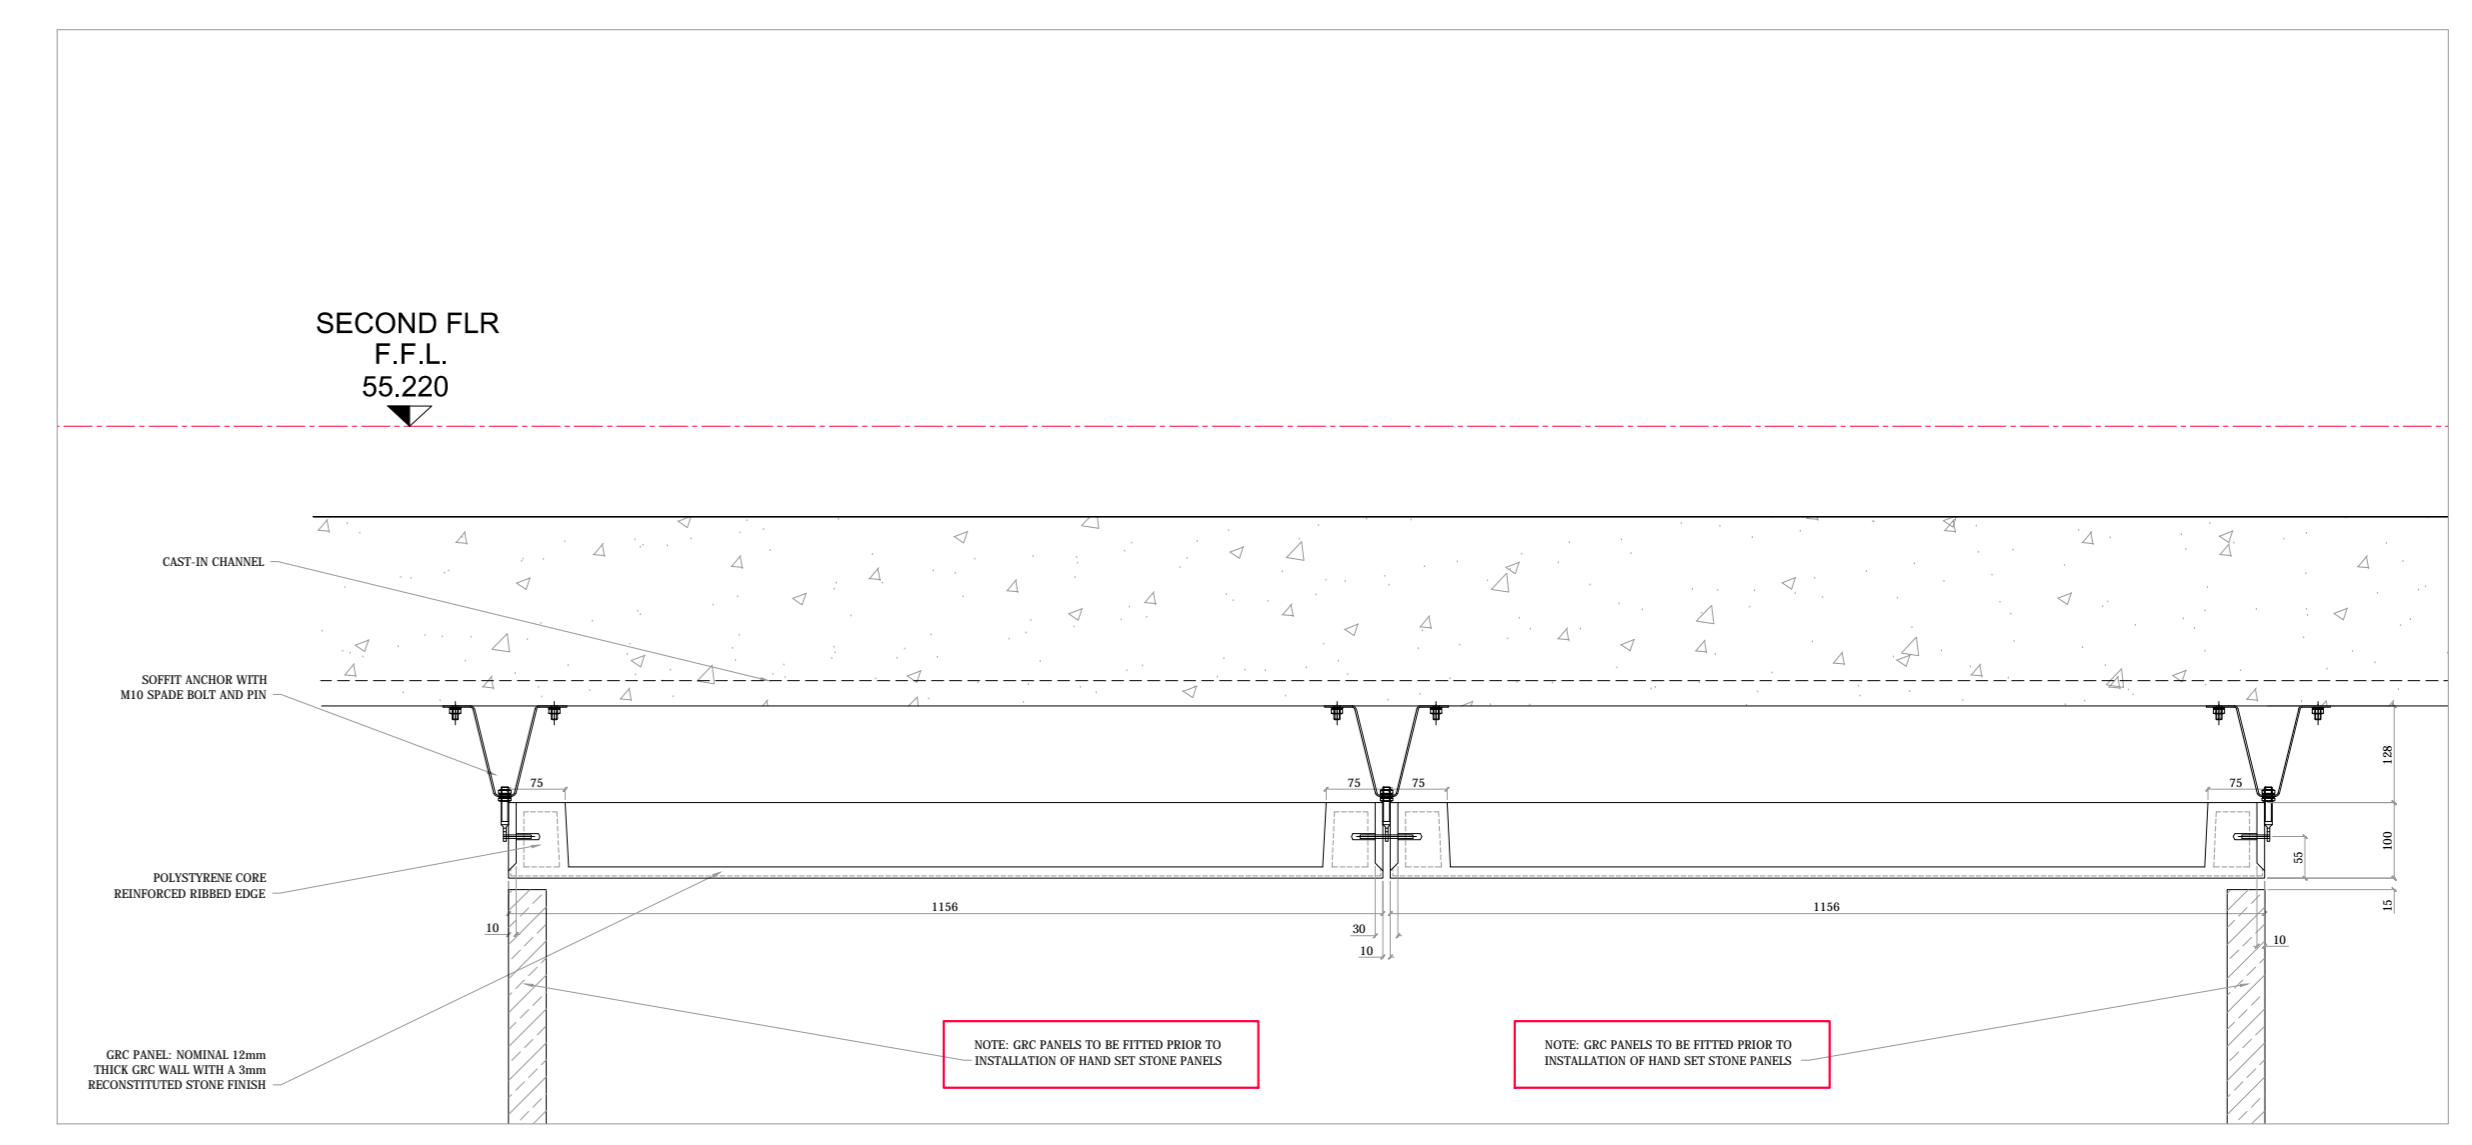

TYPICAL SECTION (THROUGH WINDOW BAY HEADS)

**BCM GRC Limited**  
 Unit 22 Civic Industrial Park  
 Wainhatch  
 Shepherson  
 SY13 1TT  
 Visit: www.bcmgcr.com  
 Tel: 01948 665321  
 Fax: 01948 666381  
 E-mail: info@bcmgcr.com



1. Do not scale.
2. Tolerances -3mm/+3mm.
3. All cast in sockets are stainless steel, therefore stainless steel bolts are required in all cases. Isolation washers will need to be implemented where galvanised steel occurs.
4. Torque setting for standard M8 ST/ST cast in sockets is 10.6Nm.

**CDM Regulations**  
 Design Risk Assessment:  
 The size and shape of individual stones for this project have been designed to satisfy the overall design requirements for the building. All persons handling and installing such stones should be aware that there are risks associated with this type of work that cannot be designed out.  
**RISK: INJURY**  
 Risk Reduction:  
 Fixers must be suitably experienced in the handling of stones and employ lifting methods appropriate to the size and shape of that component. Access and platforms must be to the standard required by current legislation. Reference must always be made to COSHH information for the materials being used.

Rev.	Reason For Issue	Date

This shop drawing is the property of Grants and is for use only by the contractor named.  
 It is not to be used for any other project without the prior written consent of Grants.  
 Do not scale drawing.

**GRANTS** INTERNATIONAL STONE CONTRACTORS  
 GRANTS OF SHOREDITCH LTD  
 GRANTS HOUSE, PROSPECT WAY  
 HUTTON, BRENTWOOD  
 ESSEX, CM11 1TD  
 Tel: 020 7700 0300 Fax: 020 7701 9610  
 E-mail: info@grants.com

Project:  
**ST EDMUNDS TERRACE  
 LONDON**

Architect:  
**SQUIRE AND PARTNERS**

Contractor:  
**MACE**

Drawing Title:  
**BLOCK 1  
 2nd FLOOR - UNDERCROFT  
 GRC Panel setting out**

Drawn By: TAG  
 Checked By: TAG  
 Scale: 1:50 / 1:10 @ A0  
 Date: 13.08.13  
 Revision: 0  
**3205-A-DR-2002**