

Where underground drainage runs enter into the existing manhole / proposed inspection chamber non return valves are to be provided to prevent sewer surcharging.

Front light well has been reduced by 225mm in depth.

Permeable paving is to be provided to the front and rear light wells.

All doors and window openings at basement level are to be provided with suitable flood barriers.

All gaps around cables/pipework entering the basement level are to sealed with silicone sealants or re-pointing mortar.


Any vents are to be provided with suitable covers.

If deemed necessary re-point brickwork at basement level.

All doors and windows at basement level are to be flood proof units installed in strict accordance with the manufacturers instructions / recommendations.

Additional flood resilience measures to be taken at basement level:


- Electric sockets to be raised by approximately 600mm above the estimated flood level.
- Installation of a stainless steel kitchen, with raised appliances.
 Water proof plaster to be used
- Water proof plaster to be used throughout the basement.
- Floors to the basement area are to be concrete, providing floor tiles. No carpet to be installed.

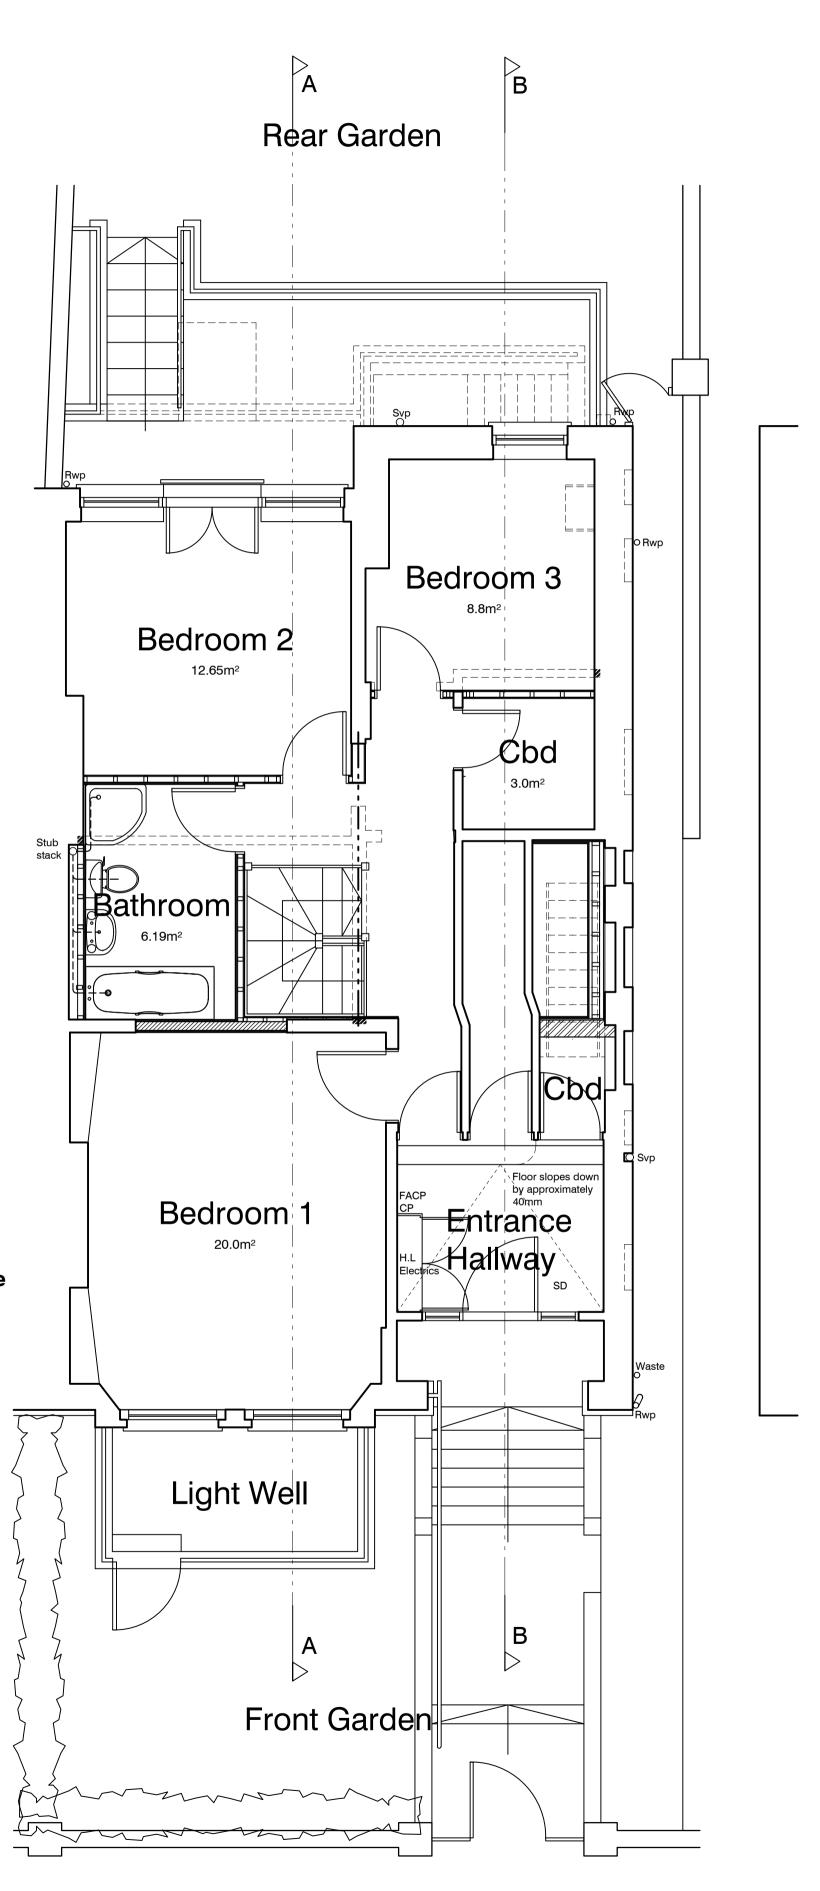

GROUND FLOOR PLAN


REPORT ERRORS AND OMISSIONS TO THE ARCHITECT CHECK ALL DIMENSIONS BEFORE FABRICATION

| REVISION | | DRAWN | CHK'D | D |
|----------|--|-------|-------|--------|
| Rev A. | Clients amendments: Various areas. | C.J. | - | 07.05. |
| Rev B. | Location Plans added to drawing. | C.J. | - | 14.08. |
| Rev C. | Assumed existing and proposed drainage shown. | C.J. | - | 30.09. |
| Rev D. | Planning amendments: Additional notes added to drawing. | C.J. | - | 18.12. |
| Rev E. | Planning amendments: Front garden shown. | C.J. | - | 20.01. |

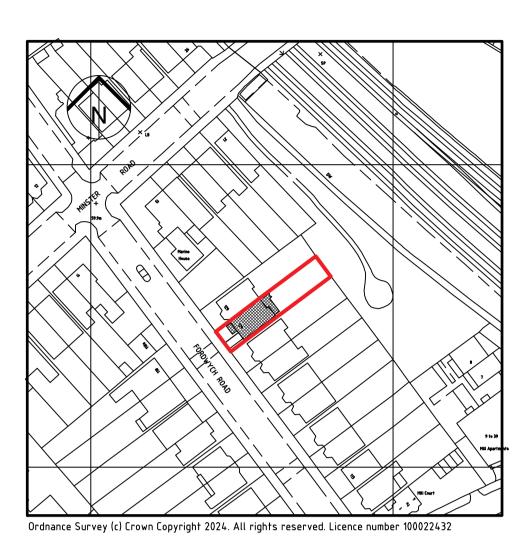


LOCATION PLAN

(Scale 1:1250)

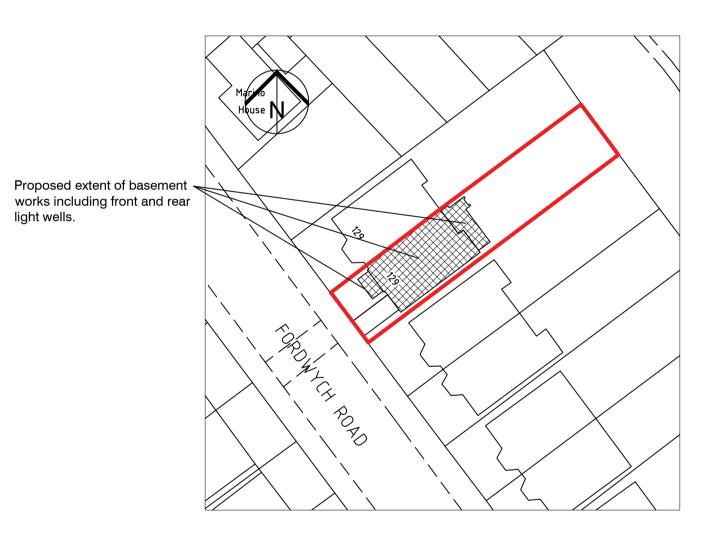

BLOCK PLAN (Scale 1:500)

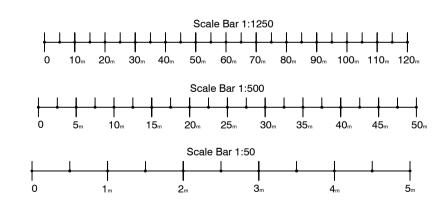

| CHECKED | CHECKED | |
|---------|----------------------|--|
| DRAWN | C.J. | |
| DATE | April 2024. | |
| SCALE | 1:50, 1:500, 1:1250. | |
| | DATE | |

Proposed Basement / Ground 24102_003. Floor Plans & Location Plans.



Architects + Building Surveyors

Front Garden