





01 Existing Drainage Plan
Scale 1 : 200

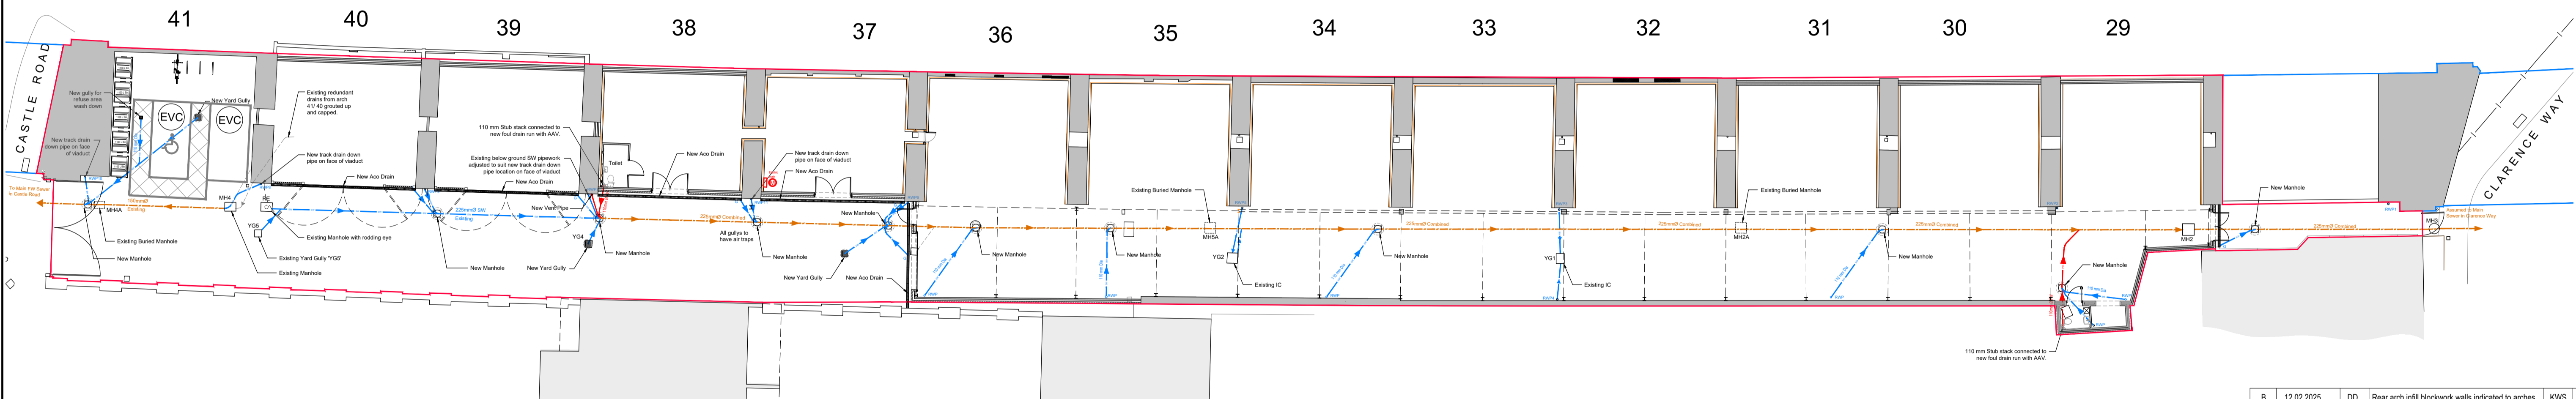

DRAINAGE KEY:
MH = Manhole
RE = Rodding eye
WC = Water closet
ACO = Linear SW channel
YG = Yard gully - Catch pit
RWP = Rainwater pipe

--- Foul Water
--- Surface Water
--- Combined

02 Proposed Drainage Plan
Scale 1 : 200

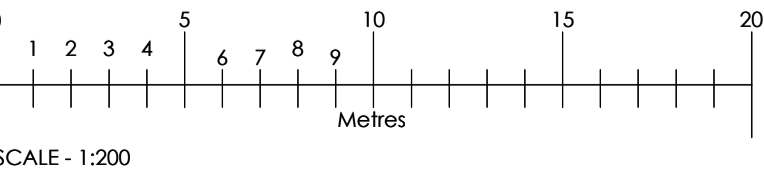

- Notes:
- Copyright: The contents of this drawing may not be reproduced in whole or in part without the written consent of Robinson Kenning & Gallagher.
 - All dimensions to be checked on site by Contractor.
 - Where discrepancy occurs between specification and drawings then Robinson Kenning & Gallagher must be notified immediately.

B	12.02.2025	DD	Rear arch infill blockwork walls indicated to arches 40 and 39.	KWS	KWS
A	24.01.2025	DD	Application Site Boundary Revised	KWS	KWS
REV	DATE	BY		CHK	ATHD

DRAWING STATUS:	PLANNING
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PROJECT:
Arches 29-41 Castle Mews
Castle Road, London NW1 8SY

TITLE:
Existing and Proposed Drainage Plans

SCALE @ A1: 1:200	CHECKED: KWS	APPROVED: KWS
CAD FILE: 1728 DRAINAGE EXISTING.dwg	DESIGN DRAWN: DPD	DATE: 10/04/2024
PROJECT No: 4758	DRAWING No: 23-4758-PD-013	REV: B