


0m 2m 4m 6m 8m 10m 20m

Scale 1:200

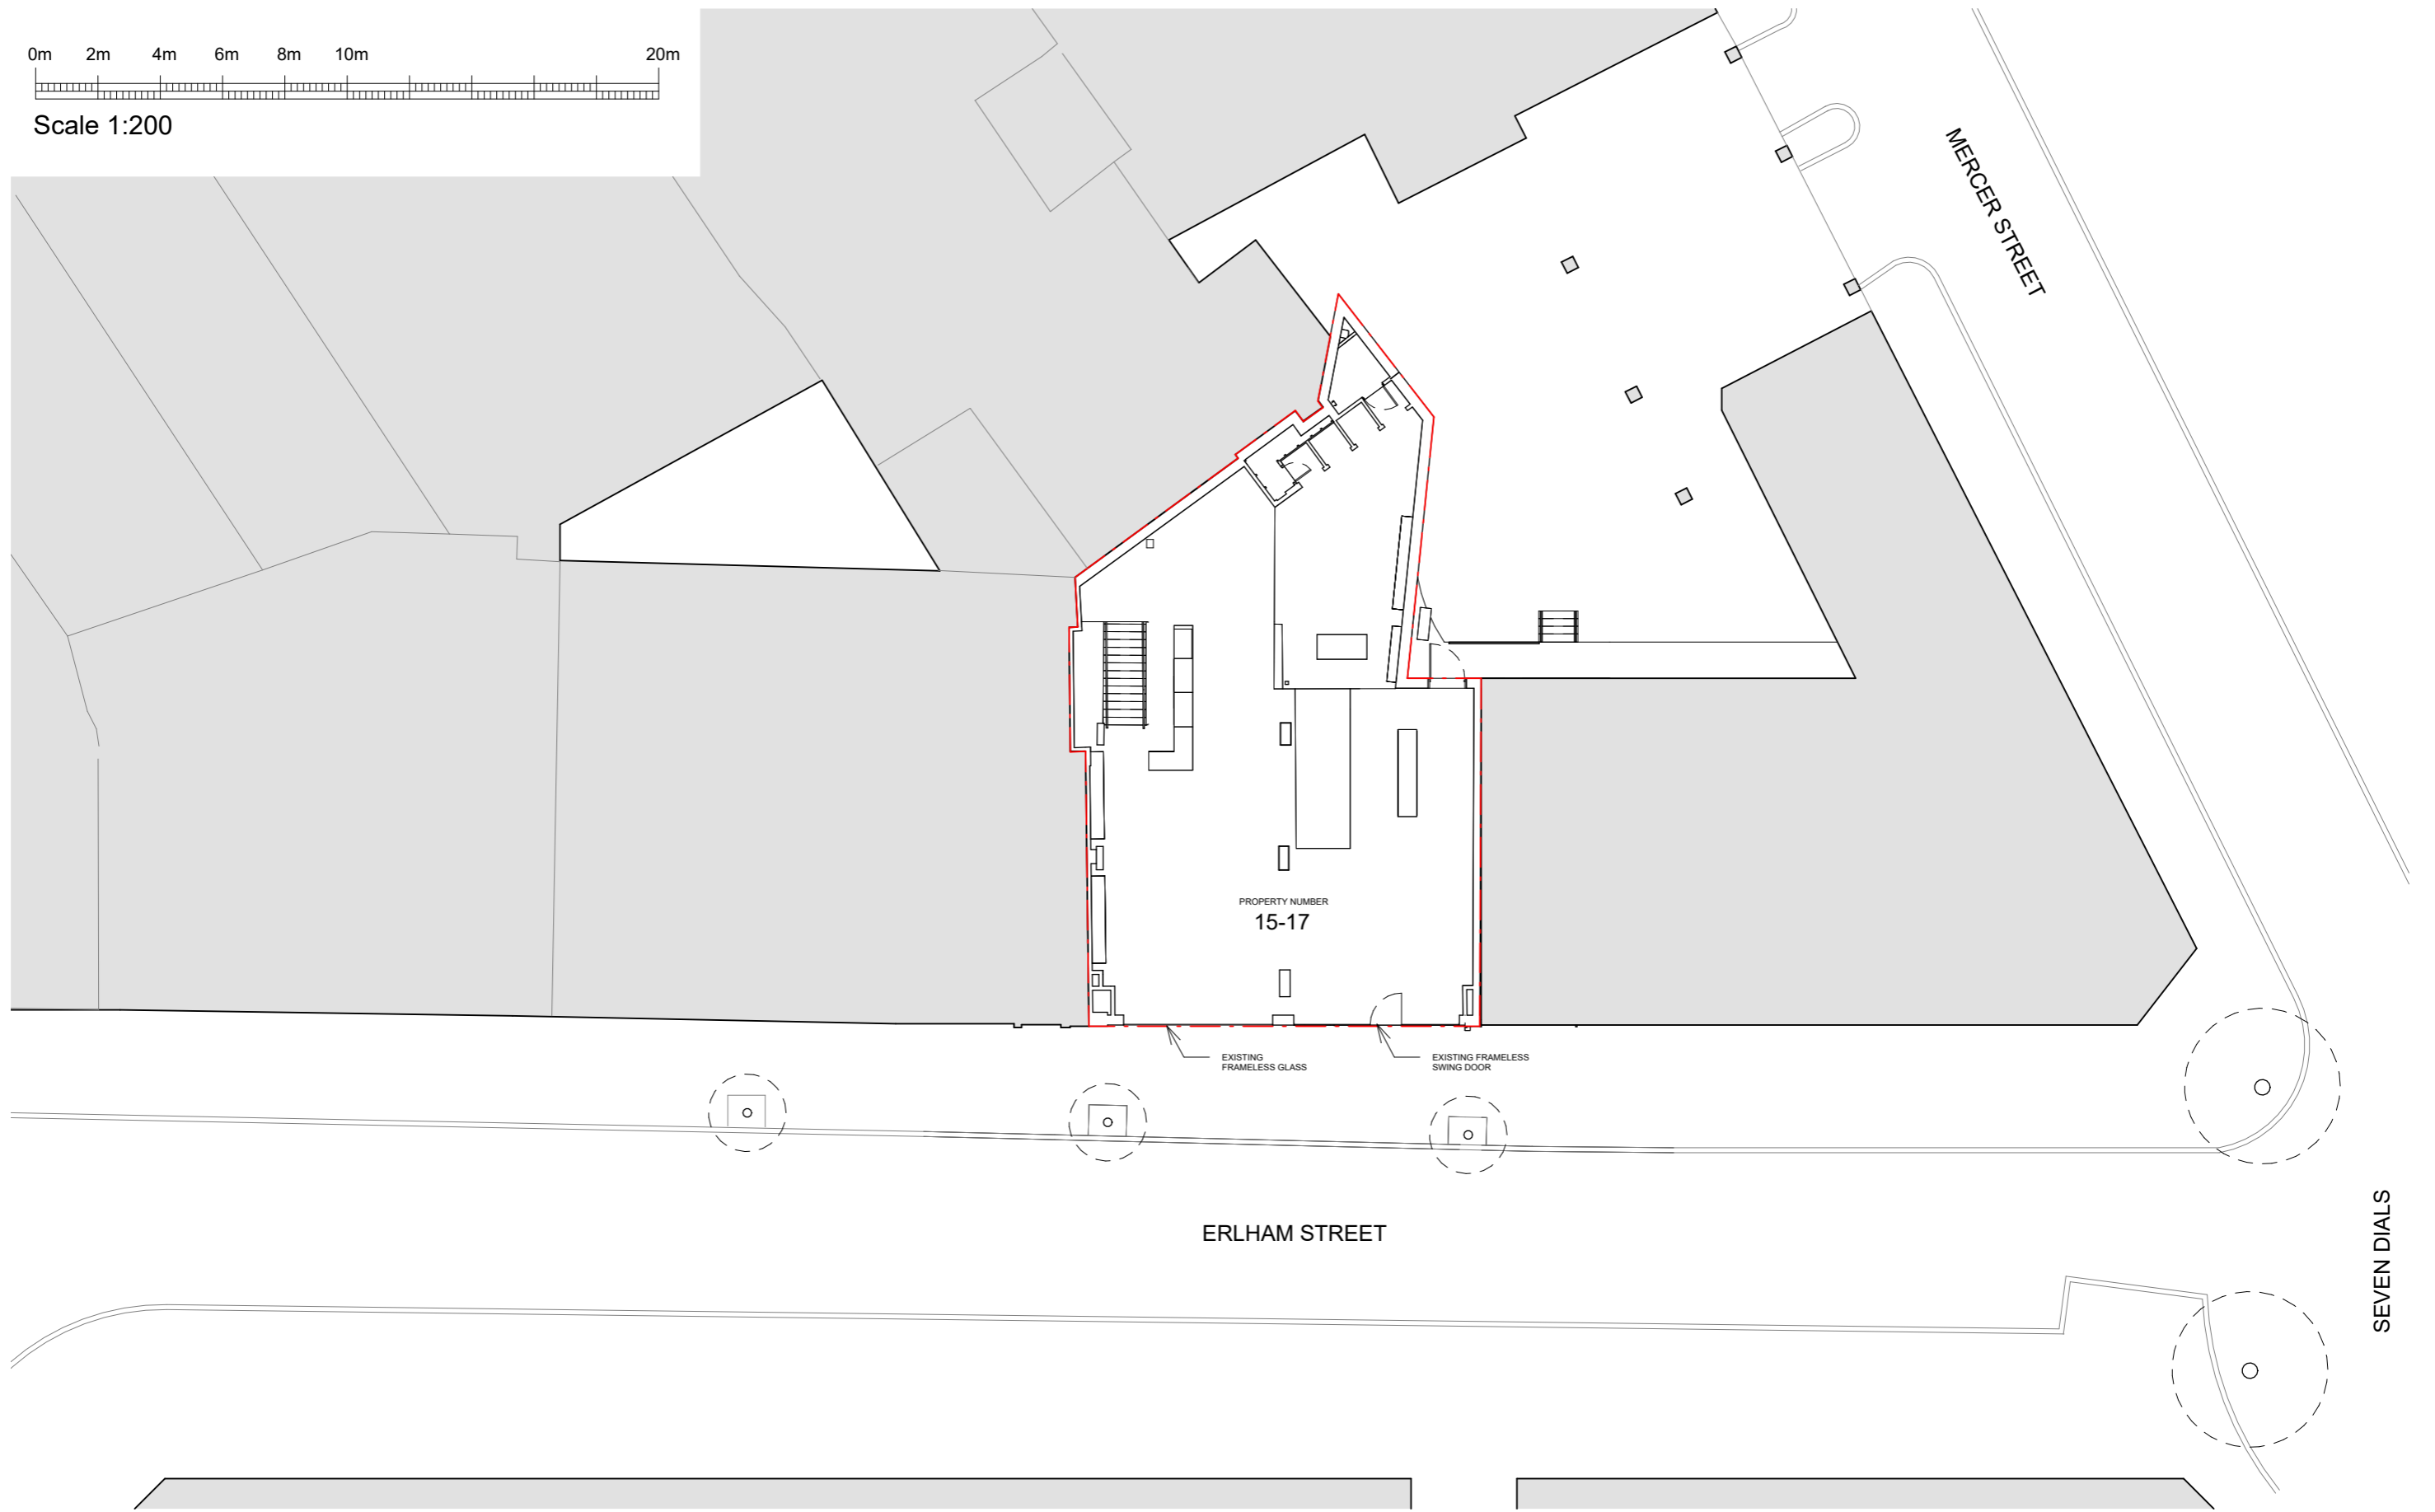

CAIRN

The sizing of all structural and service elements must always be checked against the relevant engineer's drawings. No reliance should be placed upon sizing information shown on this drawing.

All areas are approximate and measured off preliminary drawings. They relate to the likely area of the building at the current state of the design and using the stated option either in accordance to client standards or the RICS Code of Measuring Practice, 6th Edition, RICS/ISVA. Any decisions to be made on the basis of these predictions, whether as to project viability, pre-letting, lease agreements or the like should include due allowances for the increases and decreases inherent in the design development and building process. Report all drawing errors, omissions and discrepancies to the architect.

--- DESIGN BOUNDARY



REV	DATE	DESCRIPTION	INT RB

PROJECT TITLE
Project Name

DRAWING TITLE
Existing Site Plan

DRAWING NO.
24009 PL_0002

DRAWN
RB

CHECKED
KH

SCALE
As indicated@A2

REVISION

SEVEN DIALS