




FRONT ELEV
scale 1:200




BACK ELEV
scale 1:200

NOT PART OF APPLICATION SITE

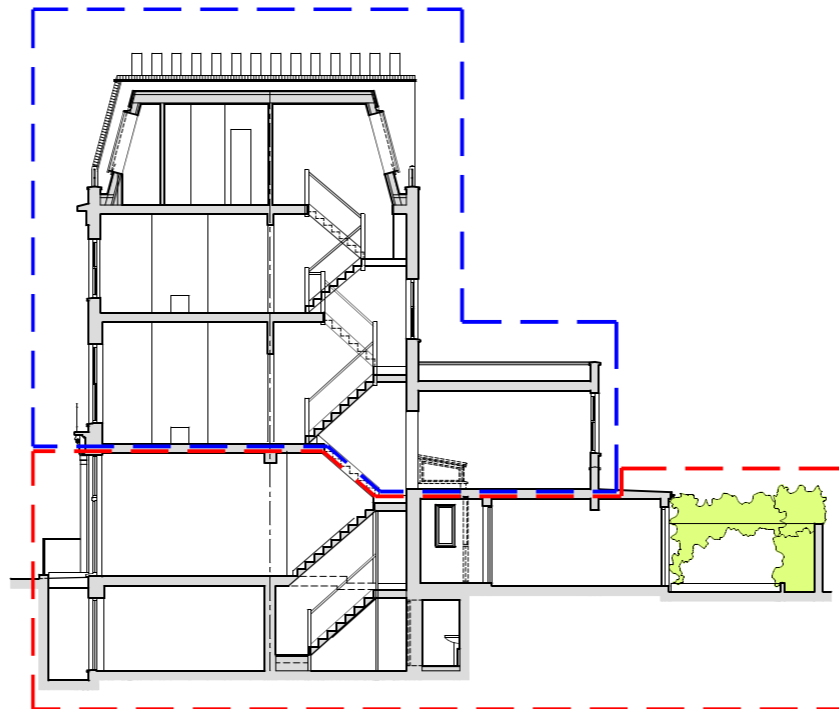


SECTION R1
scale 1:200

NOT PART OF APPLICATION SITE

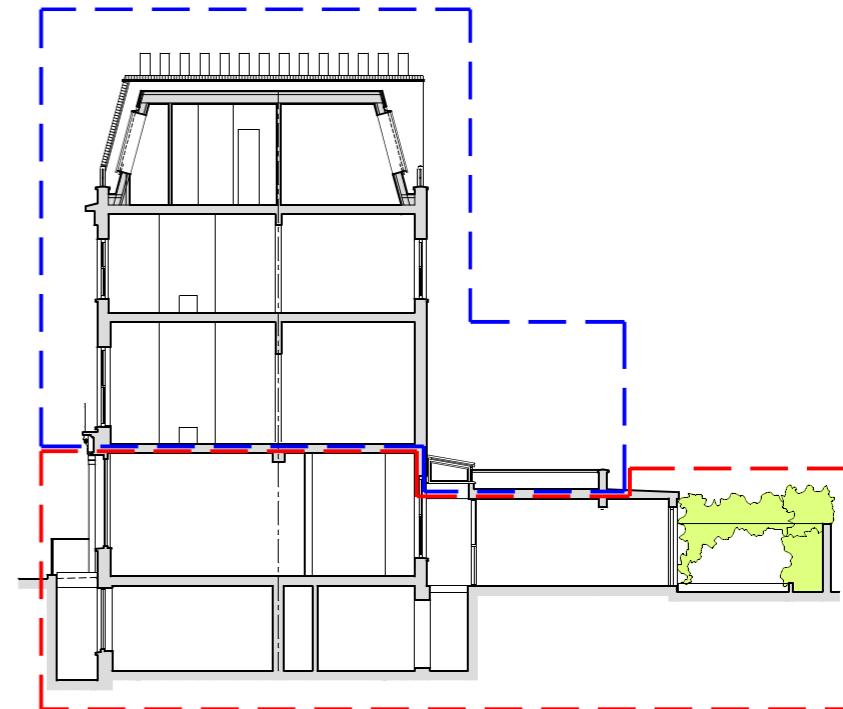


SECTION R2
scale 1:200




NOTE:
Site area 103.00m²

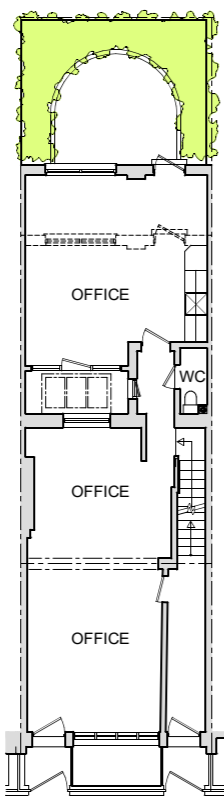

GROUND FL.
scale 1:200

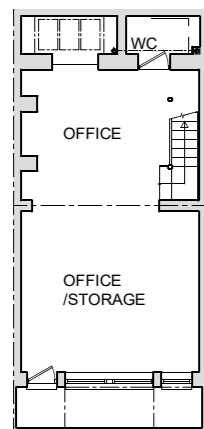


BASEMENT
scale 1:200

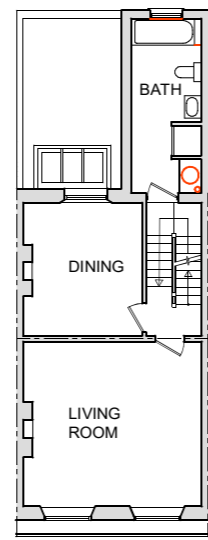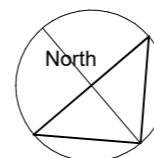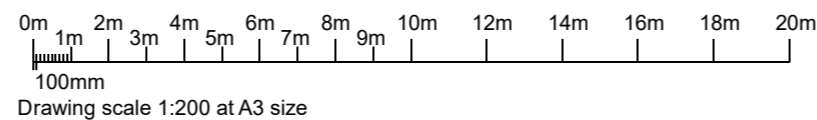


FIRST FL.
scale 1:200

NOTE:


Basement and ground floors comprise the application site, and have been recently measured for these drawings, but the first, second and third floor plans, which are not part of the application site, were not accessible and so are based upon older drawings by others, and so may not be as accurate or fully up to date.

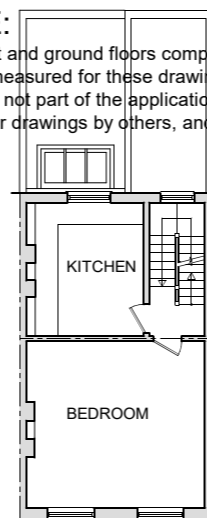

SECOND FL.
scale 1:200

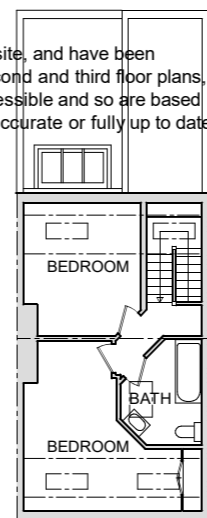

THIRD FL.
scale 1:200

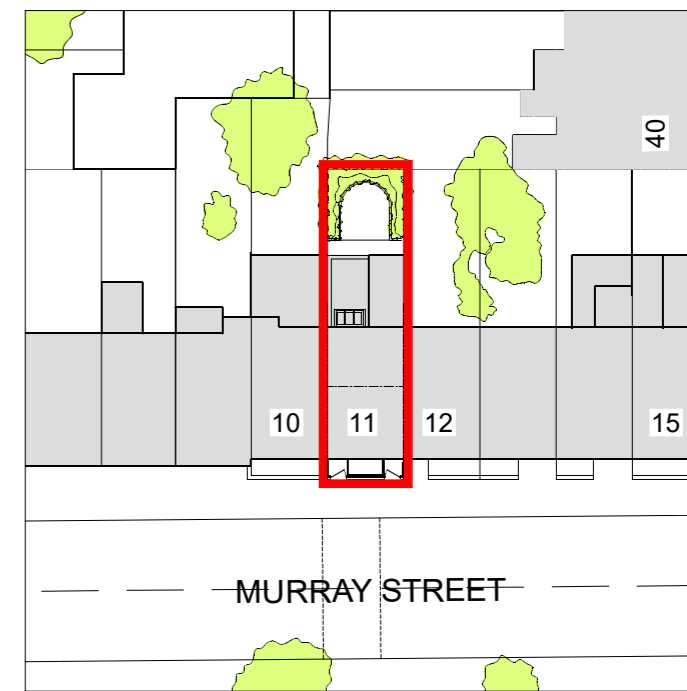

BLOCK PLAN scale 1:500

NOT PART OF APPLICATION SITE



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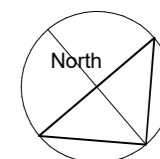
Architecture
Interior Design
Product Design
Graphic Design

CLIENT Richard Preece Esq.	PROJECT DESCRIPTION Installation of enlarged front basement windows and back GF extension
ORGANISATION via Bell Cornwell	PROJECT LOCATION 11 Murray Sreet, London NW1 9RE


PROJECT TITLE 11 Murray Street: New front basement windows & back GF extension	DRAWING TYPE PLANNING
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DRAWING General arrangement as proposed Block plan	SCALE 1:200 1:500
NOTES CHECK SCALE BAR IF SCALING FROM THIS DRAWING. USE FIGURED DIMENSIONS WHERE POSSIBLE	DATE 12-08-24


REVISION NOTE	DATE	SUFFIX
DRAWING NO. N2411/01/01	REVISION A	




NOTE:
Site area 103.00m²

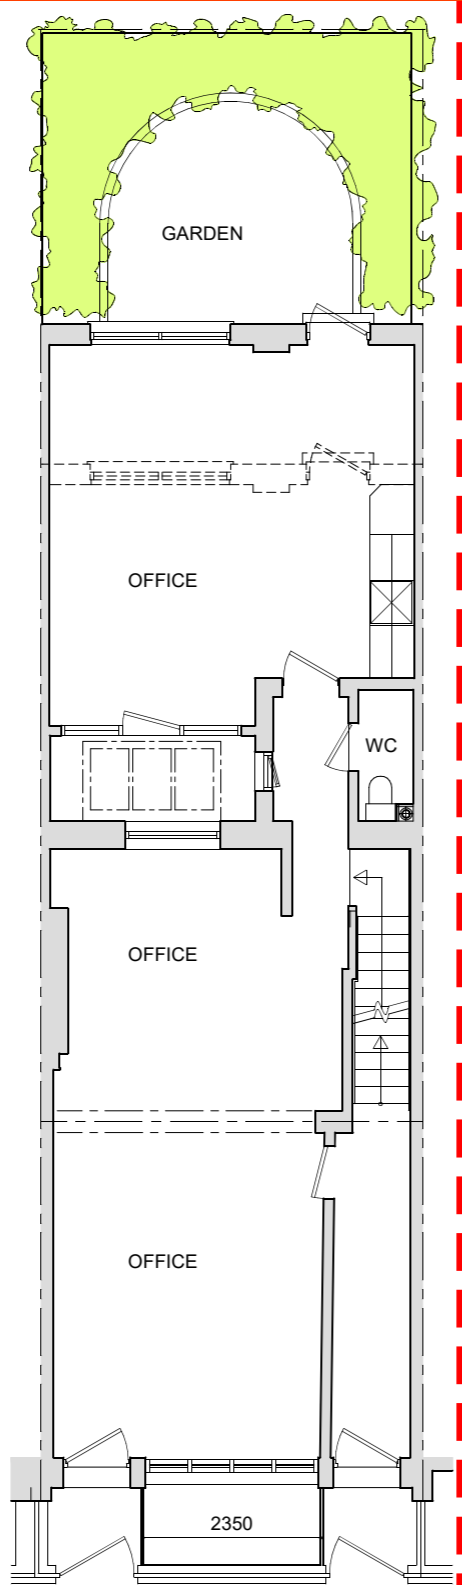

GROUND FL. GIA = 63.1 m²
scale 1:100

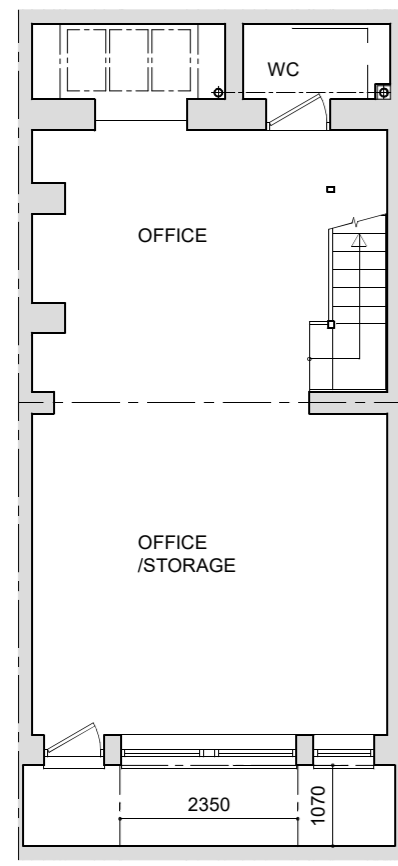

BASEMENT GIA = 44.2 m²
scale 1:100

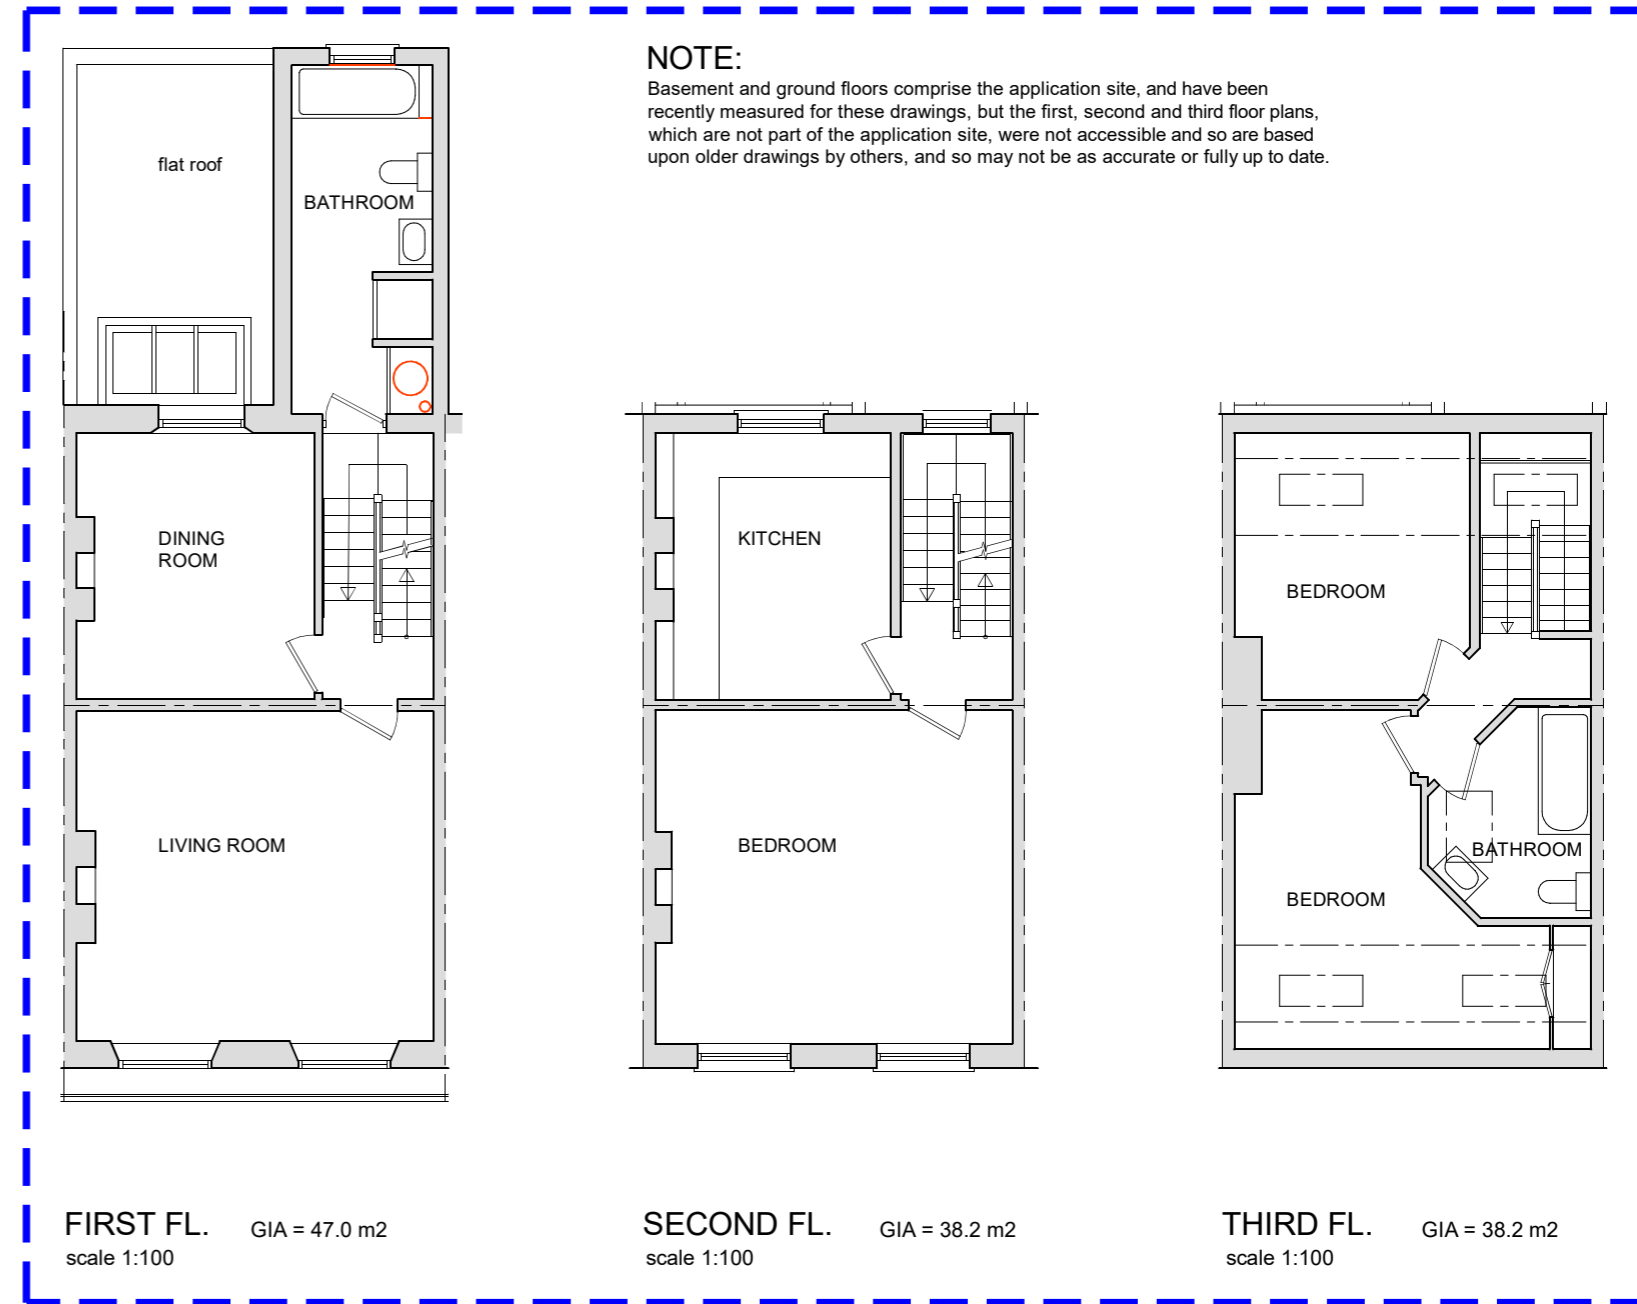

NOTE:
Basement and ground floors comprise the application site, and have been recently measured for these drawings, but the first, second and third floor plans, which are not part of the application site, were not accessible and so are based upon older drawings by others, and so may not be as accurate or fully up to date.

FIRST FL. GIA = 47.0 m²
scale 1:100

SECOND FL. GIA = 38.2 m²
scale 1:100

THIRD FL. GIA = 38.2 m²
scale 1:100

APPLICATION SITE

NOT PART OF THE APPLICATION SITE



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ORGANISATION via Bell Cornwell	PROJECT LOCATION 11 Murray Sreet, London NW1 9RE

PROJECT TITLE 11 Murray Street: New front basement windows & back GF extension	DRAWING Floor plans as proposed
DRAWING TYPE PLANNING	NOTES CHECK SCALE BAR IF SCALING FROM THIS DRAWING. USE FIGURED DIMENSIONS WHERE POSSIBLE



SCALE 1:100	DATE 12-08-24
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REVISION NOTE	DATE	SUFFIX
DRAWING NO. N24111/01/02		REVISION A




FRONT ELEVATION
scale 1:100


Enlarged windows and glazed door to front light well.
All brickwork withing light well to be painted white to maximise reflectance and internal daylight levels

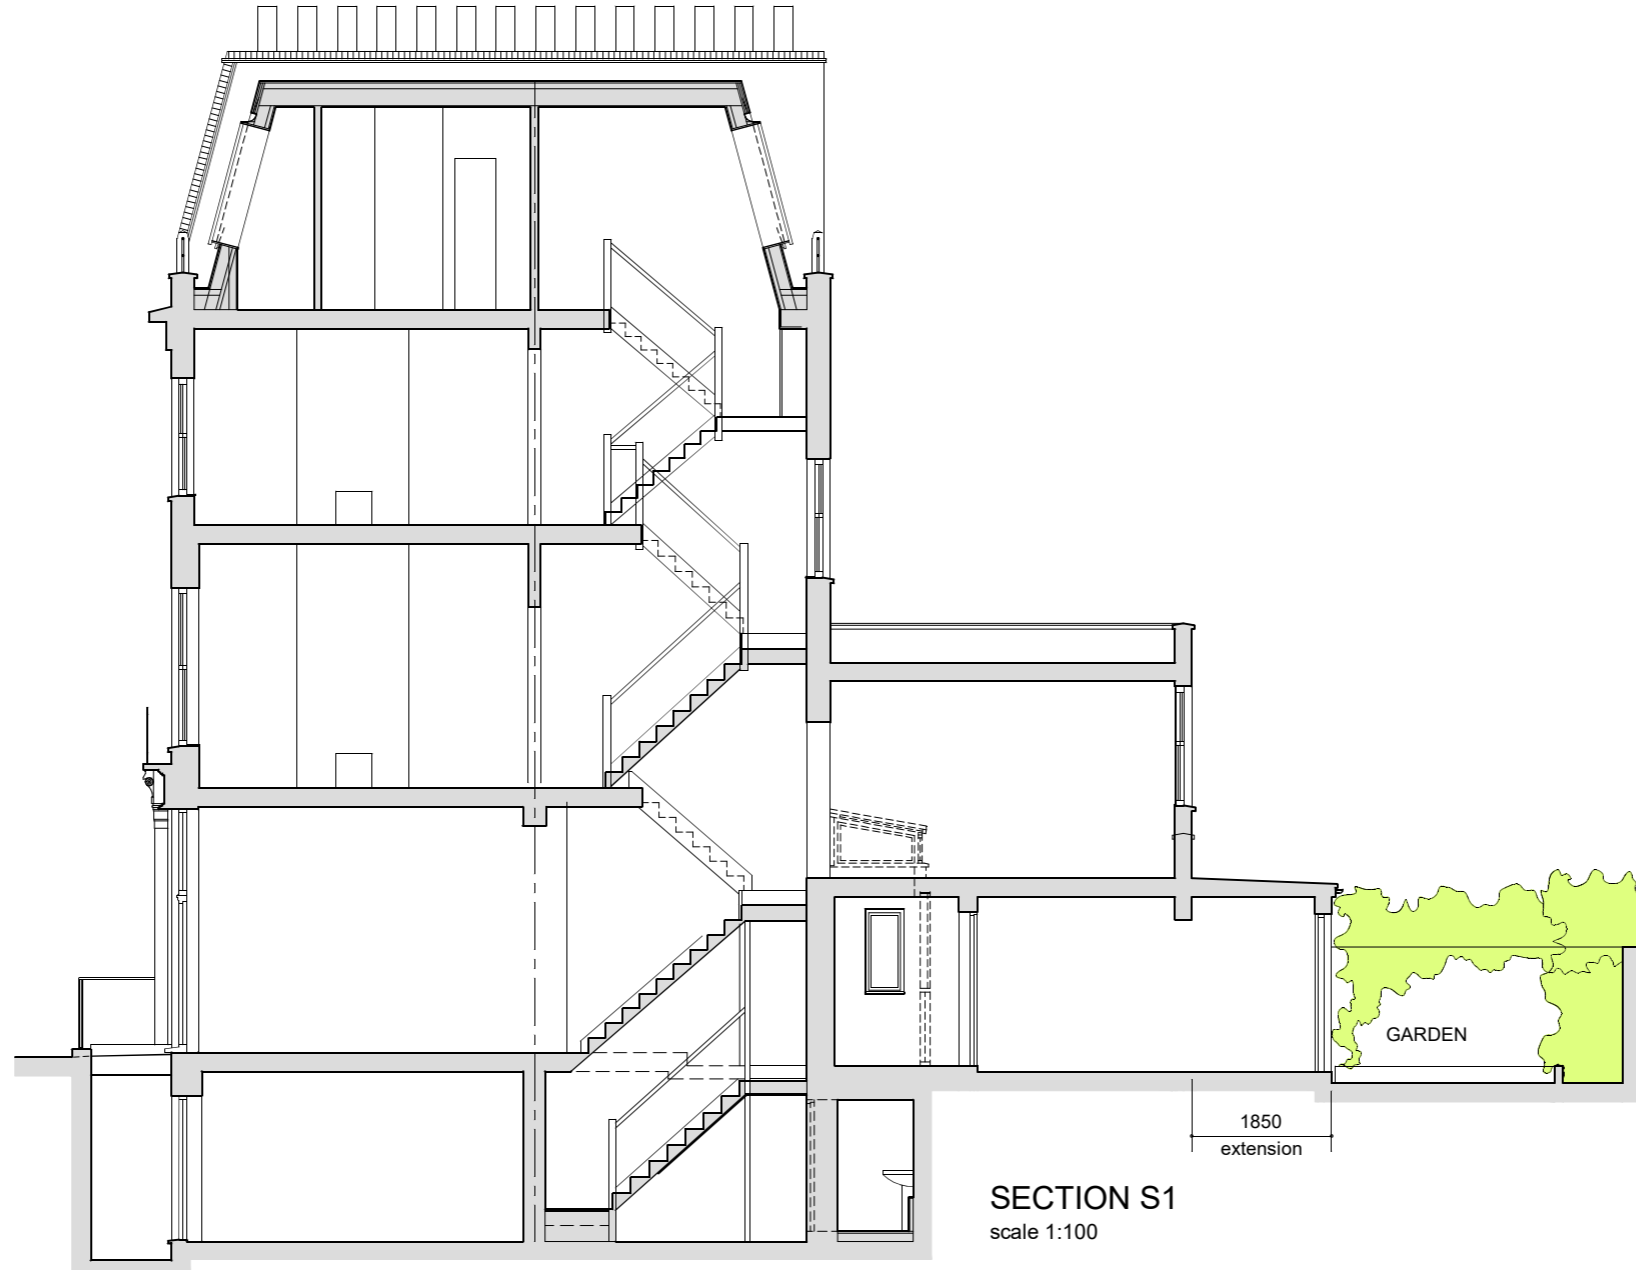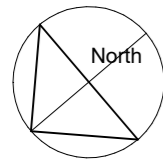

SECTION S1
scale 1:100

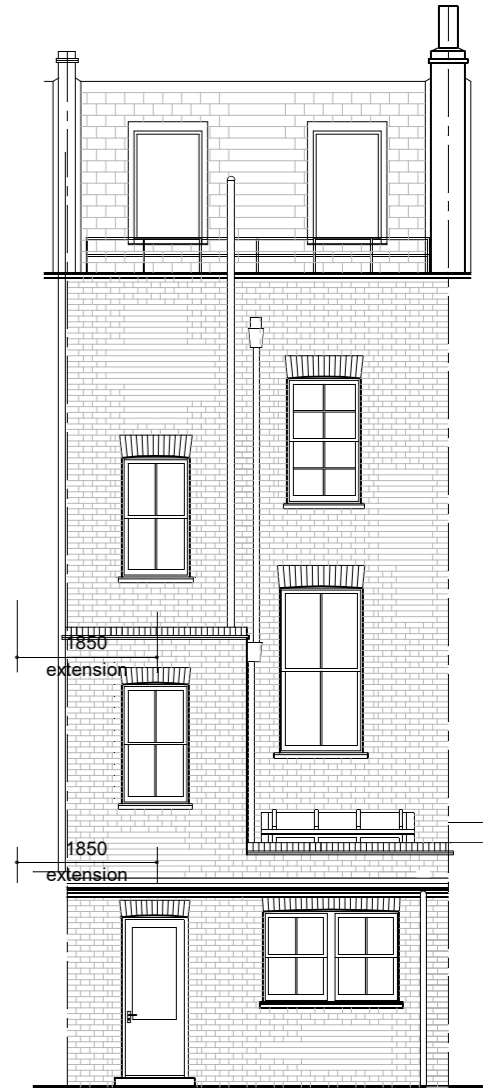

BACK ELEVATION
scale 1:100

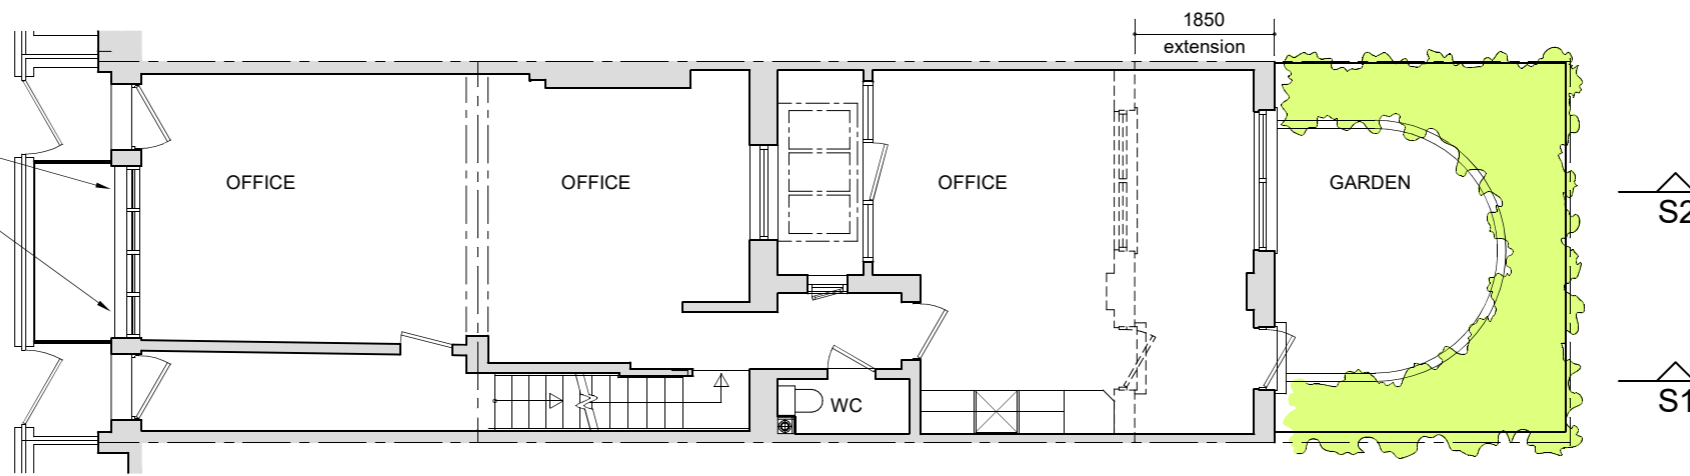

GROUND FLOOR PLAN
scale 1:100



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ORGANISATION via Bell Cornwell	PROJECT LOCATION 11 Murray Sreet, London NW1 9RE

PROJECT TITLE 11 Murray Street: New front basement windows & back GF extension	DRAWING TYPE PLANNING
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DRAWING Ground floor plan, Section 1 & Elevations, as proposed	NOTES CHECK SCALE BAR IF SCALING FROM THIS DRAWING. USE FIGURED DIMENSIONS WHERE POSSIBLE
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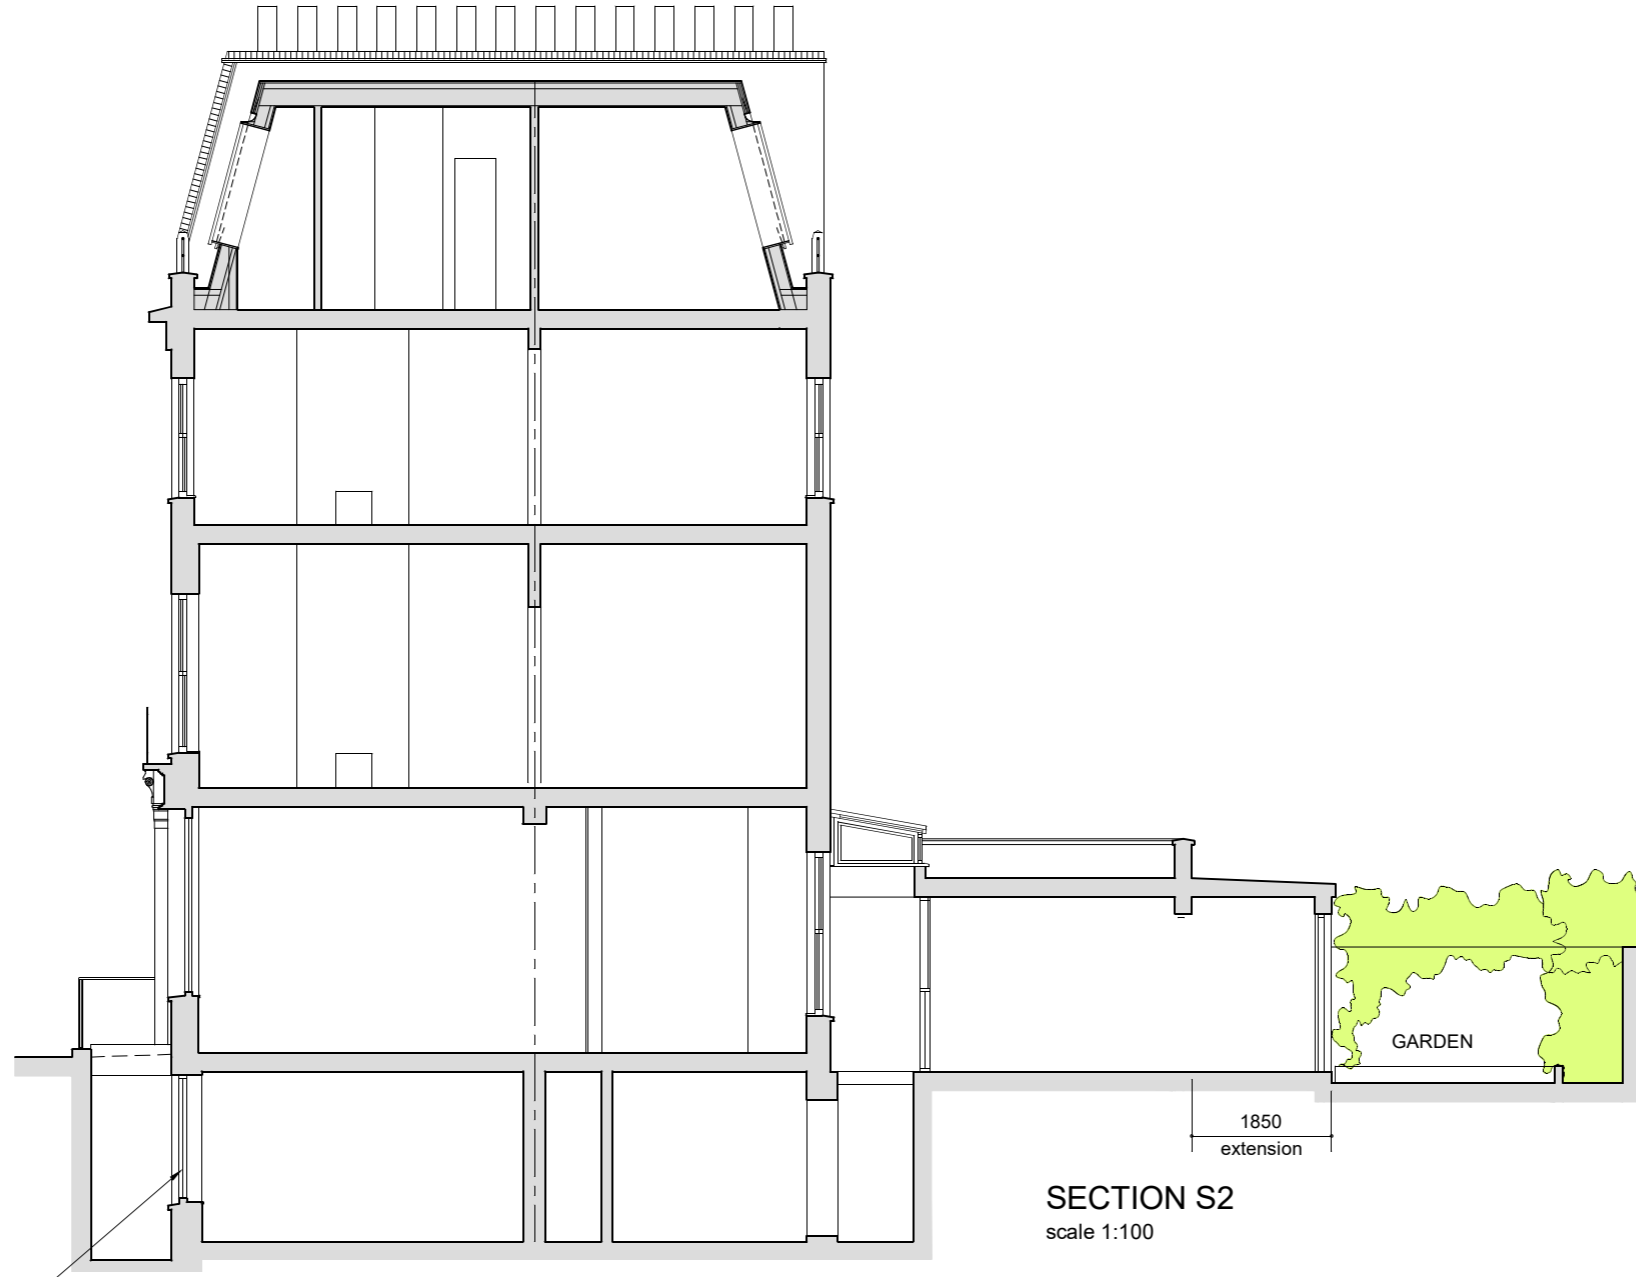
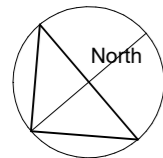
SCALE 1:100	DATE 12-08-24
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REVISION NOTE	DATE	SUFFIX
DRAWING NO. N2411/01/03		REVISION A




FRONT ELEVATION
scale 1:100


Enlarged windows and glazed door to front light well.
All brickwork withing light well to be painted white to maximise reflectance and internal daylight levels



SECTION S2
scale 1:100

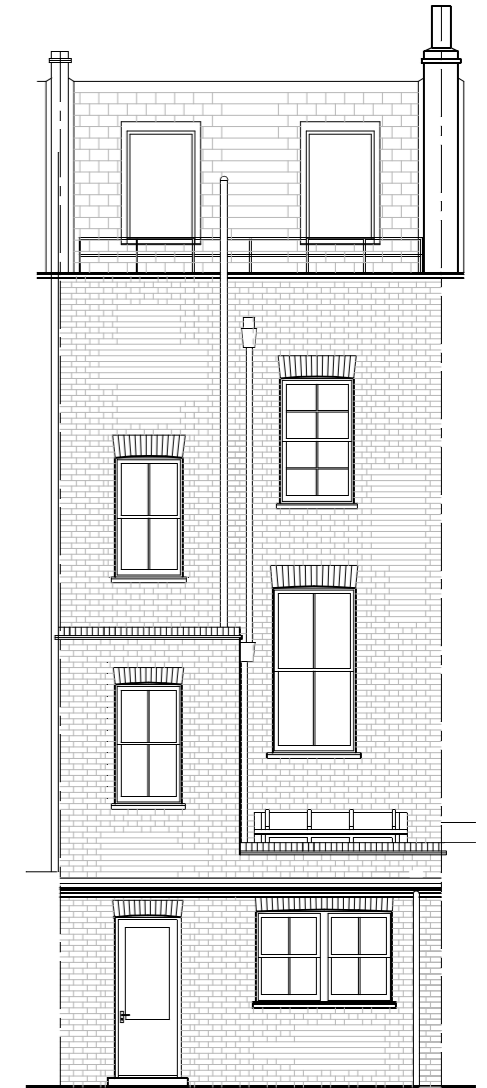

BACK ELEVATION
scale 1:100

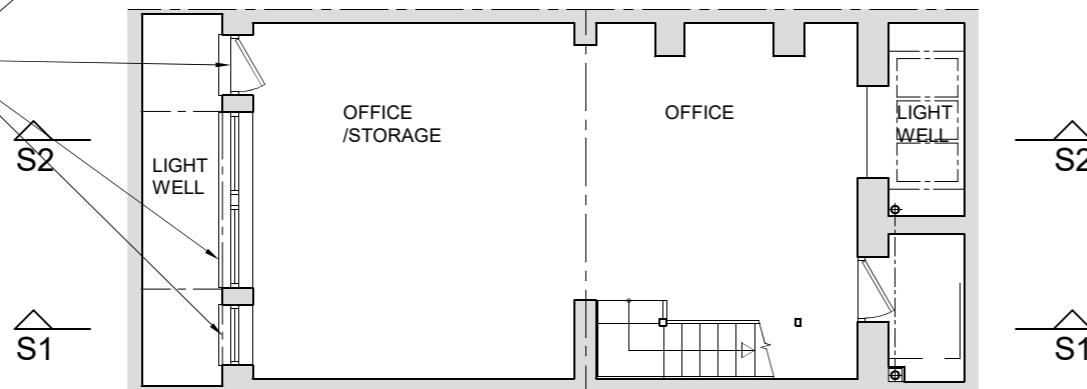

BASEMENT PLAN
scale 1:100



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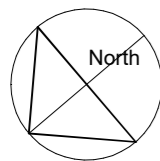
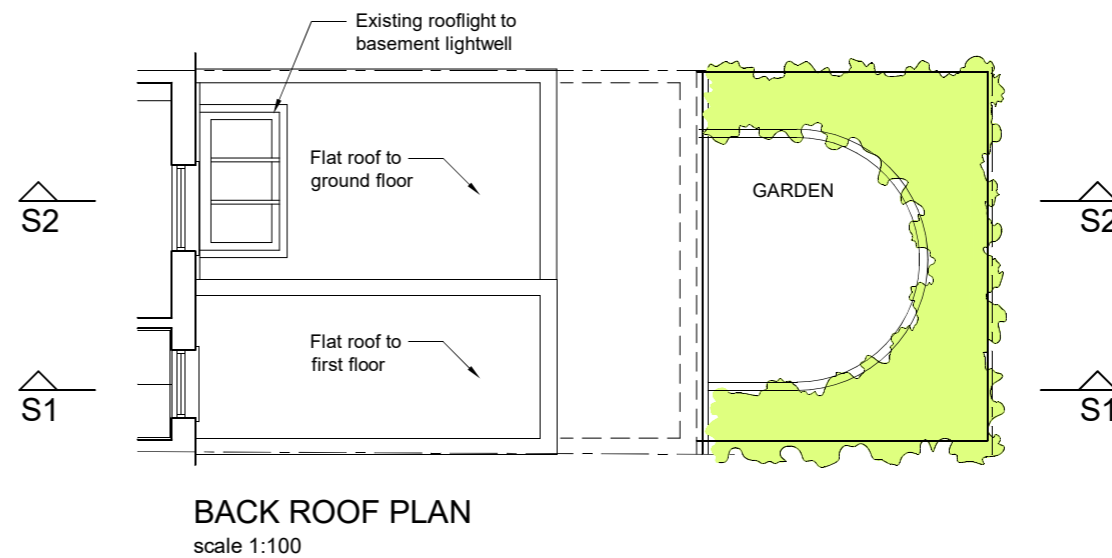
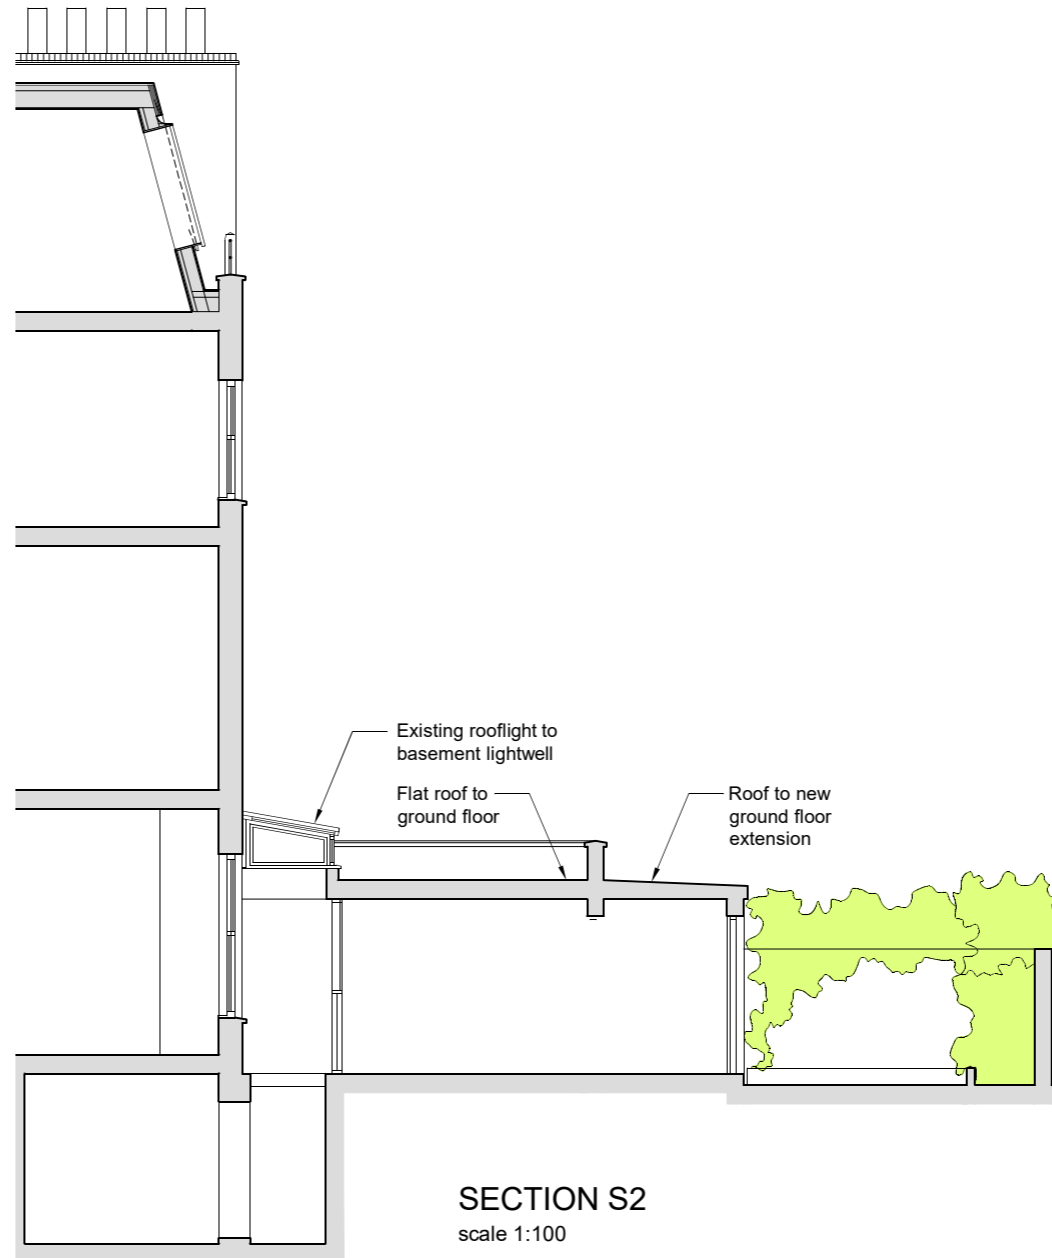
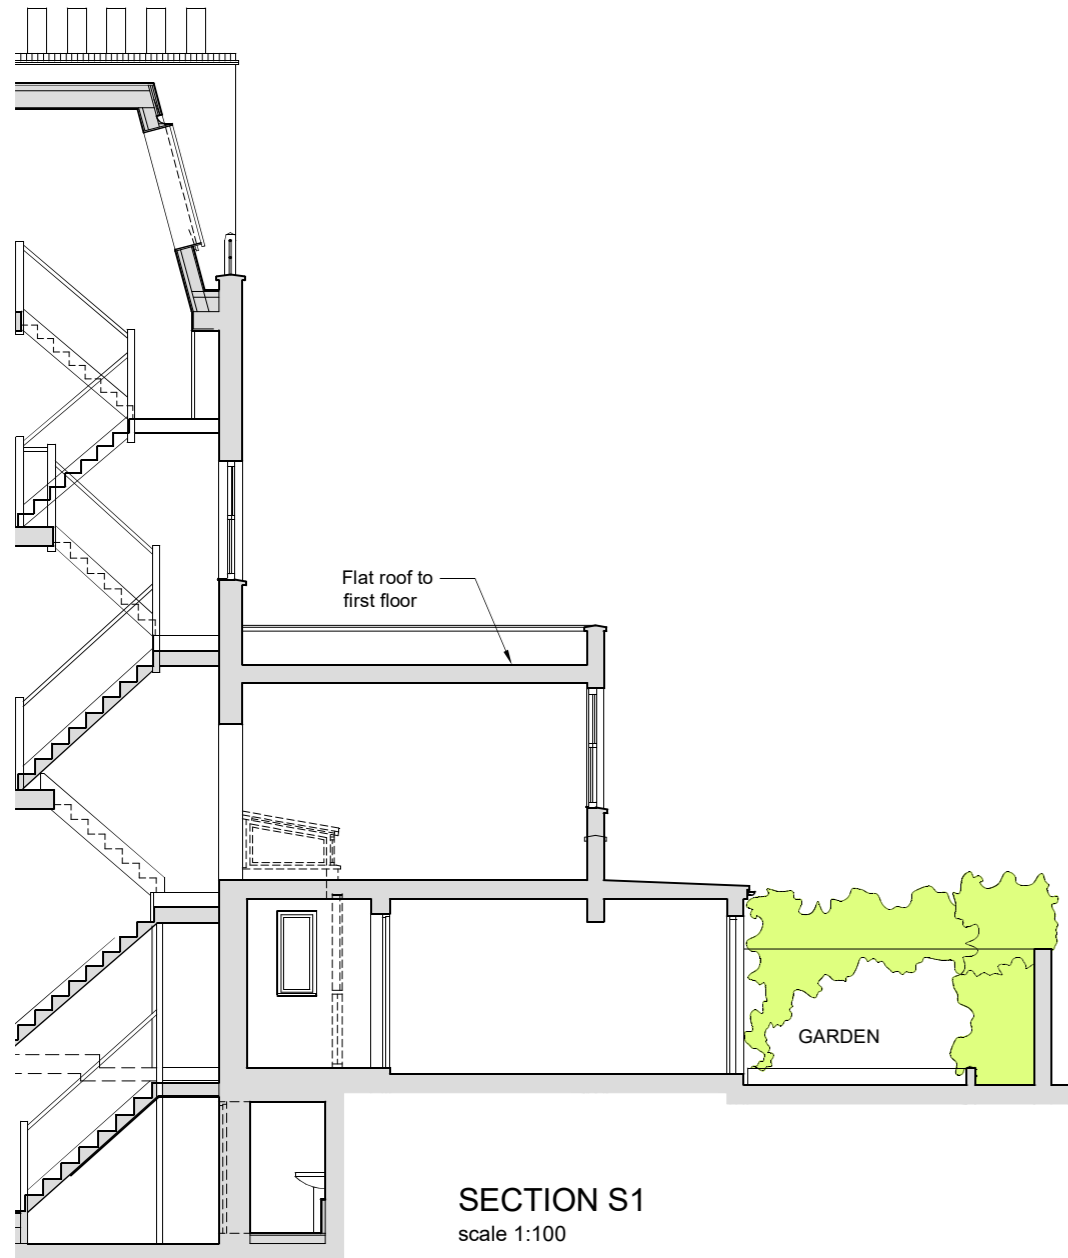
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ORGANISATION via Bell Cornwell	PROJECT LOCATION 11 Murray Sreet, London NW1 9RE

PROJECT TITLE 11 Murray Street: New front basement windows & back GF extension
DRAWING TYPE PLANNING

DRAWING Basement plan, Section 2 & Elevations, as proposed
NOTES CHECK SCALE BAR IF SCALING FROM THIS DRAWING. USE FIGURED DIMENSIONS WHERE POSSIBLE

SCALE 1:100
DATE 12-08-24

REVISION NOTE	DATE	SUFFIX
DRAWING NO. N2411/01/04		REVISION A



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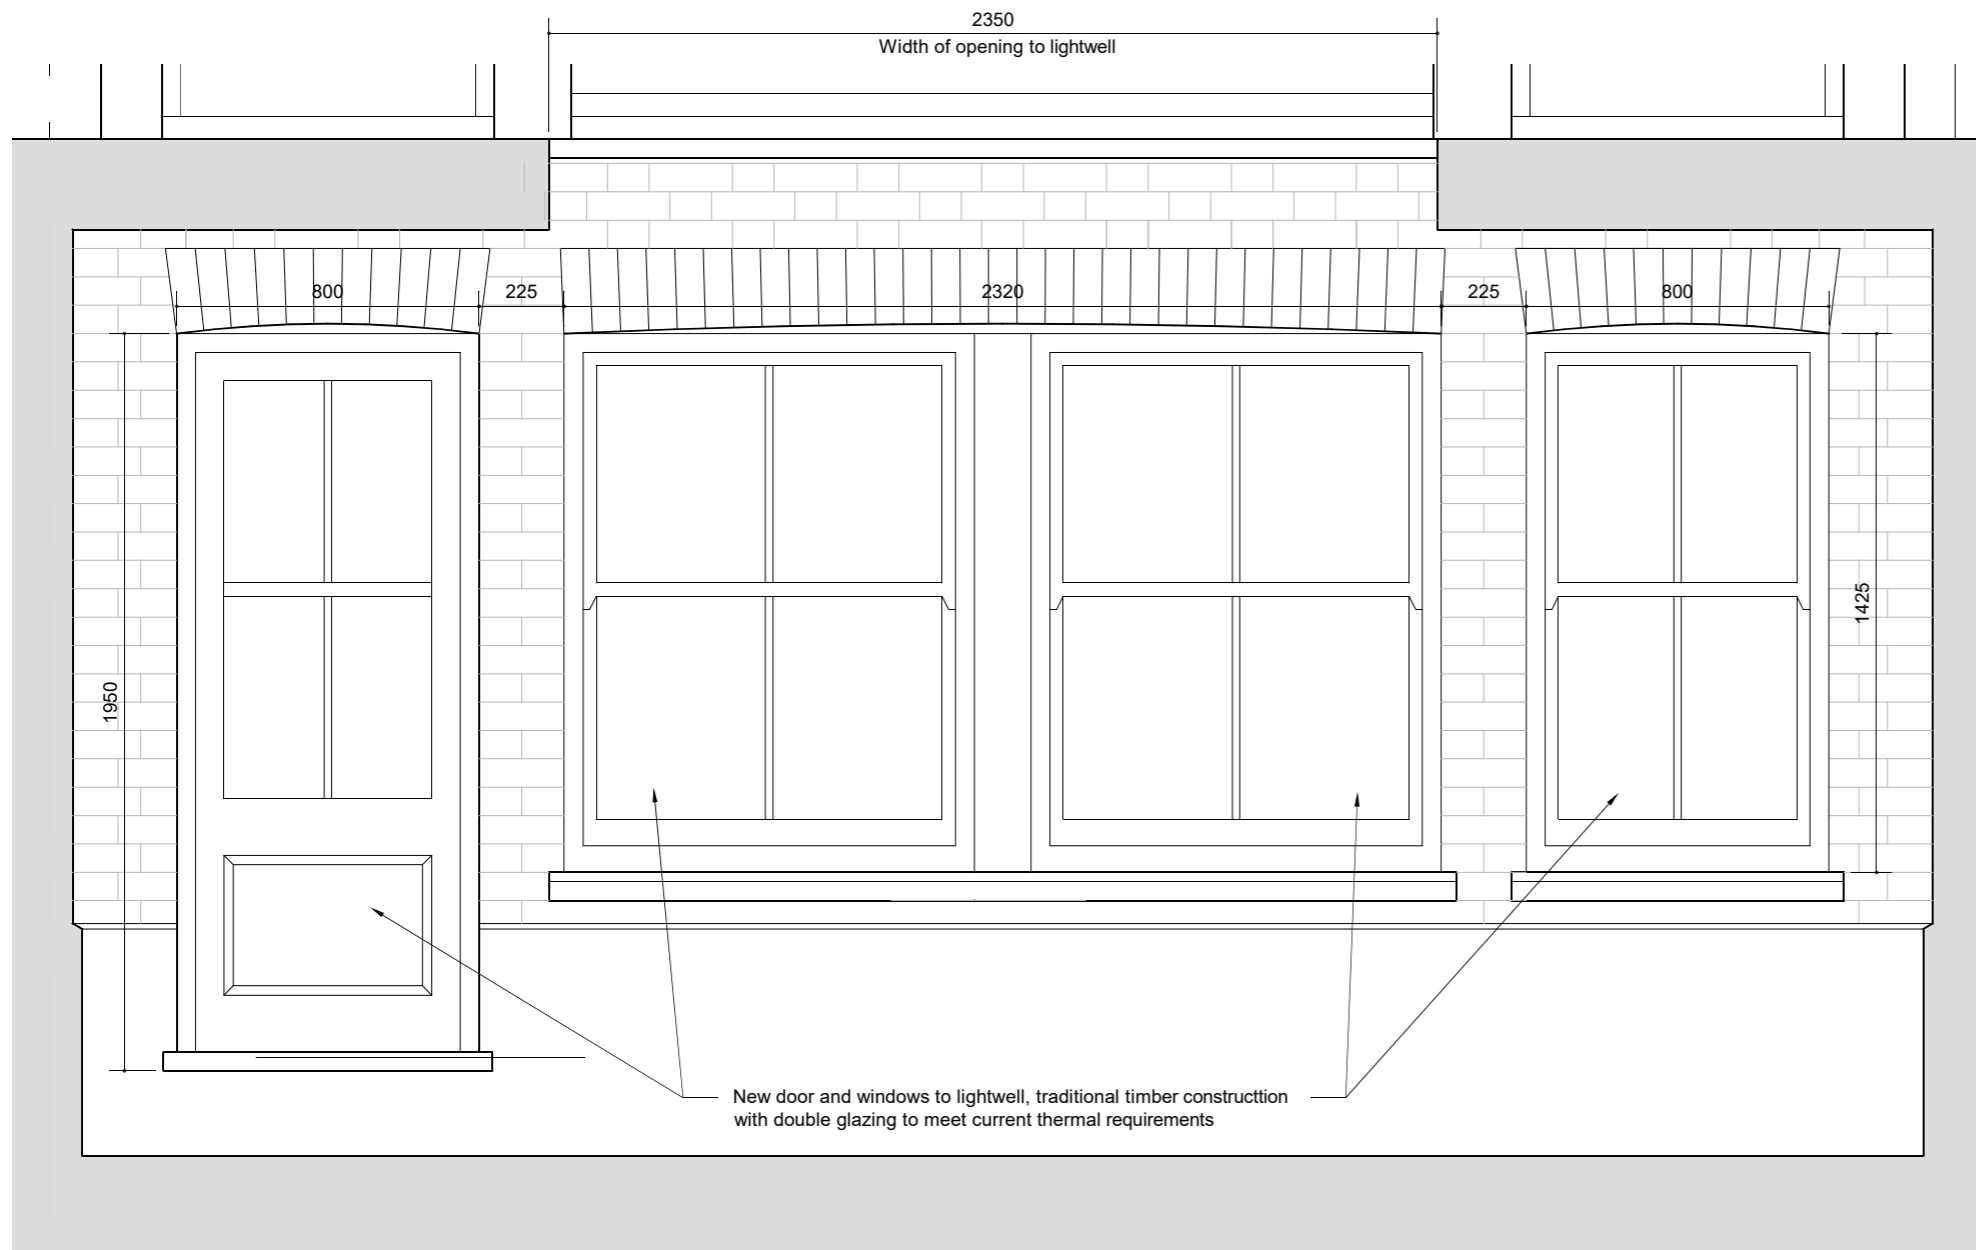
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ORGANISATION via Bell Cornwell	PROJECT LOCATION 11 Murray Sreet, London NW1 9RE

PROJECT TITLE 11 Murray Street: New front basement windows & back GF extension
DRAWING TYPE PLANNING


DRAWING Back roof plan, Sections S1 & S2 & Elevation, as proposed
NOTES CHECK SCALE BAR IF SCALING FROM THIS DRAWING. USE FIGURED DIMENSIONS WHERE POSSIBLE

SCALE 1:100
DATE 09-01-25


REVISION NOTE	DATE	SUFFIX
DRAWING NO. N2411/01/05	REVISION A	



FRONT ELEVATION scale 1:20

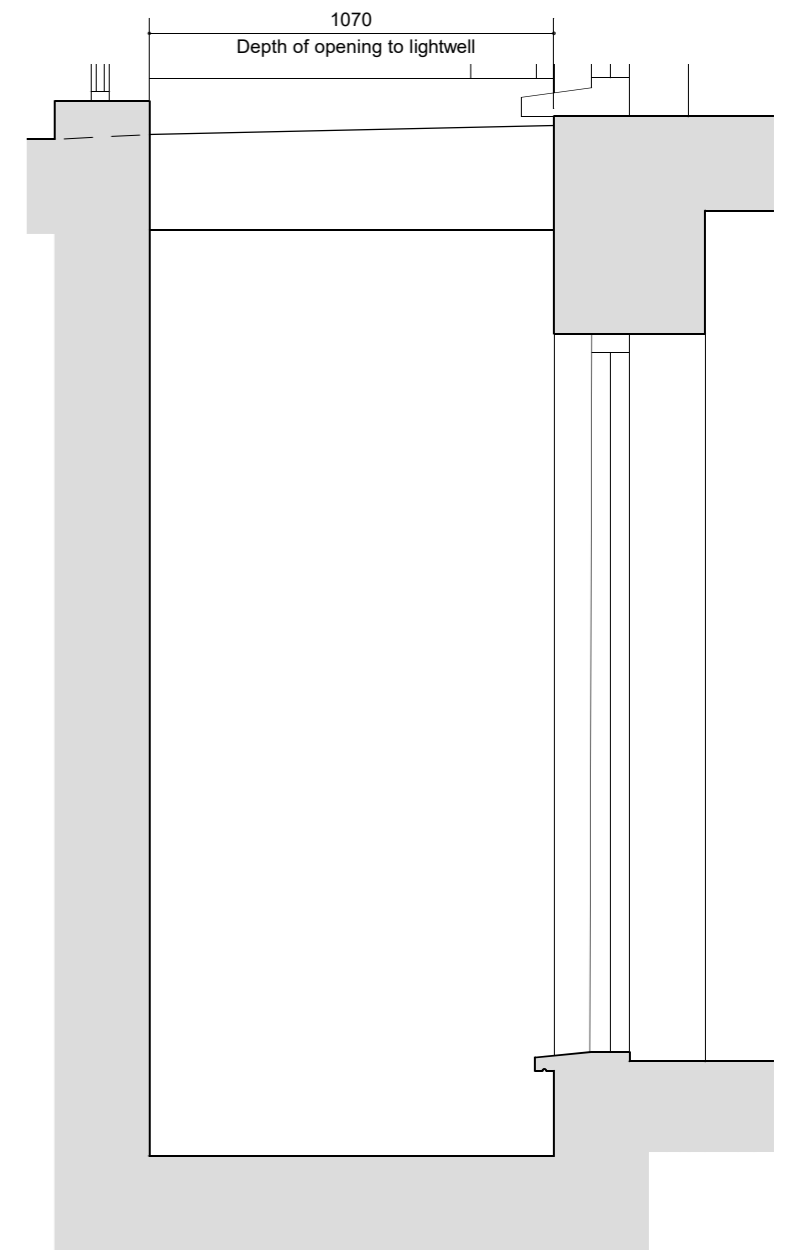

SECTION scale 1:20

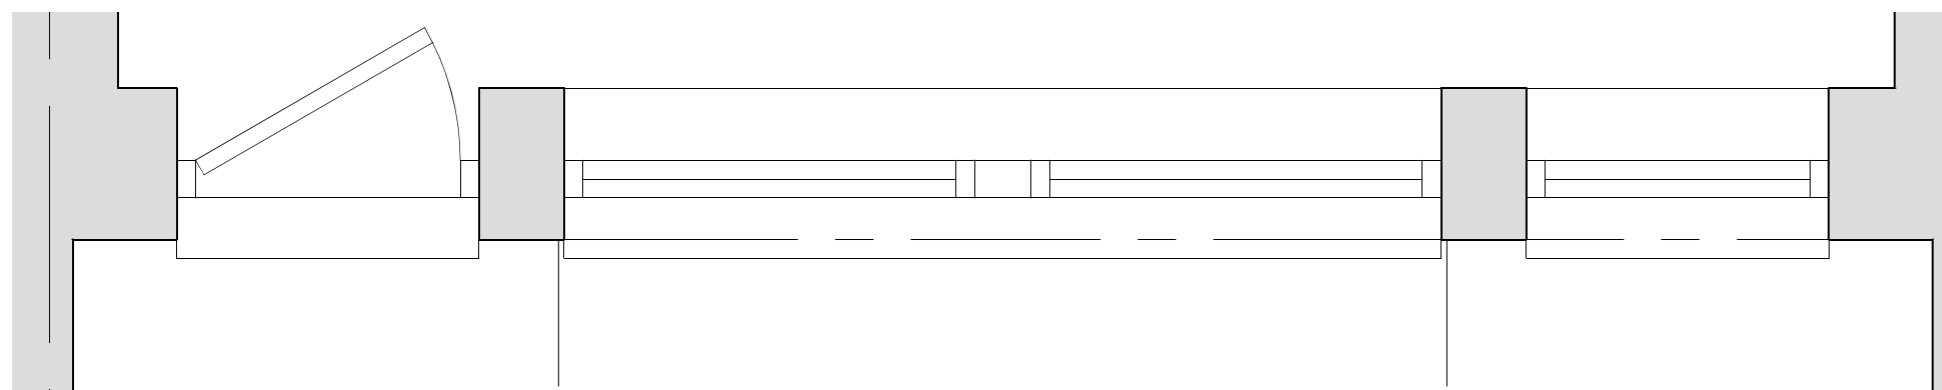

PLAN scale 1:20



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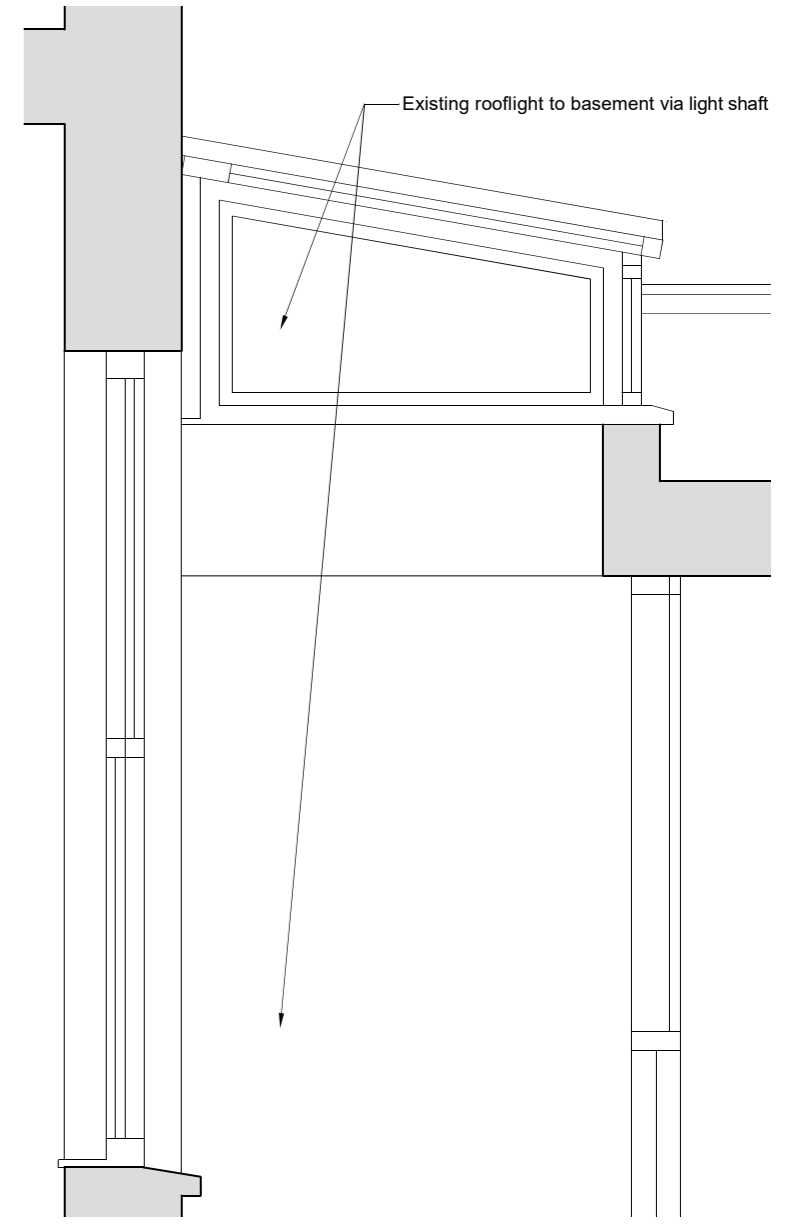
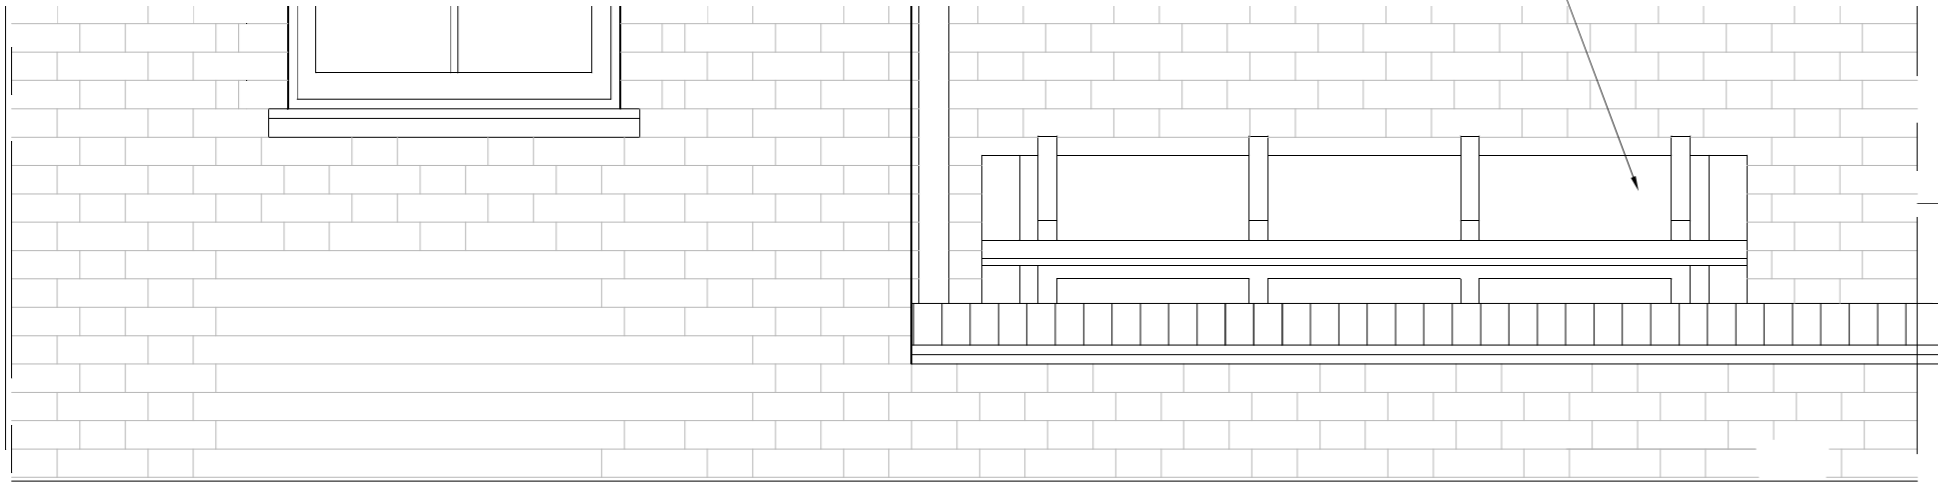
CLIENT Richard Preece Esq.	PROJECT DESCRIPTION Installation of enlarged front basement windows and back GF extension
ORGANISATION via Bell Cornwell	PROJECT LOCATION 11 Murray Sreet, London NW1 9RE

PROJECT TITLE 11 Murray Street: New front basement windows & back GF extension	DRAWING TYPE PLANNING
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DRAWING Detail of front openings to basement as proposed	SCALE 1:20
NOTES CHECK SCALE BAR IF SCALING FROM THIS DRAWING. USE FIGURED DIMENSIONS WHERE POSSIBLE	DATE 22-08-24

REVISION NOTE Drawing renumbered from 05 to 06	DATE 090125	SUFFIX A
DRAWING NO. N2411/01/06	REVISION A	

Existing rooflight to basement via light shaft



Existing rooflight to basement via light shaft


Existing back elevation at ground floor level

BACK ELEVATION

scale 1:20

SECTION


scale 1:20

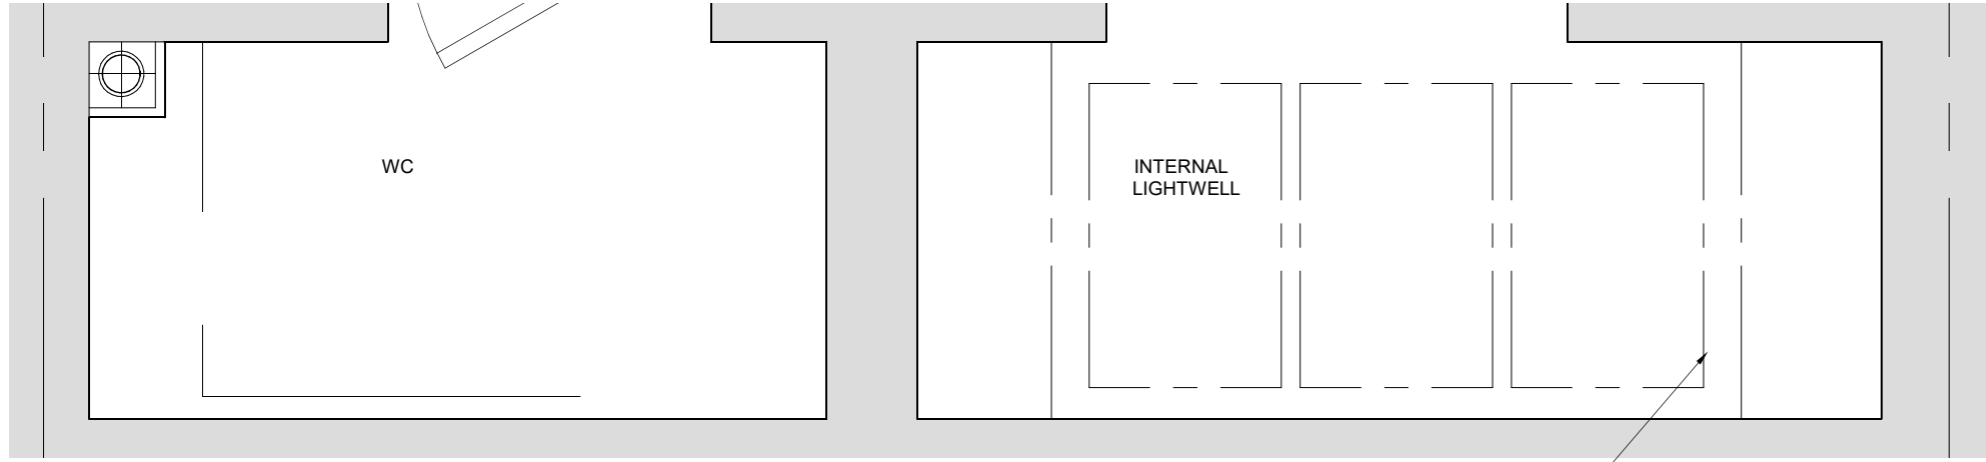

Existing rooflight to basement via light shaft

PLAN

scale 1:20

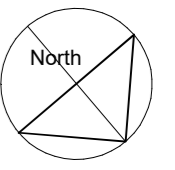

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ORGANISATION via Bell Cornwell	PROJECT LOCATION 11 Murray Sreet, London NW1 9RE

PROJECT TITLE 11 Murray Street: New front basement windows & back GF extension	DRAWING TYPE PLANNING
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DRAWING Detail of back lightwell and rooflight as proposed (remains as existing)	NOTES CHECK SCALE BAR IF SCALING FROM THIS DRAWING. USE FIGURED DIMENSIONS WHERE POSSIBLE
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SCALE 1:20	DATE 22-08-24
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REVISION NOTE Drawing renumbered from 06 to 07	DATE 090125	SUFFIX A
DRAWING NO. N24111/01/07	REVISION A	