

GENERAL NOTES

ALL INTERIOR DIMENSIONS INCLUDING CEILING HEIGHTS ARE TAKEN TO AND FROM FINISHED SURFACES UNLESS OTHERWISE STATED. ALL LEVELS AND DIMENSIONS MUST BE CHECKED ON SITE. ANY DISCREPANCIES WITH THE INFORMATION DEPICTED IN THIS DRAWING MUST BE REPORTED IN WRITING. RESPONSIBILITY CANNOT BE ACCEPTED FOR ALTERATIONS MADE TO THIS DRAWING WITHOUT PRIOR PERMISSION.
THIS DRAWING MUST NOT BE PHOTOCOPIED, SCALED OR REPRODUCED OTHERWISE. SCALE ACCURACY CANNOT BE GUARANTEED. THIS DRAWING SHOULD NOT BE USED IN ANY CIRCUMSTANCES FOR ANY STRUCTURAL CALCULATION OR BUILDING CONSTRUCTION / DEMOLITION WORK.

SURVEY GRID

PLEASE NOTE THAT GRID SHOWN ON THIS DRAWING IS AS FOLLOWS

- ARBITRARY
- ARBITRARY BUT APPROXIMATELY RELATED TO GRID NORTH
- BEST FIT TO ORDNANCE SURVEY DIGITAL DATA
- ORDNANCE SURVEY NATIONAL GRID USING GPS

LEVELS AND HEIGHTS

- AS ARCH SPRINGER HEIGHT
- AH ARCH HEAD HEIGHT
- B BEAM SOFFIT HEIGHT
- C CEILING SOFFIT HEIGHT
- D DOOR HEAD HEIGHT
- FL FLOOR LEVEL
- P PLINTH HEIGHT
- S SOFFIT HEIGHT
- T TRUNKING HEIGHT
- WS WINDOW SILL HEIGHT
- WH WINDOW HEAD HEIGHT

PLEASE NOTE: ALL HEIGHTS TAKEN FROM FLOORLANDING UNLESS OTHERWISE STATED.

DATUM: ARBITRARY

DESCRIPTION: N/A



N/A

	SURVEY STATION		BENCH MARK
	LEVEL POSITION		FULL WATER
	TELEDON OVERHEAD		SURFACE WATER
	POWER OVERHEAD		COMBINED WATER
	GAS		
	UNKNOWN SERVICES		
	CHANGE OF SURFACE		WALL BUILDING FACE
	DROP KERB		OVERHEAD FEATURE
	FENCE		TREE
	KERB		DOUBLE GATE
	VEGETATION		STEP UP
	TREE CANOPY		ANGLED FACE
	BRIDGE GATE		SLOPING MASONRY
	SLOPE		ELEVATION MARKER
	ARCHITECT CEILING		ELECTRICAL SOCKET
	FLOORING DIRECTION		ELECTRICAL SWITCH
	SLOPING CEILING		WALL MOUNTED LIGHT
	SECTION MARKER		SMOKE DETECTOR
	ELECTRICAL SOCKET		
	LIGHT		
	EMERGENCY LIGHTING		
	RADIATOR		


ABBREVIATIONS (Where Applicable)

AB AIR BRICK	OH OVERHEAD
ACU AIR CONDITIONING UNIT	PLT PAVEMENT LIGHT
BOL BOLLARD	R RADIATOR
BRW BRICK WALL	RG ROAD GULLY
BT BRITISH TELECOM	RH RADIATOR HOUSING
CATV CABLE TELEVISION COVER	RNB ROAD NAME BOARD
CE CLEANING EYE	RS ROAD SIGN
CL COVER LEVEL	RW RETAINING WALL
CPIS CONC. PAVING SLABS	RWP RAINWATER PIPE
DP DOWN PIPE	SC STOP COCK
ECP ELECTRIC CABLE PIT	SG SECONDARY GLAZING
EP ELECTRICITY POLE	SV STOP VALVE
FH FIRE HYDRANT	T TRUNKING
G GULLY	TIC TELECOM INSPECTION COVER
GSC GAS STOP COCK	TDO TRAP DOOR OVER
GV GAS VALVE	TLT TRAFFIC LIGHT
HWC HOT WATER CYLINDER	TP TELEGRAPH POLE
HTR HEATED TOWEL RAIL	TPS TACTILE PAVING SLABS
IC INSPECTION COVER	UTL UNABLE TO LIFT
LP LAMP POST	V VENT
MH MANHOLE	VP VENT PIPE
MKR MARKER	W WINDOW
NB NOTICE BOARD	WM WATER METER
NFI NO FURTHER INFORMATION	WP WASTE PIPE

LOCATION PLAN

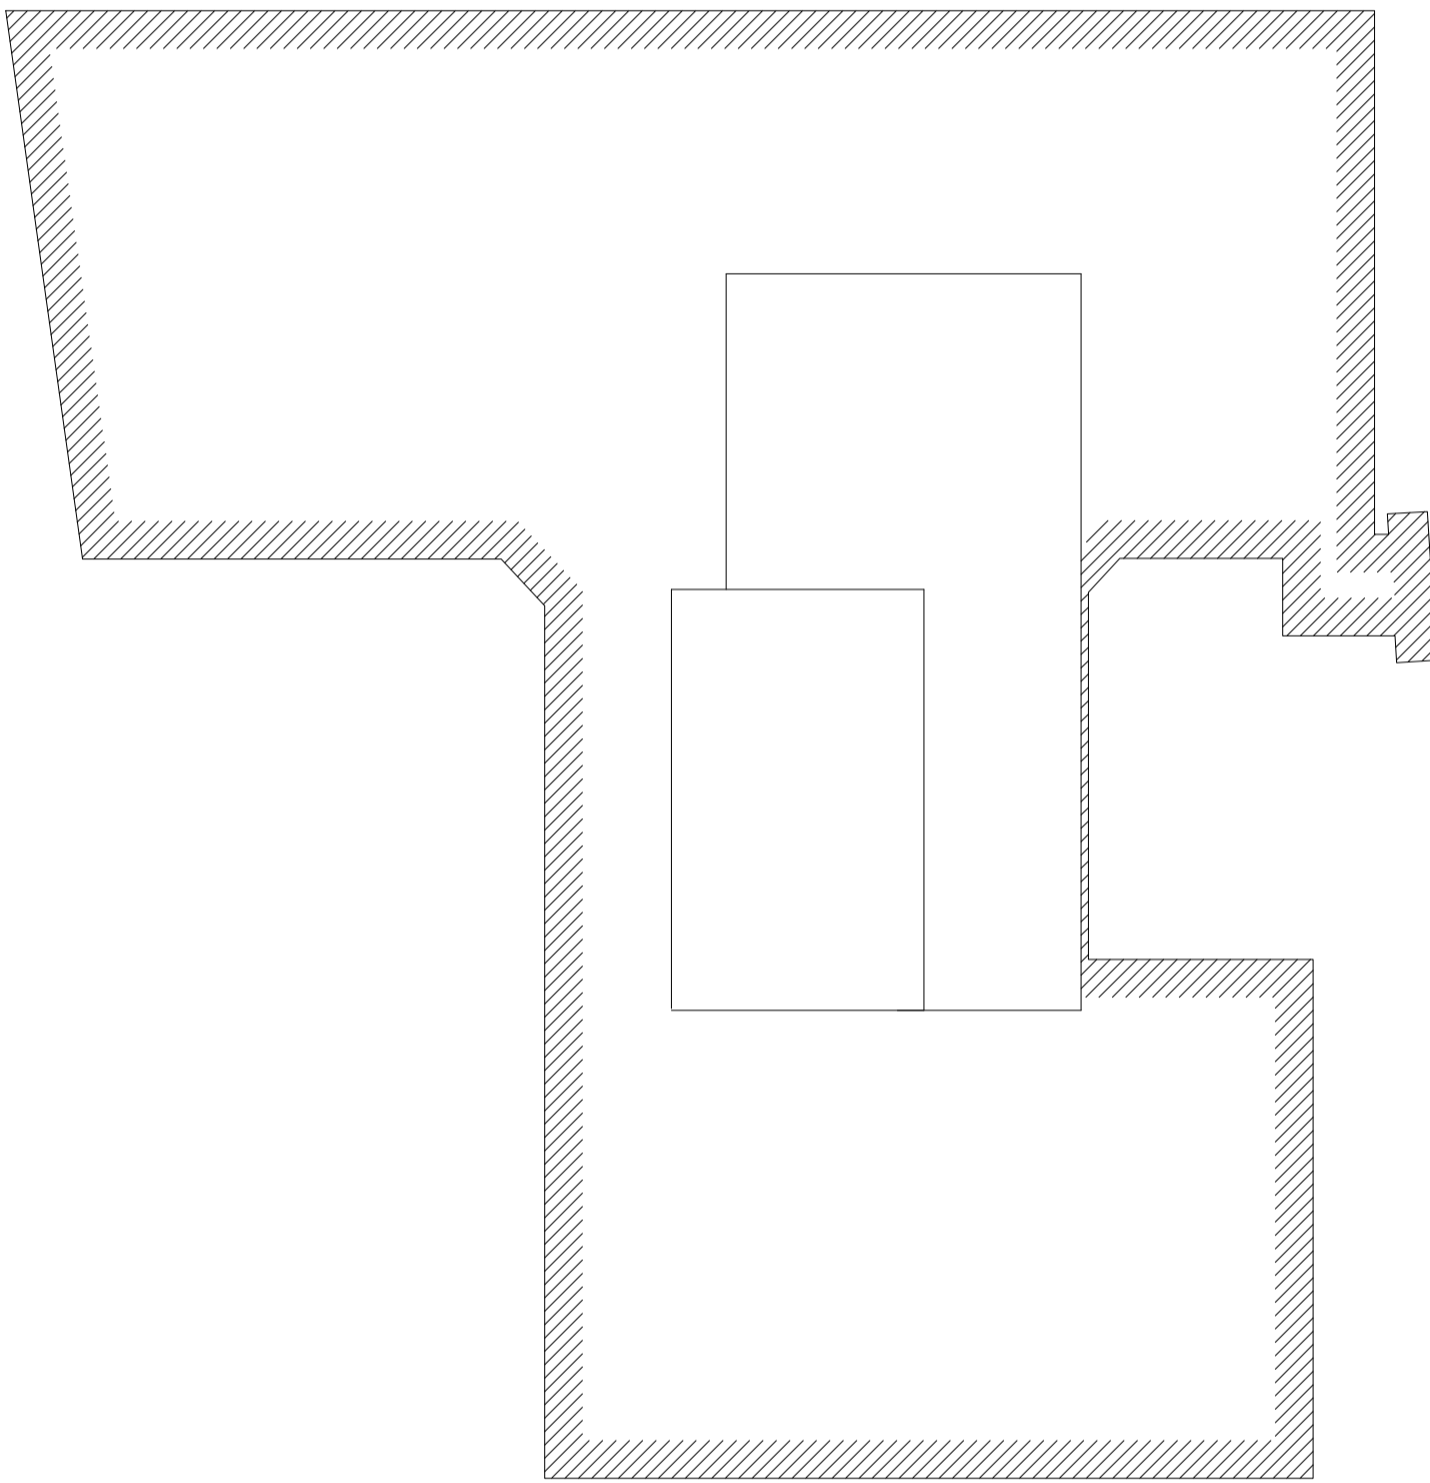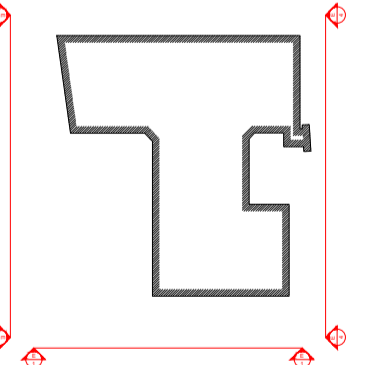

EXISTING ROOF PLAN

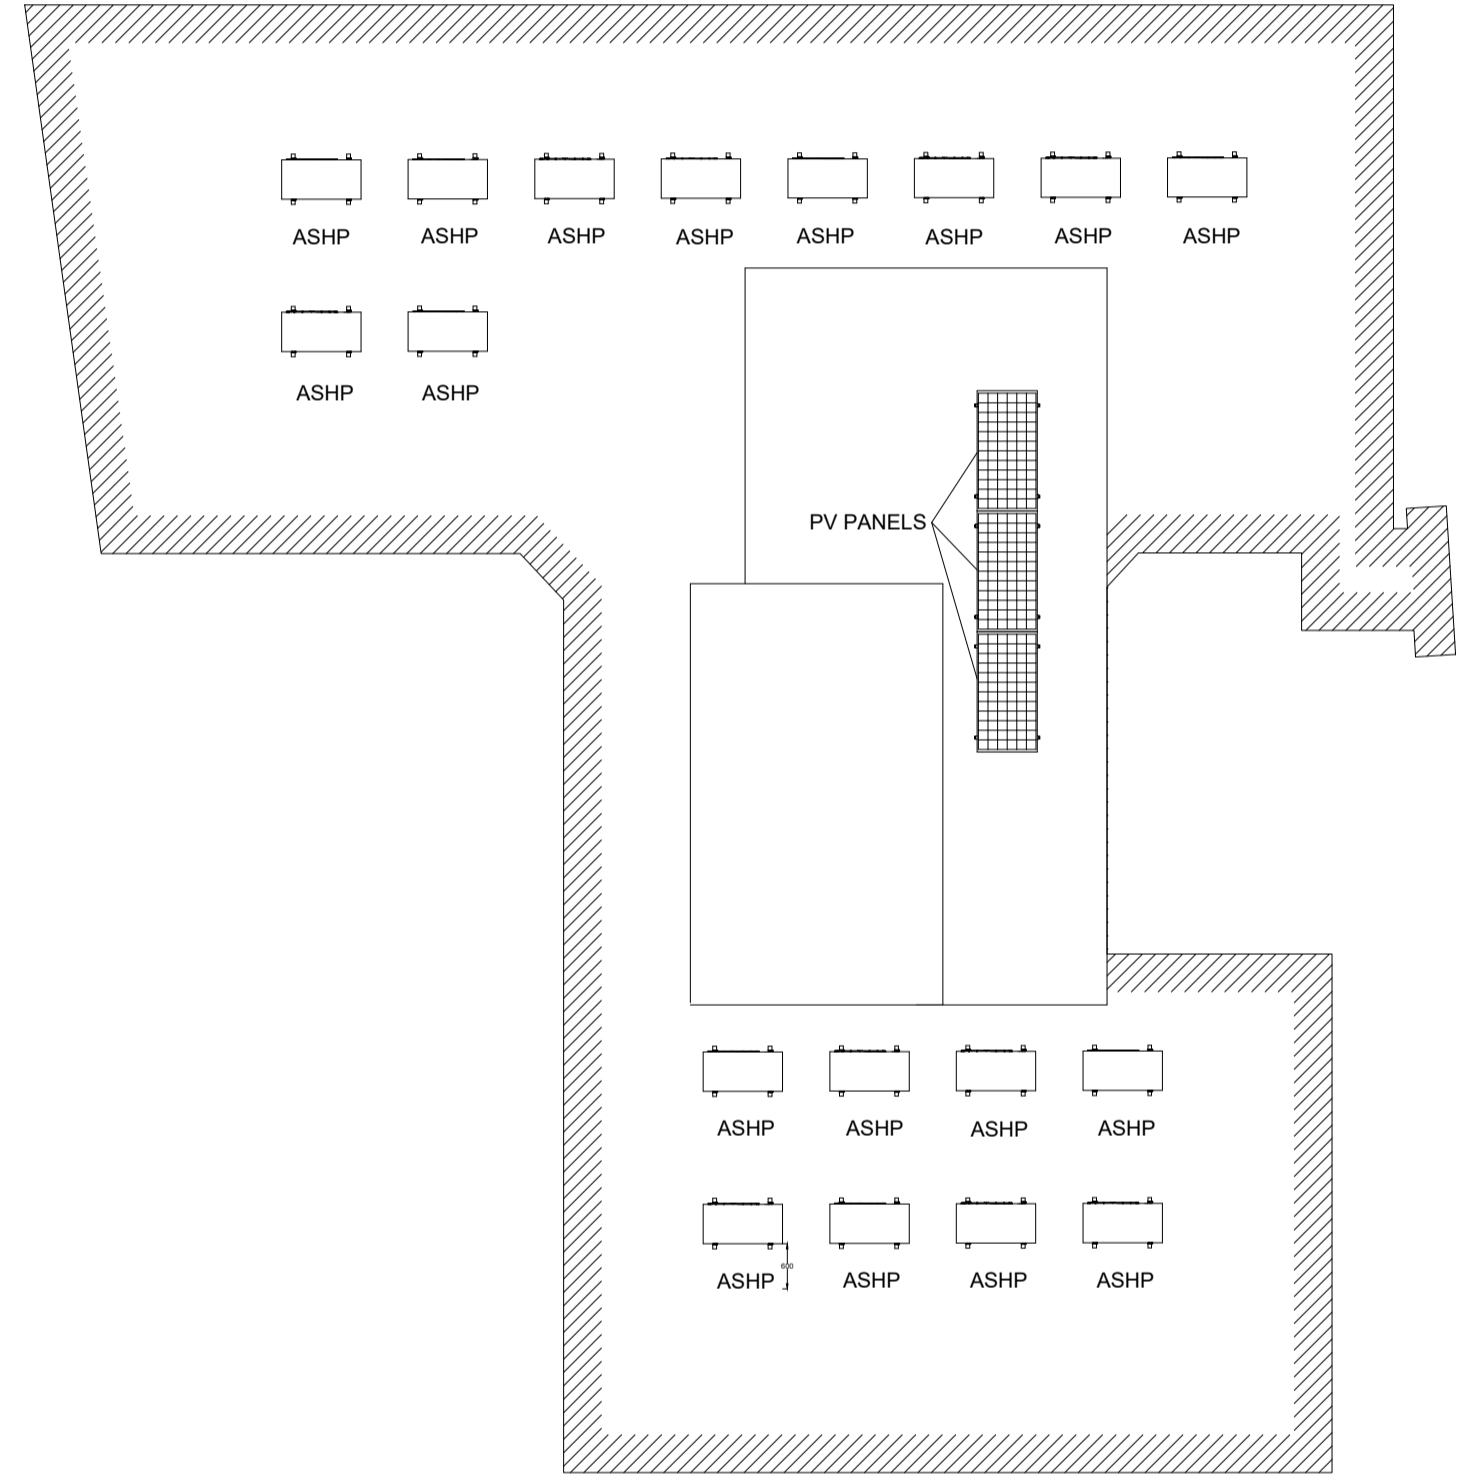


PROPOSED ROOF PLAN

PROJECT TITLE

**CHESTER COURT
LISSENDEN GARDENS
LONDON, NW5 1LY**

DRAWING TITLE

PROPOSED ELEVATIONS

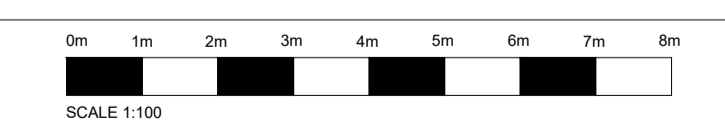

SCALE 1:100	SIZE A1	DRAWING 79819
DRAWN DO	CHECKED HR	DATE OCT 2024