


LOCATION PLAN  
 Scale 1:1250

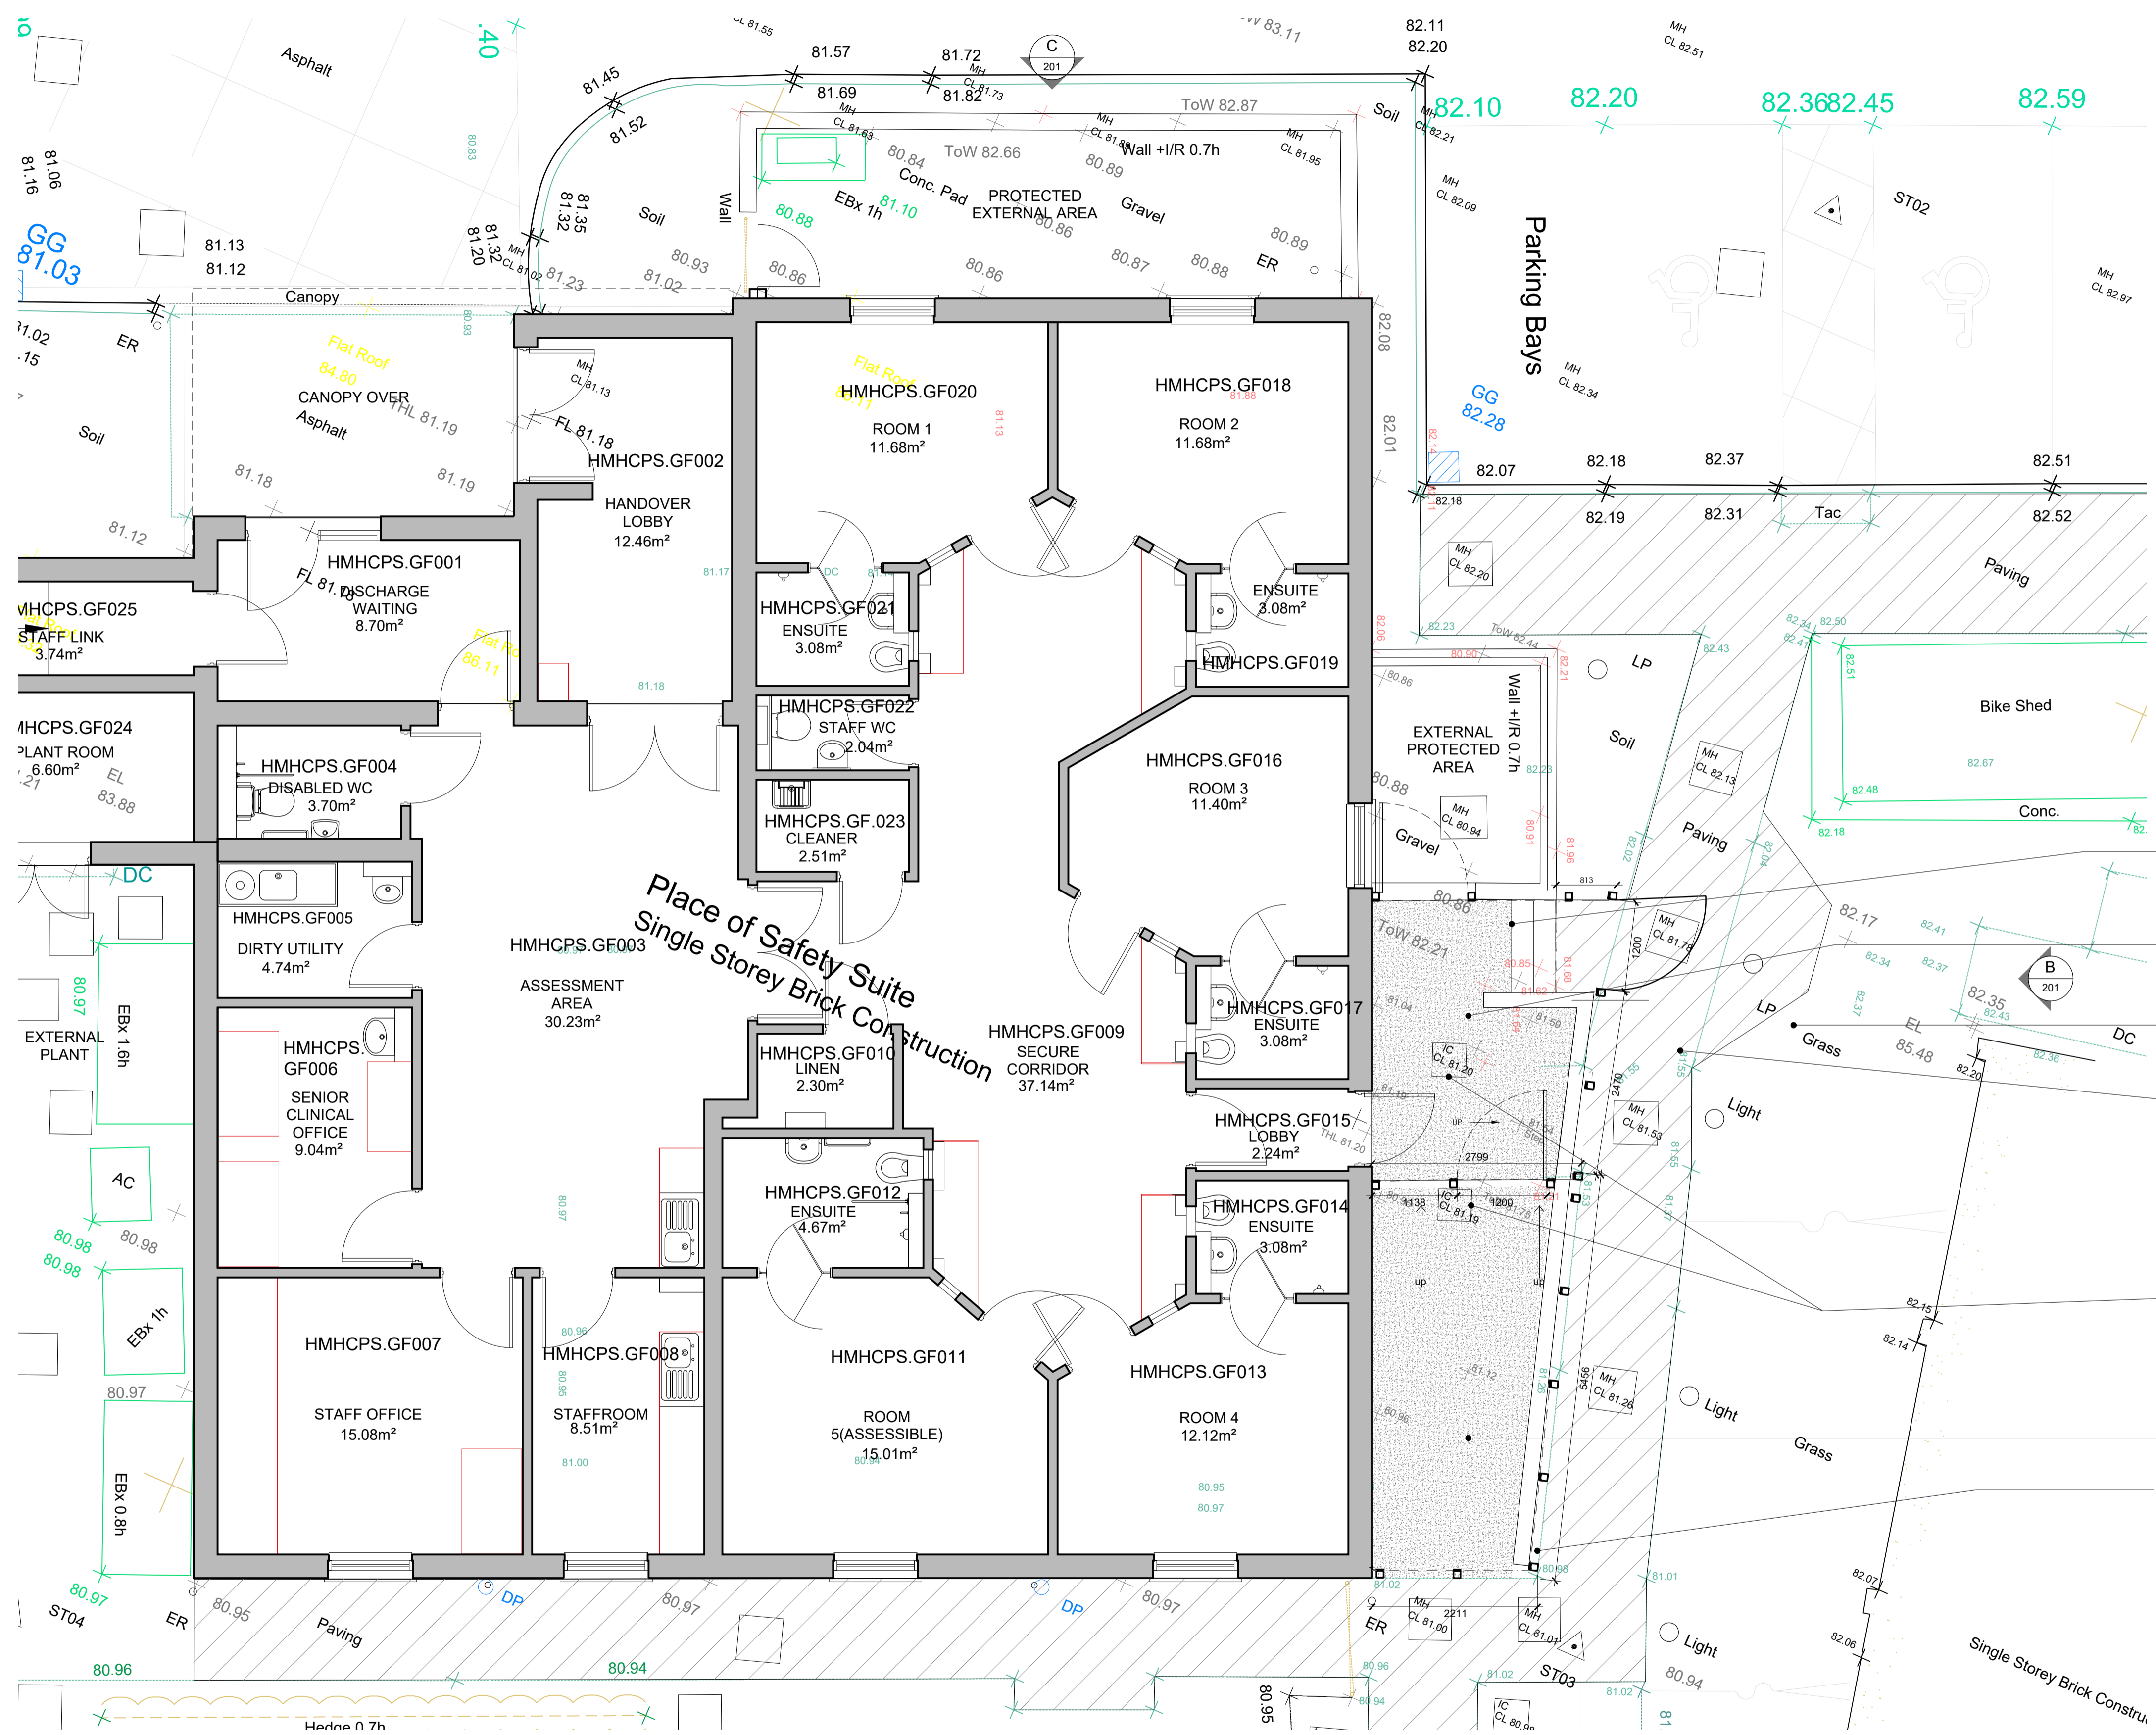

PROPOSED GROUND FLOOR PLAN  
 Scale 1:50

- New step down into External Protected Area. Flight to be constructed using flag and bricks. Step nosings, use a material that will contrast visually, a minimum of 50mm wide, on both the read and riser, on concrete sub base, on sand blinding.
- Proposed area of new finishes to existing garden space. Rubber crumb finish at a depth of 20mm on 30mm rubber base course installed to manufacturer's instructions, on MOT Type 1 150mm thick.
- Extended Pathway due to door issue.
- New 1.2m wide x 2.1m high galv' steel gate to be manufactured from galv' 100x100x6mm R.H.S with galv' steel mesh cover bolted on as described elsewhere for fencing. Allow to weld on steel plate for proposed lock set and 1No 300mm steel 'D' handle to external face and include 1No 32mm diam 600mm long lockable galv' steel barrel bolt. 3m high cloaking mild steel plate fixed at the centre of the steel mesh 358 fencing. Brick Retaining wall demolished to form new gate opening. Make good to brick wall. Garden area to be graded up to new level access, mot type 1 fill and sub base to suite resin bonded surface.
- Change type of chamber cover to insert to receive rubber crumb.
- Proposed area of new finishes to existing garden space. Rubber crumb finish at a depth of 20mm on 30mm rubber base course installed to manufacturer's instructions, on MOT Type 1 150mm thick. Single skin powder coated 358 welded mesh security fence fixed to post through clamp bar with M10 bolts at max 150mm c/c. Colour Green RAL 6005. Base of mesh to be cast 150mm into ground beam. With Cloaking sheets on both sides, 2mm EN AW-3005A grade aluminium sheet, polyester coated Tectura architectural finish, Image printing (if applicable) TBC. Powder coated steel posts by fencing contractor. Size TBC. Colour Green RAL 6005.

All information on the drawing is indicative and is subject to a topographical and measured survey, once complete the drawing will be updated

**PLANNING**

PL1	27.11.24	Planning Issue	TJM	TC
REV	DATE	DESCRIPTION	BY	APPD

CLIENT

PROJECT  
 S136 Place of safety unit  
 Highgate Acute Mental Health Centre  
 Dartmouth Park Hill  
 London N19 5JG

DRAWING TITLE  
 Garden security fencing Feasibility

Proposed Plans-Option 2

DATE	04.10.24	DWG. No.	5334-102	REV.	PL1
SCALE	1:50 (A1)	DRAWN BY:	DLM	DATED	-
CHECKED BY:	-	DATED	-		

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