Liquidambar styraciflua 'Worplesdon'

Cortaderia selloana 'Aureolineata'

Deschampsia cespitosa 'Bronzeschleier'

Name

Grasses

Carex testacea

Stipa tenuifolia

Asarum europaeum

Dicksonia antartica

Ornamentals

Dryopteris felix-mas

Dryopteris wallichiana

Polystichum setiferum

Carex morrowii 'Ice Dance'

Hedera helix 'Hibernica'

Milium effusum 'Aureum'

Green/Biodiverse Roof

The Bauda Flora 3 Seed Mix

Helleborus × hybridus

Liriope muscari

Luzula sylvatica

Viburnum tinus

Vinca minor alba

Geranium macrorrhizum 'Spessart'

Erythronium californicum 'White Beauty' | Fawn lily

Miscanthus sinensis 'Kleine Silberspinne' Little Silver Spider

Asplenium scolopendrium

Prunus Lusitanica

Prunus serrula 'Tibetica'

Size

1m

2-3L

9cm

9cm

9cm

9cm

9cm

(see drawing)

15cm girth/300cm

6/8cm girth

100cm high

Common Name

Portugese Laurel

Tibetan Cherry [MS]

New Zealand sedge

Mexican feathergrass

European wild ginger

Hart's-tongue Fern

Tree fern

Male fern

Wood fern

Cranesbill

Atlantic ivy

Lenten rose

Laurustinus

lesser periwinkle

Greater wood-rush

Bowles' golden grass

Lilyturf

Soft shield fern

Tufted hair grass 'Bronze veil' | 5L

Japanese sedge 'Ice Dance' 3L

Pampas grass

Sweet Gum 'Worplesdon'

Notes

120cm stem

3 stems minimum

Condition

RB, Bushy

clear stem minimum 200cm RB, Bushy

Quantity

275

275

520

1130

2765

200

250

250

450

595

350

850

200

485

485

1075

90

1065


55

PLANTER DETAILS

Planter Q

7828

DETAILED PLANTER SECTION 1.20@A1

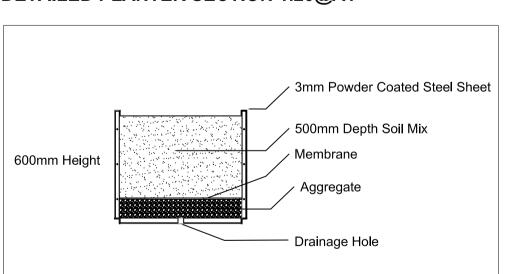

PLANTER SCHEDULE

Planter Ref.	Material	Colour [RAL]	Size (mm)	Notes	Quantity
Α	Powder Coated Steel Planter	7024	1900 (L) x 500 (W) x 600 (H)	Lower GF	8
С	Powder Coated Steel Planter	7024	1875 (L) x 835 (W) x 600 (H)	Upper GF	2
D	Powder Coated Steel Planter	7024	10400 (L) x 800 (W) x 600 (H)	Upper GF	1
E	Powder Coated Steel Planter	7024	See Drawing	Upper GF / Shape as per drawing	1
F	Powder Coated Steel Planter	7024	Total Length - 20662	Level 2 / 4 Angles	1
G	Powder Coated Steel Planter	7024	Total Length - 9709.3	Level 4/2 Angles	1
Н	Powder Coated Steel Planter	7024	Total Length - 6666.3	Level 4 / 2 Angles	1
I	Powder Coated Steel Planter	7024	8850 (L) x 700 (W) x 600 (H)	Level 5	1
J	Powder Coated Steel Planter	7024	7650 (L) x 710 (W) x 600 (H)	Level 5	2
K	Powder Coated Steel Planter	7024	7445 (L) x 700 (W) x 600 (H)	Level 5	1
L	Powder Coated Steel Planter	7024	3750 (L) x 3665 x 500 (W) x 515.21 x 600 (H)	Level 5	1
М	Powder Coated Steel Planter	7024	4110 (L) x 4020 x 500 (W) x 516.6 x 600 (H)	Level 5	1
N	Powder Coated Steel Planter	7024	3100 (L) x 3300 x 500 (W) x 519.7 x 600 (H)	Level 5	1
0	Powder Coated Steel Planter	7024	Total Length - 29614 mm x 600 (H)	Level 6 / 4 Angles	1
Р	Powder Coated Steel Planter	7024	1500 (L) x 700 (W) x 600(H)	Level 6	1
Q	Powder Coated Steel Planter	7024	Total Length - 12 755mm x 600 (H)	Level 6	1

GENERAL LANDSCAPING SPECIFICATION NOTES:-

Any existing trees to be retained and protected throughout construction period in accordance with BS 5837 2012 - Trees in Relation to Design, Demolition and Construction.

SPECIFICATION:-

MATERIALS AND WORKMANSHIP

- Materials and workmanship shall generally be in accordance with the following documents - BS3936 Nursery Stock and BS4428. Recommendations for General Landscape Operations.
- Plant material to be the sizes and dimensions as stated in the schedule and shall be healthy with good fibrous root systems.

TREES

- All trees to be back filled with top soil and suitable organic material (to be specified).
- All trees should be staked or double staked using pointed softwood / peeled chestnut / larch or oak stakes, free from projections and large or edge knots and tied above ground.
- SHRUBS/TREES GENERAL
- Condition: Materially undamaged, sturdy, healthy and vigorous.
- Appearance: Of good shape and without elongated shoots.
- Hardiness: Grown in a suitable environment and hardened off. Health: Free from pests, diseases, discolouration, weeds and
- physiological disorders.
- Budded or grafted plants: Bottom worked.
- Root System and Condition: Balanced with branch system.
- Standard: The relevant parts of BS 3936. Species: True to Name.
- Origin/Provenance: British provenance as per the National Plant
- Names, Forms, Dimensions, Provenance and other Criteria: To BS 3936-1 Trees and Shrubs.
- All shrubs and trees to receive a 50mm layer of bark mulch.

WATERING

- All trees/shrubs will be watered after planting and to be watered as necessary to ensure survival.
- Any trees, shrubs, seeding works which fail within the first 5 years to be replaced inline with the species, seeding mixes and

sizes as detailed on this plan.

STATUS

© This drawing and the building works depicted are the copyright of RBMP Ltd and may not be reproduced except with

written consent. Figured dimensions only are to be taken from this drawing. All contractors must visit the site and be responsible for taking and checking all dimensions relative to their work. Influence are to be advised of any variation

Suface Material

Planting (within

1. 500mm depth imported topsoil mix, using

2. Irrigation instructions to be provided with

slow release fertiliser mixed in.

occupiers management pack.

class 5B/2 multi-purpose loam/sandy loam

topsoil. Ameliorants, water polymer gel and

container)

To Architect's Specification

Do not scale off drawings. All dimensions to be checked on site.

KEY

NOTES

www.rbmp.co.uk studio@rbmp.co.uk / 0161 706 0158

PROJECT **Haverstock Hill**

OD Camden Hotel Ltd


Landscape Plan 6th Floor Plan


SCALE 1:100 DATE 30.03.23 DRAWN AM CHECKED RB


HHCAM-RBMP-00-06-DR-L-01

REV NO: ORIGINAL SIZE 2227

© copyright

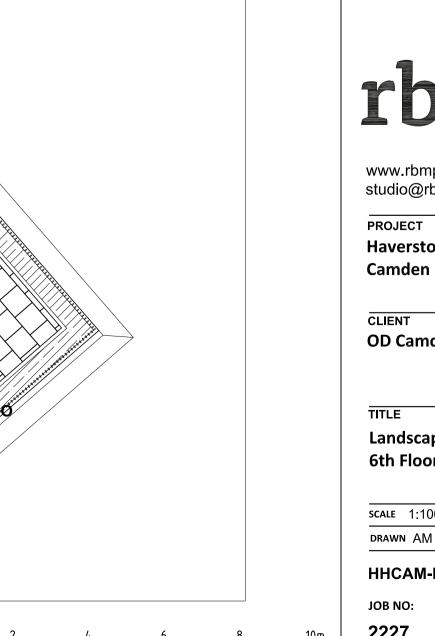

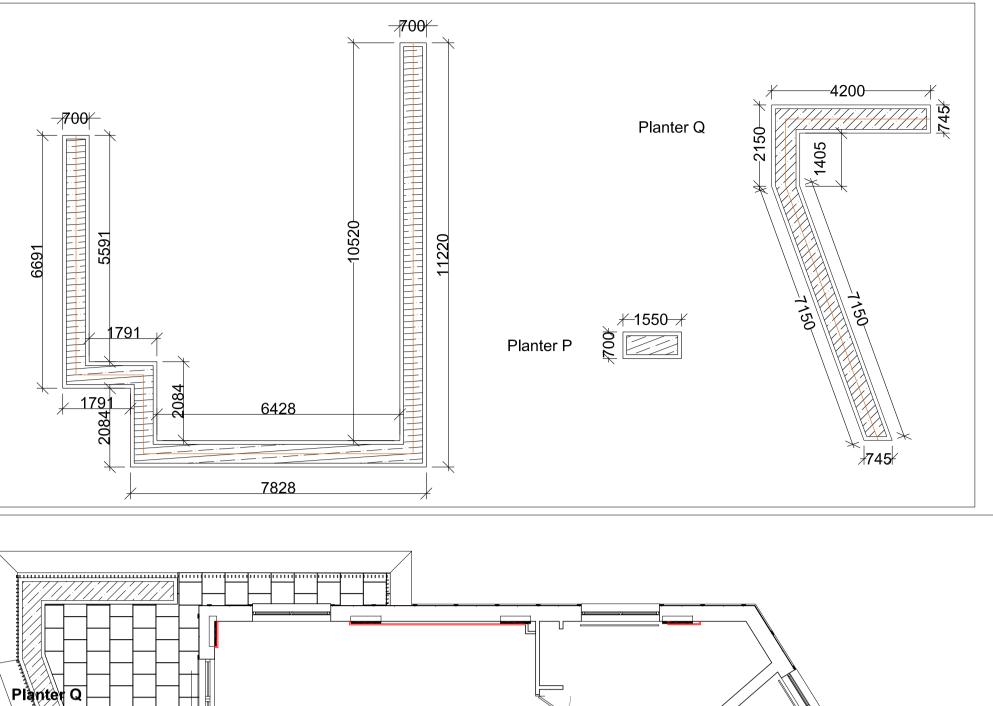

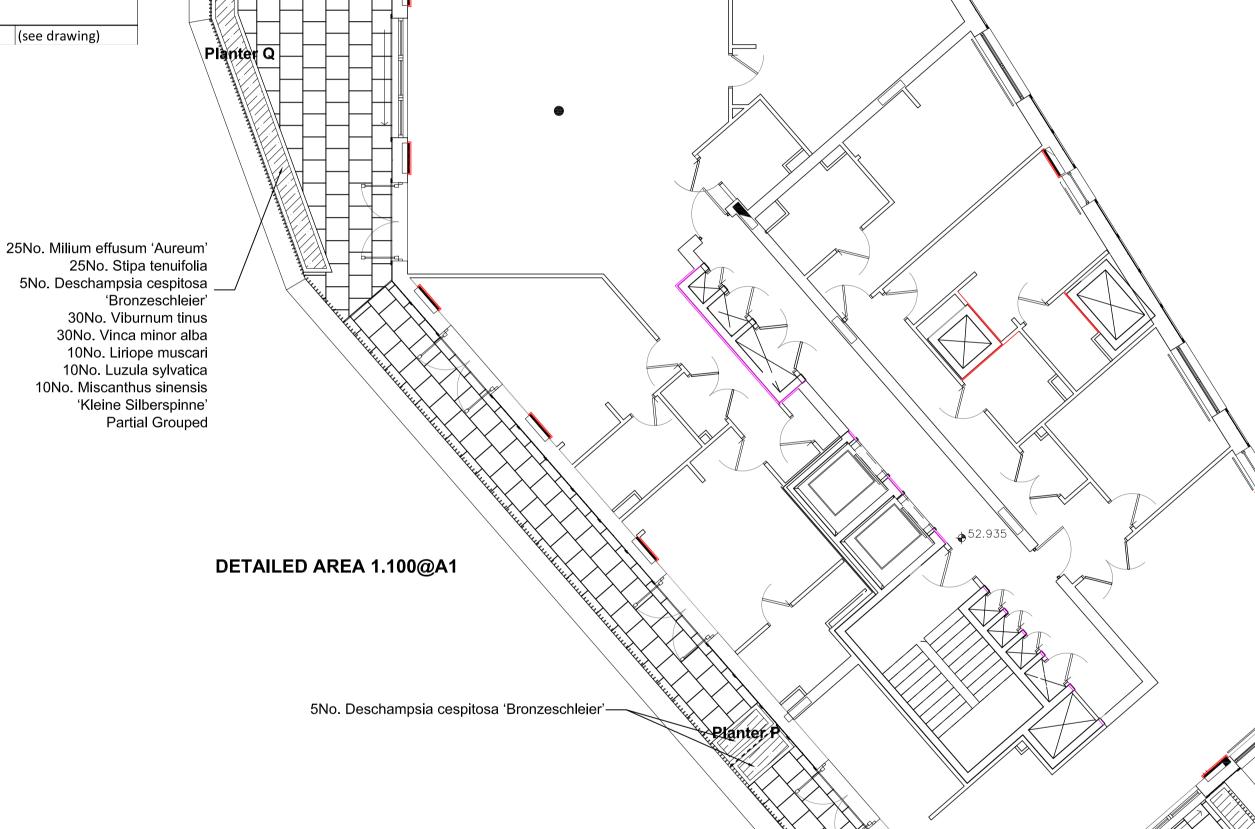

50No. Milium effusum 'Aureum' 50No. Stipa tenuifolia 20No. Deschampsia cespitosa 'Bronzeschleier' 60No. Viburnum tinus 60No. Vinca minor alba 25No. Liriope muscari 25No. Luzula sylvatica

25No. Miscanthus sinensis 'Kleine Silberspinne' Partial Grouped

1:100