

Photo 001





Photo 03

Existing Curved Windows Note:

Existing windows incorporating non-original and unsympathetic later added/replaced glass panes – replacement glass panes vary and are mis-matched (a mixture of stained, frosted, patterned, and clear). Please refer to photographs provided and which show historic curved glass panes replaced in some locations with straight panes within curved frames using putty. This straight panes and installation method has caused cracking and other deterioration overtime. Interim remedial work appears to have been undertaken by way of "sticky tape" to hold glass panes in place.

General notes:

This is a 'planning' level of detail drawing. It must not be used for any other purpose and is subject to further detailed design. All dimensions subject to confirmation/checks on site.

Legend:



Structure retained Structure removed New structure Line of indicative structure above Outline of surface above Area restricted to max 1.8m ceiling

EXISTING GROUND FLOOR PLAN

SCALE: 1:50@A3 0.0 0.5

0.5	1.0	1.5	2.0	3.0	4.0	5.0

Top Floor Flat

NW3 4HU

27 Belsize Square, London

Α	28.10.2024	Windows note added
REV	DATE	NOTE

GENERAL NOTES
This drawing has been prepared from survey information
prepared by others and is for information purposes only.
Do not scale from drawing, use figured dimension only.
All dimensions must be checked on site prior to commencement
of work. Report any discrepancies to the architect.
This drawings is to be read in conjunction with all other issued
information, including architects and structural engineer's
drawings and specifications. Copyright of Allen Architects Ltd.

DRAWING ISSUE PLANNING	DRAWING TITLE Existing Ground Floor Plan		
CLIENT	-		
Mrs J Aldridge	SCALE		
_	1.50@A3		

SCALE	DRAWN
1:50@A3	Surveyor
DATE	CHECKED
29.07.2024	-
DWG NO.	REVISION
064 010	Α



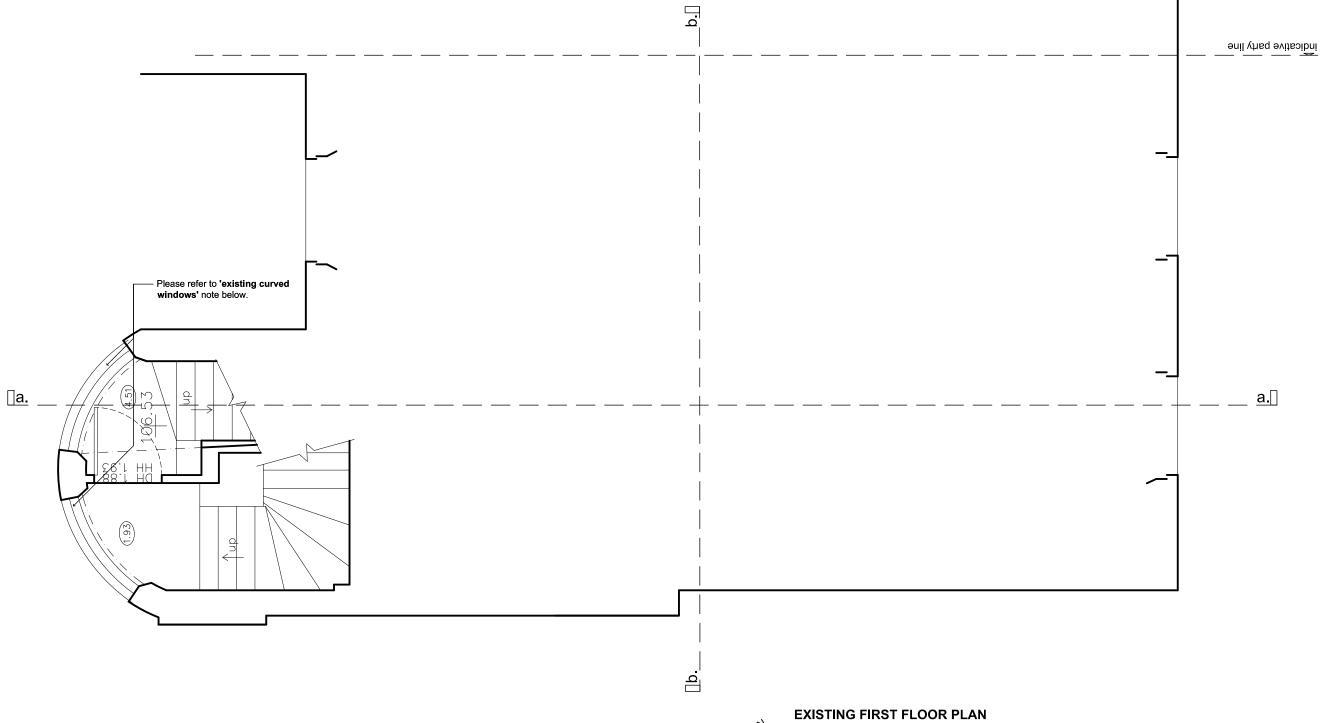


Photo 001





Photo 03

Photo 03



Existing Curved Windows Note:

Existing windows incorporating non-original and unsympathetic later added/replaced glass panes – replacement glass panes vary and are mis-matched (a mixture of stained, frosted, patterned, and clear). Please refer to photographs provided and which show historic curved glass panes replaced in some locations with straight panes within curved frames using putty. This straight panes and installation method has caused cracking and other deterioration overtime. Interim remedial work appears to have been undertaken by way of "sticky tape" to hold glass panes in place.

General notes:

This is a 'planning' level of detail drawing. It must not be used for any other purpose and is subject to further detailed design. All dimensions subject to confirmation/checks on site.

Legend:



Structure retained Structure removed New structure
Line of indicative structure above Outline of surface above Area restricted to max 1.8m ceiling SCALE: 1.50@43

SCAL	_= 10	U@A3)							
0.0	0.5	1.0	1.5	2.0	3.0	4.0	5.0	А	28.10.2024	w
					·	·		REV	DATE	N O

GENERAL NOTES
This drawing has been prepared from survey information prepared by others and is for information purposes only.)
Do not scale from drawing, use figured dimension only. All dimensions must be checked on site prior to commencement of work, Report any discrepancies to the architect. This drawings is to be read in conjunction with all other issued information, including architects and structural engineer's drawings and specifications. Copyright of Allen Architects Ltd.

DRAWING ISSUE	
PLANNING	
CLIENT	
Mrs J Aldridge	
=	
PROJECT TITLE	
Top Floor Flat	

27 Belsize Square, London

NW3 4HU

Existing First Floor Plan					
-					
SCALE	DRAWN				
1:50@A3	Surveyor				
DATE	CHECKED				
29.07.2024	-				
DWG NO.	REVISION				
064_011	Α				



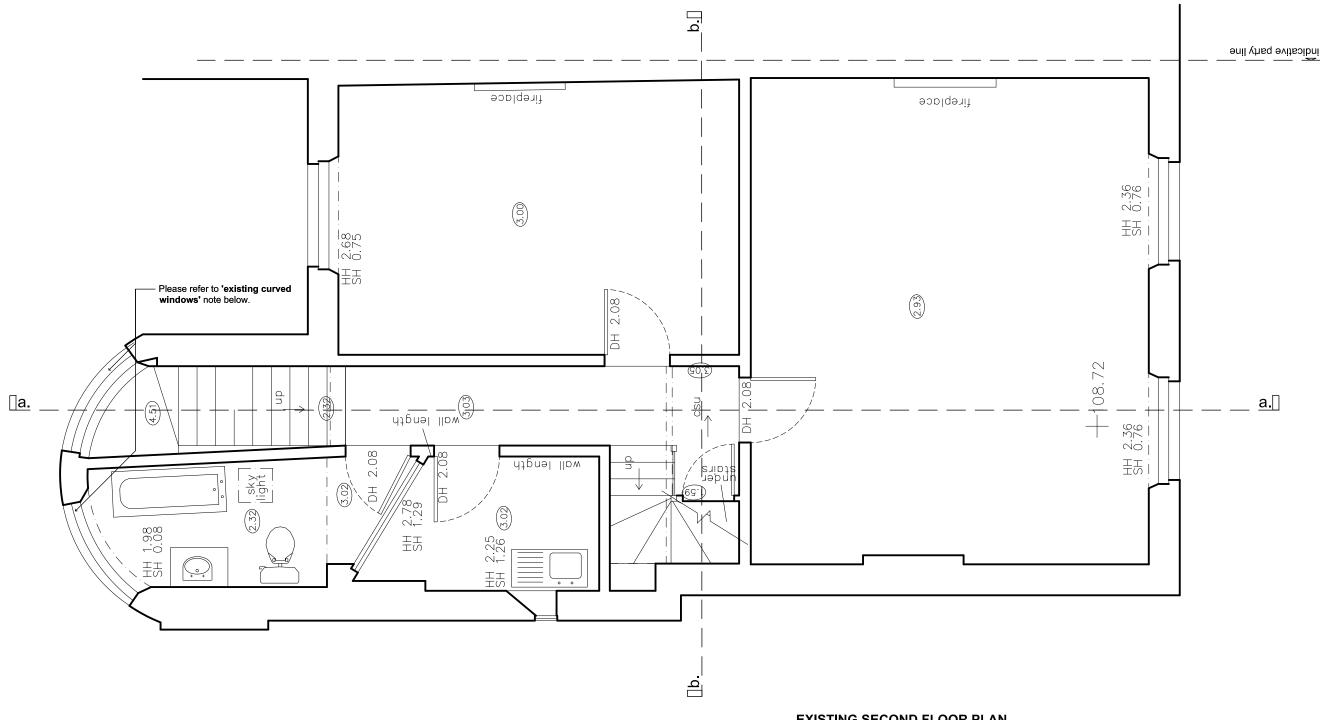


Photo 001





Photo 03



Photo 03

Existing Curved Windows Note:

Existing windows incorporating non-original and unsympathetic later added/replaced glass panes – replacement glass panes vary and are mis-matched (a mixture of stained, frosted, patterned, and clear). Please refer to photographs provided and which show historic curved glass panes replaced in some locations with straight panes within curved frames using putty. This straight panes and installation method has caused cracking and other deterioration overtime. Interim remedial work appears to have been undertaken by way of "sticky tape" to hold glass panes in place.

General notes:

This is a 'planning' level of detail drawing. It must not be used for any other purpose and is subject to further detailed design. All dimensions subject to confirmation/checks on site.

Legend:



Structure retained Structure removed New structure Line of indicative structure above Outline of surface above Area restricted to max 1.8m ceiling

EXISTING SECOND FLOOR PLAN

SCALE: 1:50@A3

0.0 0.5 1.0 1.5 4.0 5.0 A 28.10.2024 REV DATE

GENERAL NOTES
This drawing has been prepared from survey information
prepared by others and is for information purposes only.
All dinent scale from drawing, use figured dimension only.
All dinensions must be checked on site prior to commencement
of work. Report any discrepancies to the architect.
This drawings is to be read in conjunction with all other issued
information, including architects and structural engineer's
drawings and specifications. Copyright of Allen Architects Ltd.

DRAWING ISSUE PLANNING	DRAWING TITLE Existing Second Floor Plan
CLIENT	<u> </u>
Mrs J Aldridge	SCALE
	4.50@40

PROJECT TITLE Top Floor Flat 27 Belsize Square, London NW3 4HU

SCALE	DRAWN
1:50@A3	Surveyor
DATE	CHECKED
29.07.2024	-
DWG NO.	REVISION
064 012	Α



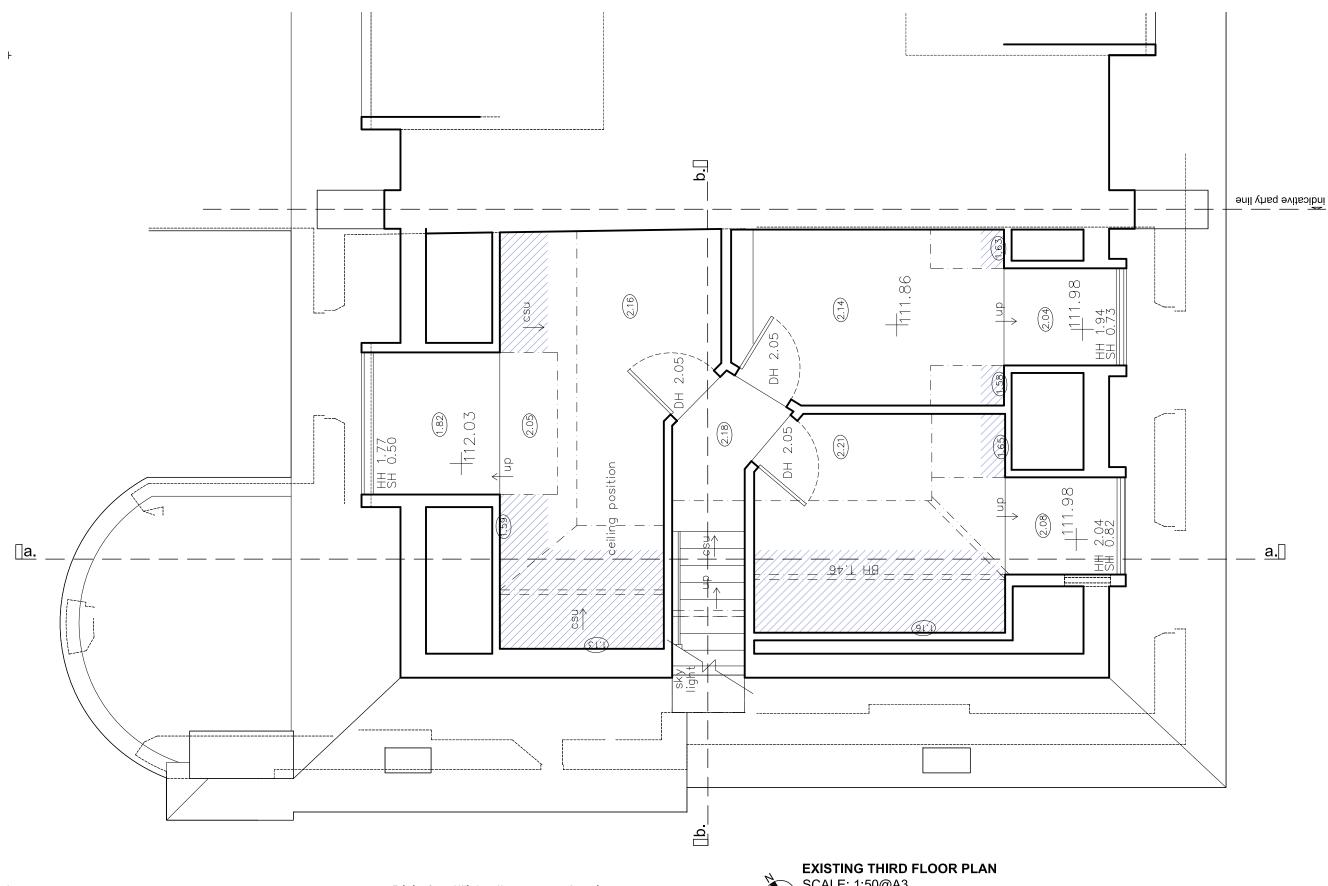










Photo 03



Photo 03

Existing Curved Windows Note:

Existing windows incorporating non-original and unsympathetic later added/replaced glass panes — replacement glass panes vary and are mis-matched (a mixture of stained, frosted, patterned, and clear). Please refer to photographs provided and which show historic curved glass panes replaced in some locations with straight panes within curved frames using putty. This straight panes and installation method has caused cracking and other deterioration overtime. Interim remedial work appears to have been undertaken by way of "sticky tape" to hold glass panes in place.

General notes:

This is a 'planning' level of detail drawing. It must not be used for any other purpose and is subject to further detailed design. All dimensions subject to confirmation/checks on site.

Legend:



Structure retained Structure removed New structure Line of indicative structure above Outline of surface above Area restricted to max 1.8m ceiling SCALE: 1:50@A3

0.0	0.5	1.0	1.5	2.0	3.0	4.0	5.0

Α	28.10.2024	Windows note added
REV	DATE	NOTE

GENERAL NOTES
This drawing has been prepared from survey information
prepared by others and is for information purposes only.
All dimensions must be checked on site prior to commencement
of work, Report any discrepancies to the architect.
This drawings is to be read in conjunction with all other issued
information, including architects and structural engineer's
drawings and specifications, Copyright of Allen Architects Ltd.

DRAWING ISSUE	DRAWING TITLE
PLANNING	Existing Third Floor Plan
CLIENT	
Mrs J Aldridge	
Wils 5 Aldridge	SCALE

Mrs J Aldridge			
Wils 5 Aldridge	SCALE	DRAWN	
-	1:50@A3	Surveyor	
PROJECT TITLE	DATE	CHECKED	
Top Floor Flat	29.07.2024	-	
27 Belsize Square, London	DWG NO.	REVISION	
NW3 4HU	064_013	A	

	Allen	
ı	architects	

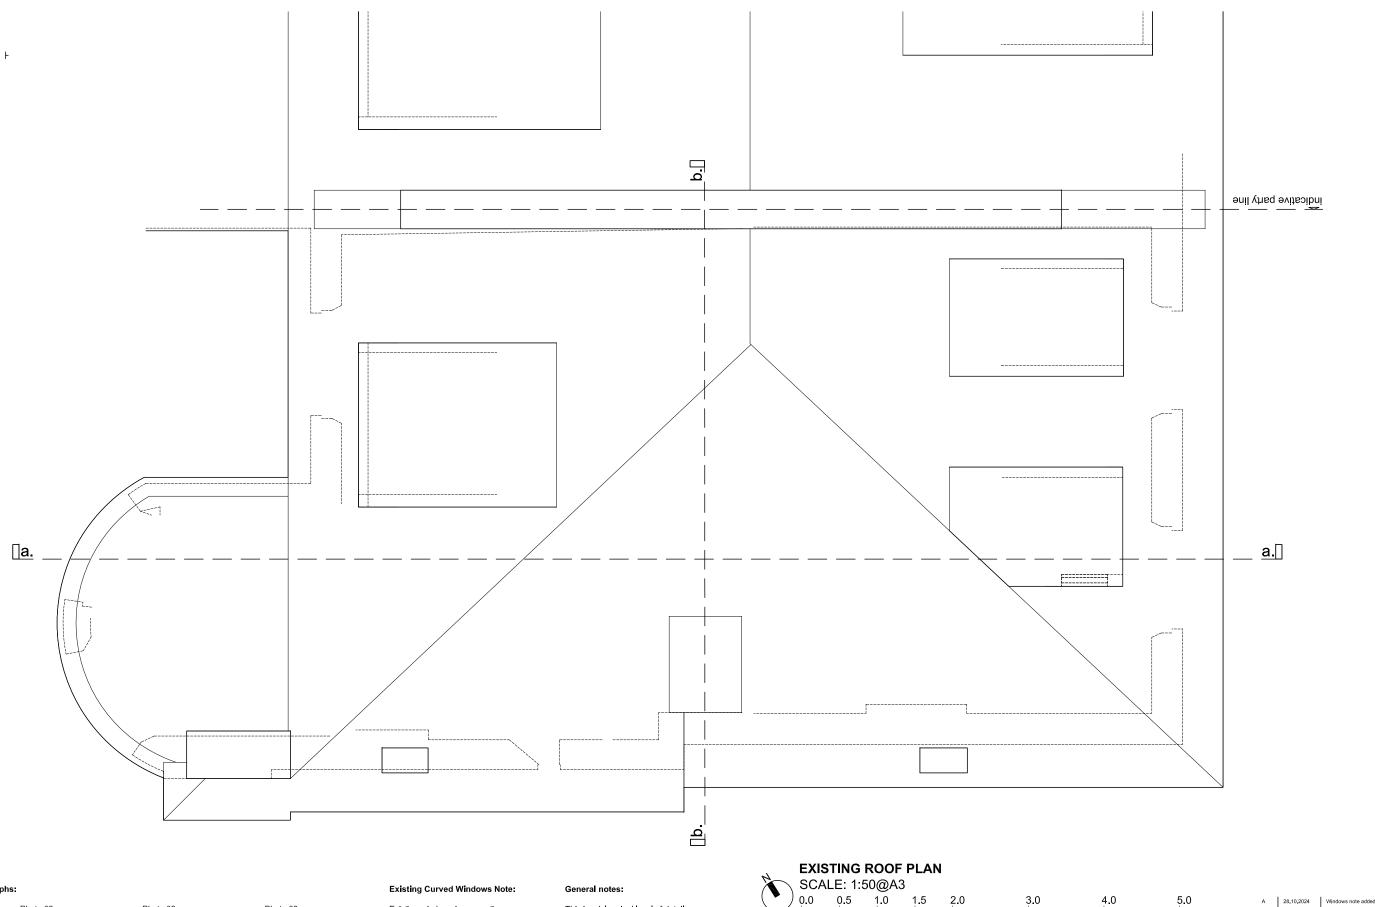










Photo 03



Existing windows incorporating non-original and unsympathetic later added/replaced glass panes – replacement glass panes vary and are mis-matched (a mixture of stained, frosted, patterned, and clear). Please refer to photographs provided and which show historic curved glass panes replaced in some locations with straight panes within curved frames using putty. This straight panes and installation method has caused cracking and other deterioration overtime. Interim remedial work appears to have been undertaken by way of "sticky tape" to hold glass panes in place. This is a 'planning' level of detail drawing. It must not be used for any other purpose and is subject to further detailed design. All dimensions subject to confirmation/checks on site.

Legend:



Structure retained Structure removed New structure Line of indicative structure above Outline of surface above Area restricted to max 1.8m ceiling 0.0 0.5 1.0 1.5 2.0

GENERAL NOTES This drawing has been prepared from survey information
prepared by others and is for information purposes only. Do not scale from drawing, use figured dimension only. All dimensions must be checked on site prior to commencement
of work. Report any discrepancies to the architect. This drawings is to be read in conjunction with all other issued information, including architect's and structural engineer's
drawings and specifications. Copyright of Allen Architects Ltd.


TES atlon only only	DRAWING ISSUE PLANNING
nent	CLIENT
itect. sued	Mrs J Aldridge
eer's	-


CLIENT	-
Mrs J Aldridge	SCA
-	1:5
PROJECT TITLE	
Top Floor Flat	29.0
27 Belsize Square, London	D W
NW3 4HU	064

DRAWING TITLE	
Existing Roof Plan	
-	
SCALE	DRAWN
1:50@A3	Surveyor
DATE	CHECKED
	CHECKED
29.07.2024	=
DWG NO.	REVISION
064 014	Α



REV DATE

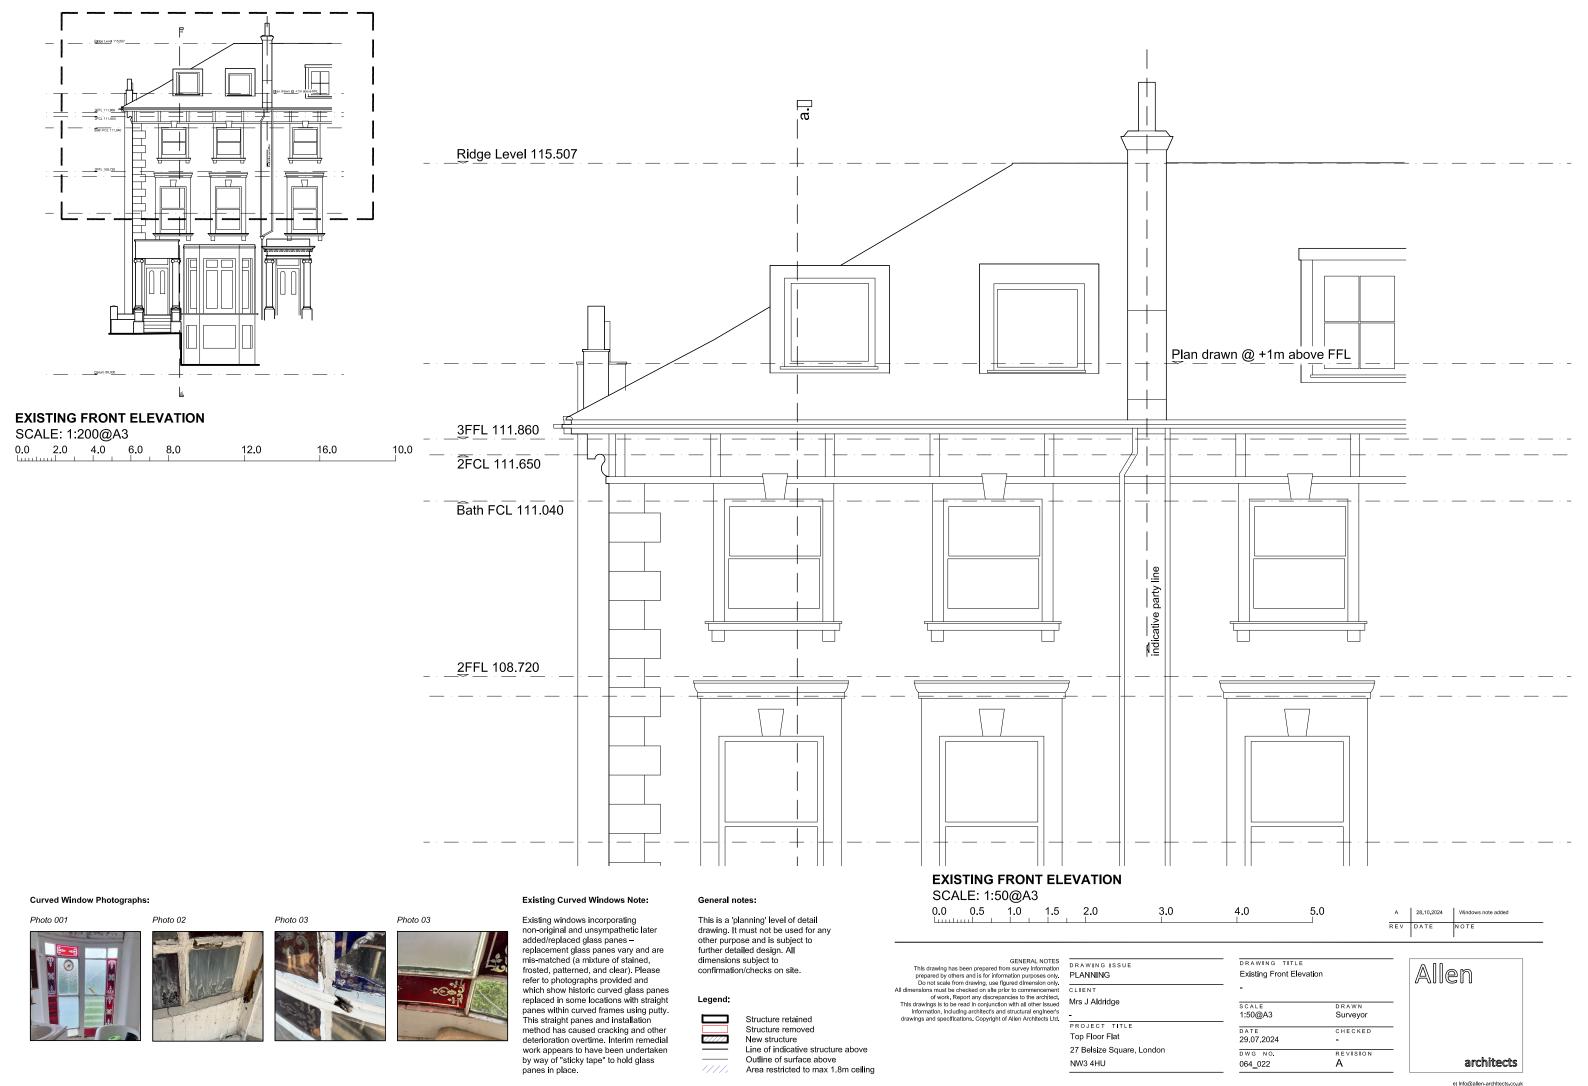

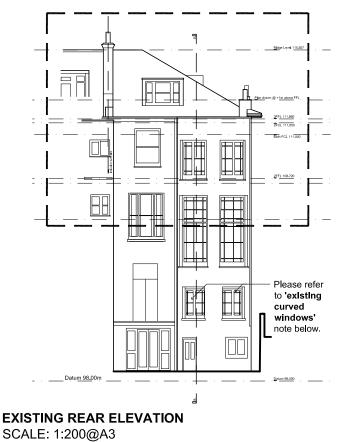

SCALE: 1:200@A3

0.0 2.0 4.0 6.0 12.0 16.0 10.0



a.

Curved Window Photographs:

Photo 001







Photo 03

Existing windows incorporating non-original and unsympathetic later added/replaced glass panes replacement glass panes vary and are mis-matched (a mixture of stained, frosted, patterned, and clear). Please refer to photographs provided and which show historic curved glass panes replaced in some locations with straight panes within curved frames using putty. This straight panes and installation method has caused cracking and other deterioration overtime. Interim remedial work appears to have been undertaken by way of "sticky tape" to hold glass panes in place.

This is a 'planning' level of detail drawing. It must not be used for any other purpose and is subject to further detailed design. All dimensions subject to confirmation/checks on site.

Legend:



Structure retained Structure removed New structure Line of indicative structure above Outline of surface above Area restricted to max 1.8m ceiling 0.0 0.5 1.0 1.5 3.0 4.0 5.0 A 28.10.2024 Windows note adde REV DATE


GENERAL NOTES
This drawing has been prepared from survey information
prepared by others and is for information purposes only.
Do not scale from drawing, use flgured dimension only.
All dimensions must be checked on site prior to commencement
of work. Report any discrepancies to the architect.
This drawings is to be read in conjunction with all other issued
information, including architects and structural engineer's
drawings and specifications. Copyright of Allen Architects Ltd.


DRAWING ISSUE	
PLANNING	
CLIENT	
Mrs J Aldridge	

1:50@A3 PROJECT TITLE Top Floor Flat 29.07.2024 27 Belsize Square, London DWG NO. NW3 4HU 064_021

Allen Existing Rear Elevation DRAWN Surveyor CHECKED REVISION architects

Ridge Level 115.507

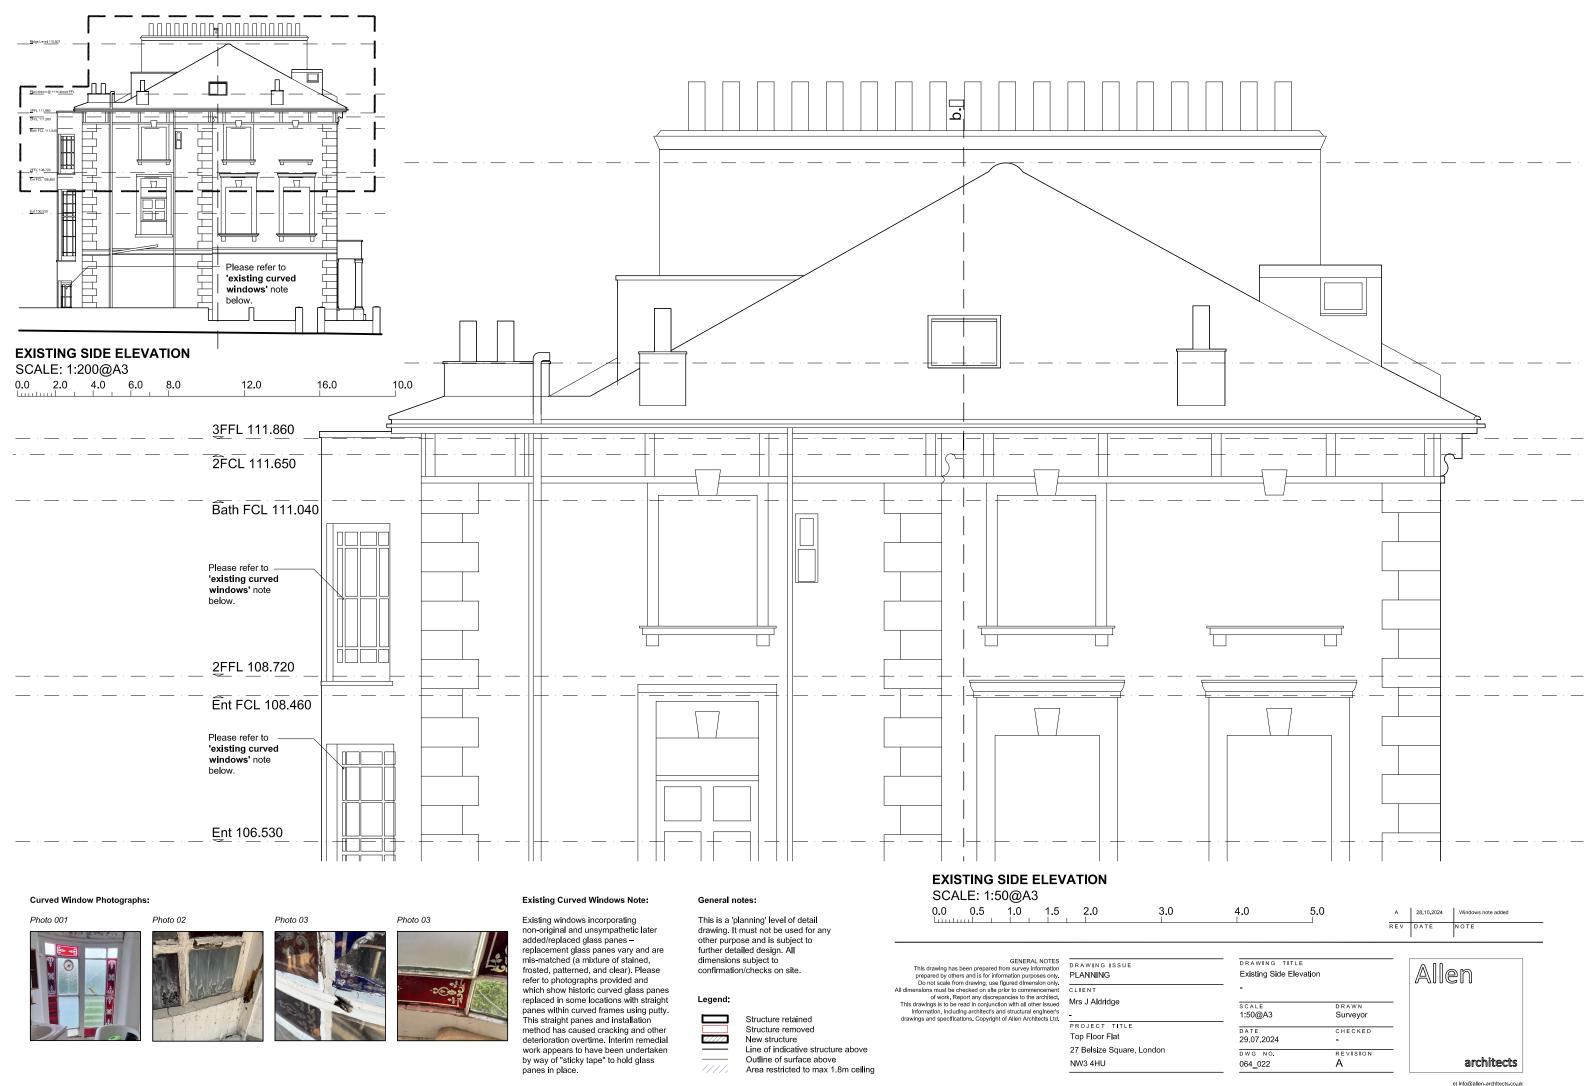

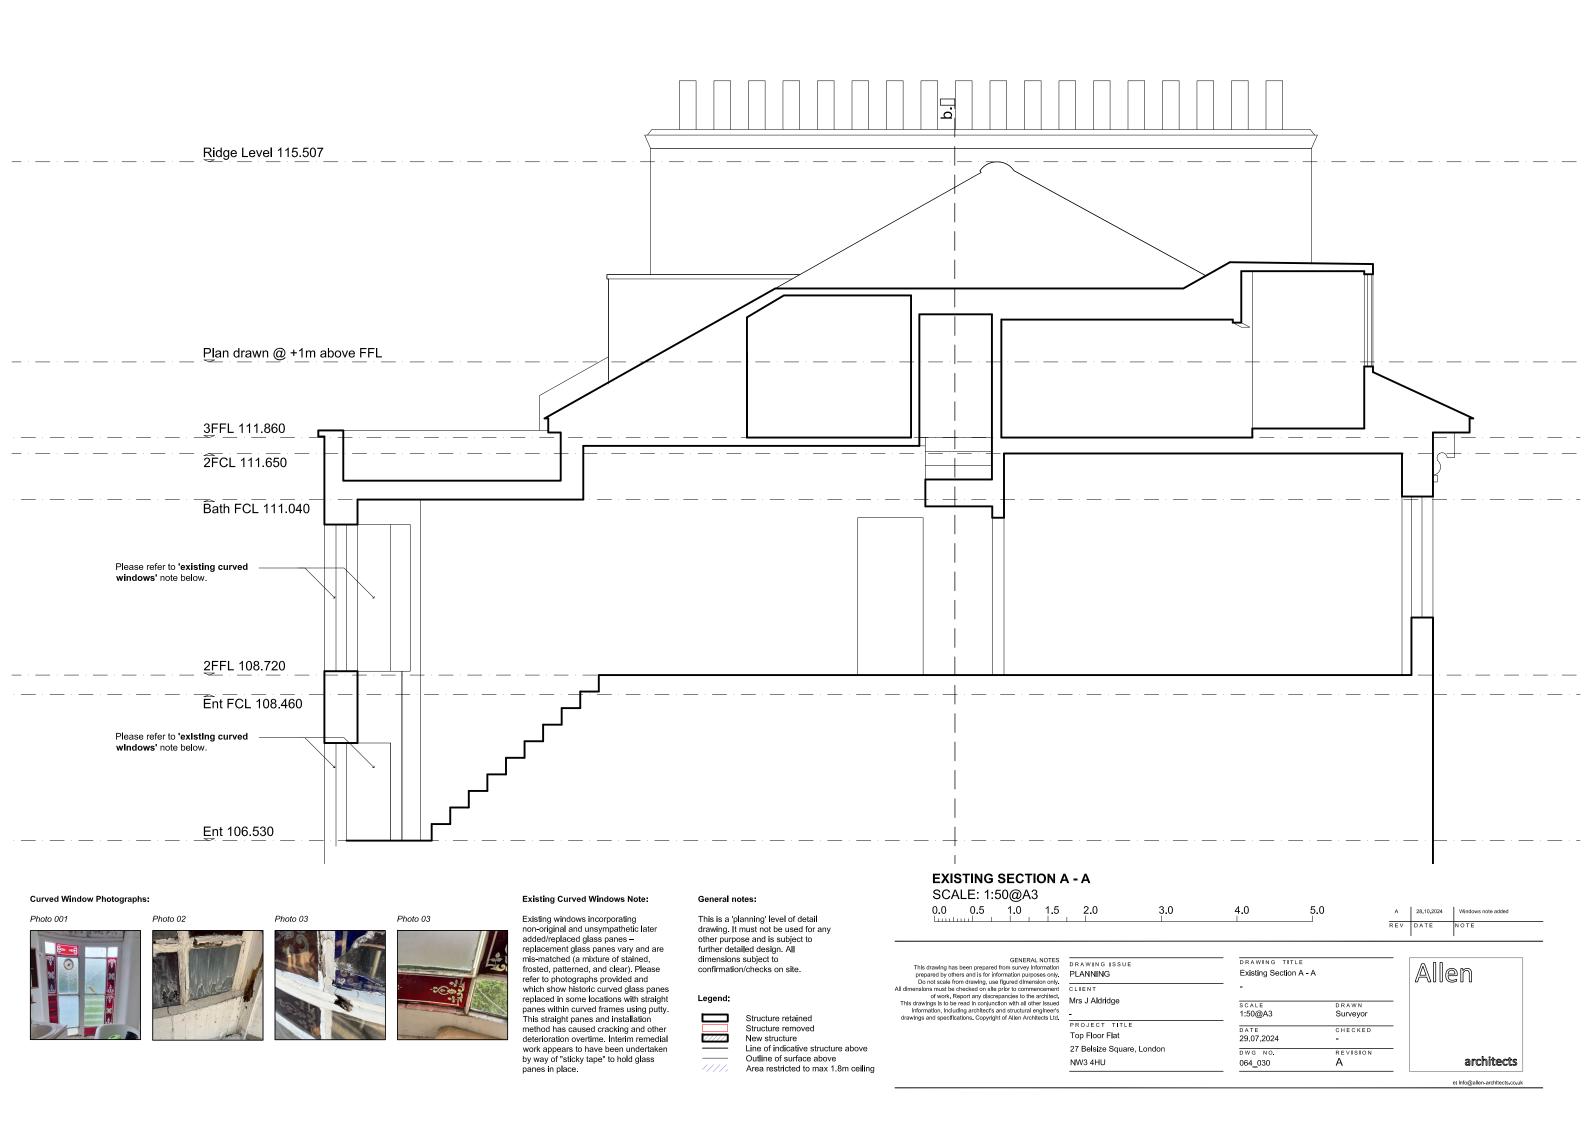

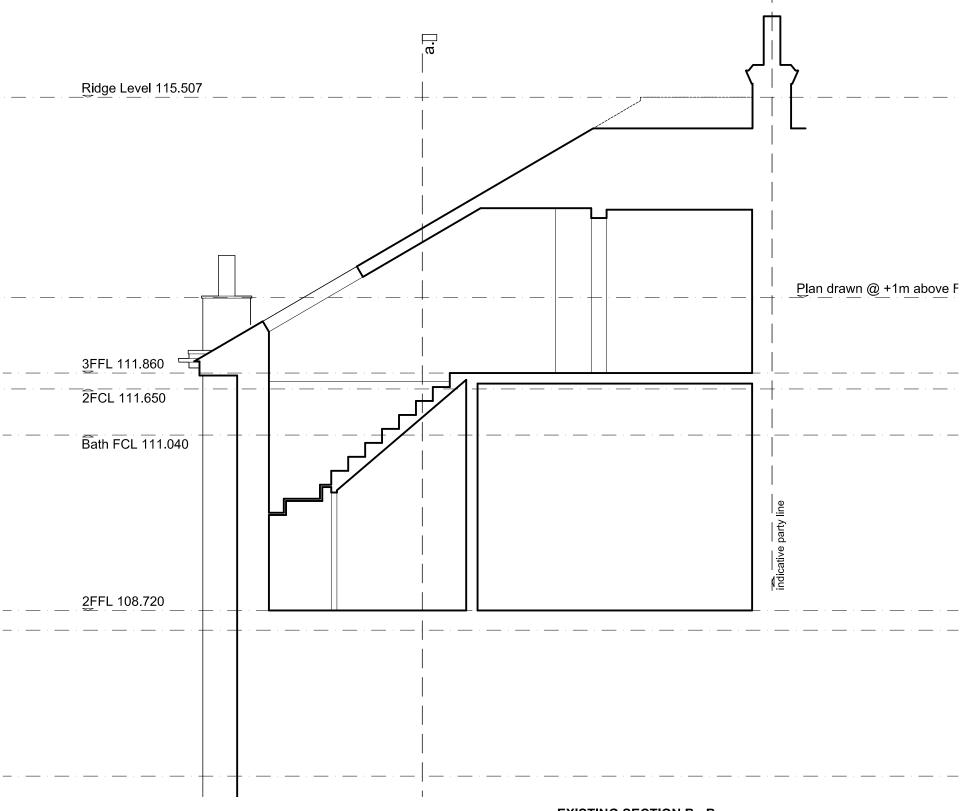


Photo 001



Photo 03

Photo 03



Existing Curved Windows Note:

Existing windows incorporating non-original and unsympathetic later added/replaced glass panes – replacement glass panes vary and are mis-matched (a mixture of stained, frosted, patterned, and clear). Please refer to photographs provided and which show historic curved glass panes replaced in some locations with straight panes within curved frames using putty. This straight panes and installation method has caused cracking and other deterioration overtime. Interim remedial work appears to have been undertaken by way of "sticky tape" to hold glass panes in place.

General notes:

This is a 'planning' level of detail drawing. It must not be used for any other purpose and is subject to further detailed design. All dimensions subject to confirmation/checks on site.

Legend:



Structure retained Structure removed New structure Line of indicative structure above Outline of surface above
Area restricted to max 1.8m ceiling

EXISTING SECTION B - B

SCALE: 1:50@A3

0.0 0.5 1.0 1.5 3.0 4.0 5.0 A 28.10.2024 Windows note added

GENERAL NOTI
This drawing has been prepared from survey informati
prepared by others and is for information purposes on
Discale from drawing, use figured dimension on
All dinensions must be checked on site prior to commenceme
of work. Report any discrepancies to the archite
This drawings is to be read in conjunction with all other issu
information, including architects and structural enginee
drawings and specifications, Copyright of Allen Architects L

DRAWING ISSUE	
PLANNING	
CLIENT	
Mrs J Aldridge	

Existing Section B - B	
-	
scale	DRAWN
1:50@A3	Surveyor
DATE	CHECKED
29.07.2024	-
DWG NO.	REVISION
064_031	A
	SCALE 1:50@A3 DATE 29.07.2024

DRAWING TITLE

