


APPENDIX C – EXISTING INFORMATION (TOPOGRAPHICAL & BURIED SERVICES SURVEYS)


Maltby Land Survey - Topographical Survey (2024)

Drawing No. 24/190/100/A - Topographic Survey

Subsight Surveys - Underground Services Survey (2013)

Drawing No. 46178-1 Location of Underground Services and Drains

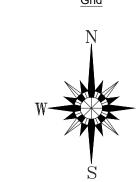

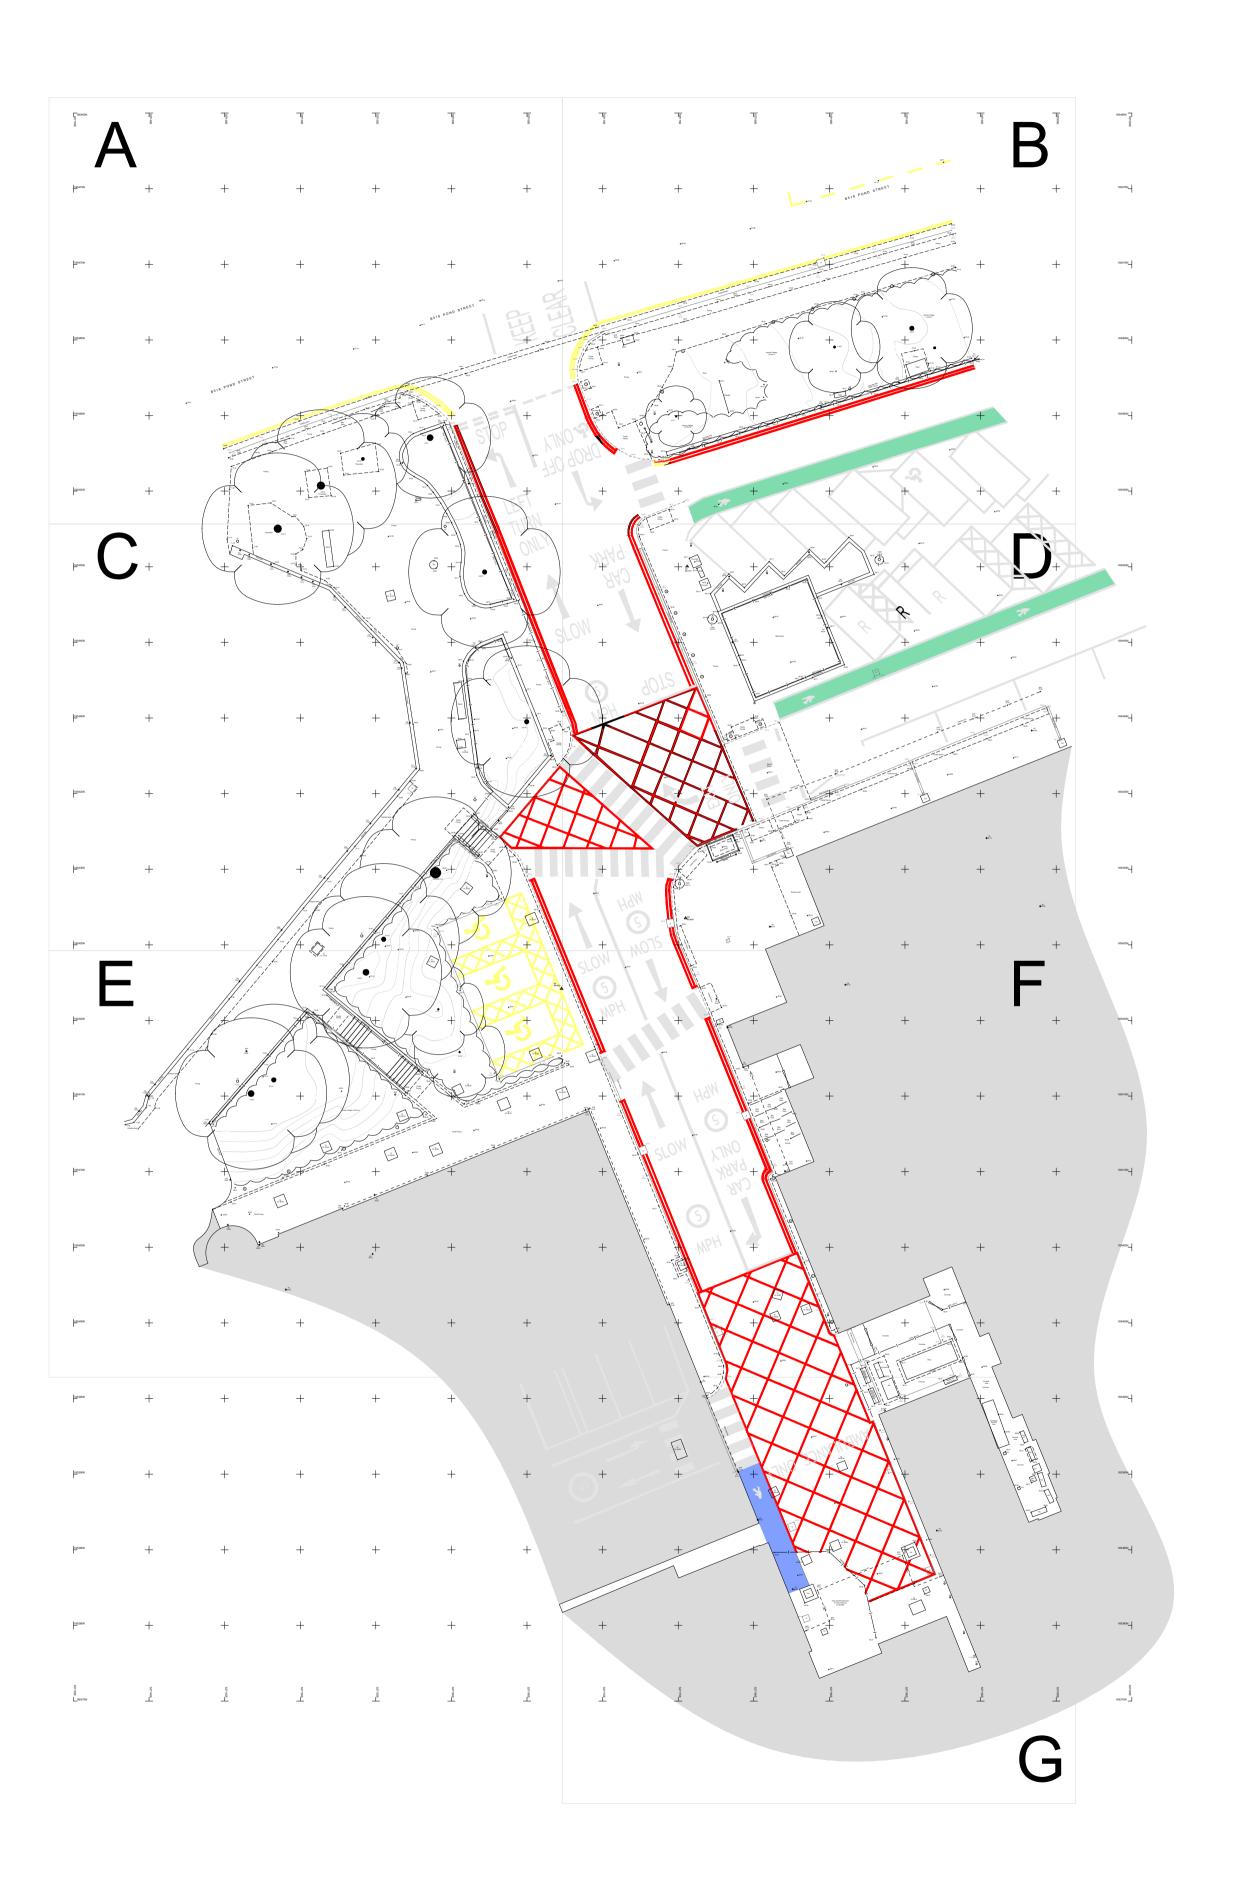

SURVEY STATIONS - COORDINATE SCHEDULE

 Station
 Easting
 Northing
 Level


 S1
 527175.591
 185450.030
 68.721

 S2
 527167.286
 185422.104
 68.620

 S3
 527175.495
 185426.770
 68.649

Survey station S2 has a direct relationship to the Ordnance Survey active network. All other stations have been descaled about this point. The scale factor for these quoted stations is 1.

This is effectively a local coordinate system with a good connection to the OS to facilitate overlaying of further OS digital data.

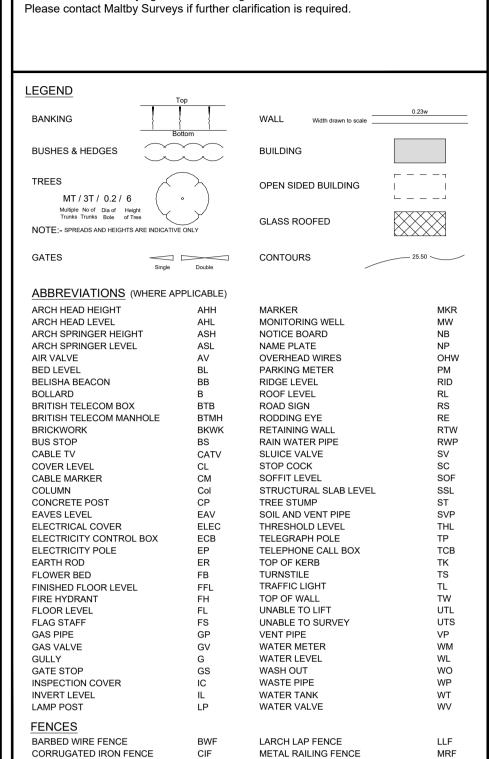







POST AND CHAIN FENCE

POST AND RAIL FENCE POST AND WIRE FENCE

TUBULAR STEEL RAIL FENCE

STEEL PALISADE SECURITY FENCE SPSF

PICKET FENCE

Notes

CLOSE BOARD FENCE

CHESTNUT PALING FENCE


CHAIN LINK FENCE

IRON RAILING FENCE

FENCE POST INTERWOVEN FENCE

Grid and levels relate to OS GPS Active Network. Sheet is North orientated unless stated.

Maltby Surveys Ltd

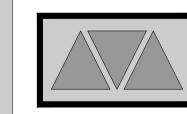

2 QUEENS ROAD
HAYWARDS HEATH
WEST SUSSEX
RH16 1EB
Tel: 01444 416246
E-Mail: mls@maltbysurveys.com
WebSite: www.maltbysurveys.com

SURVEYED GI CLIENT

DRAWN GI
CHECKED AKM

SCALE


RICS


1/250 (A1 Sheet)


Hybrid Theatres Royal Free Hospital NW3 2QG


TOPOGRAPHICAL SURVEY


Job No	Rev			Dra	wing	g Nu	ımbe	er					
24/190	-		2	4/19	90/1	00/0	Ovei	viev	N				
Date: Au	a 2024												

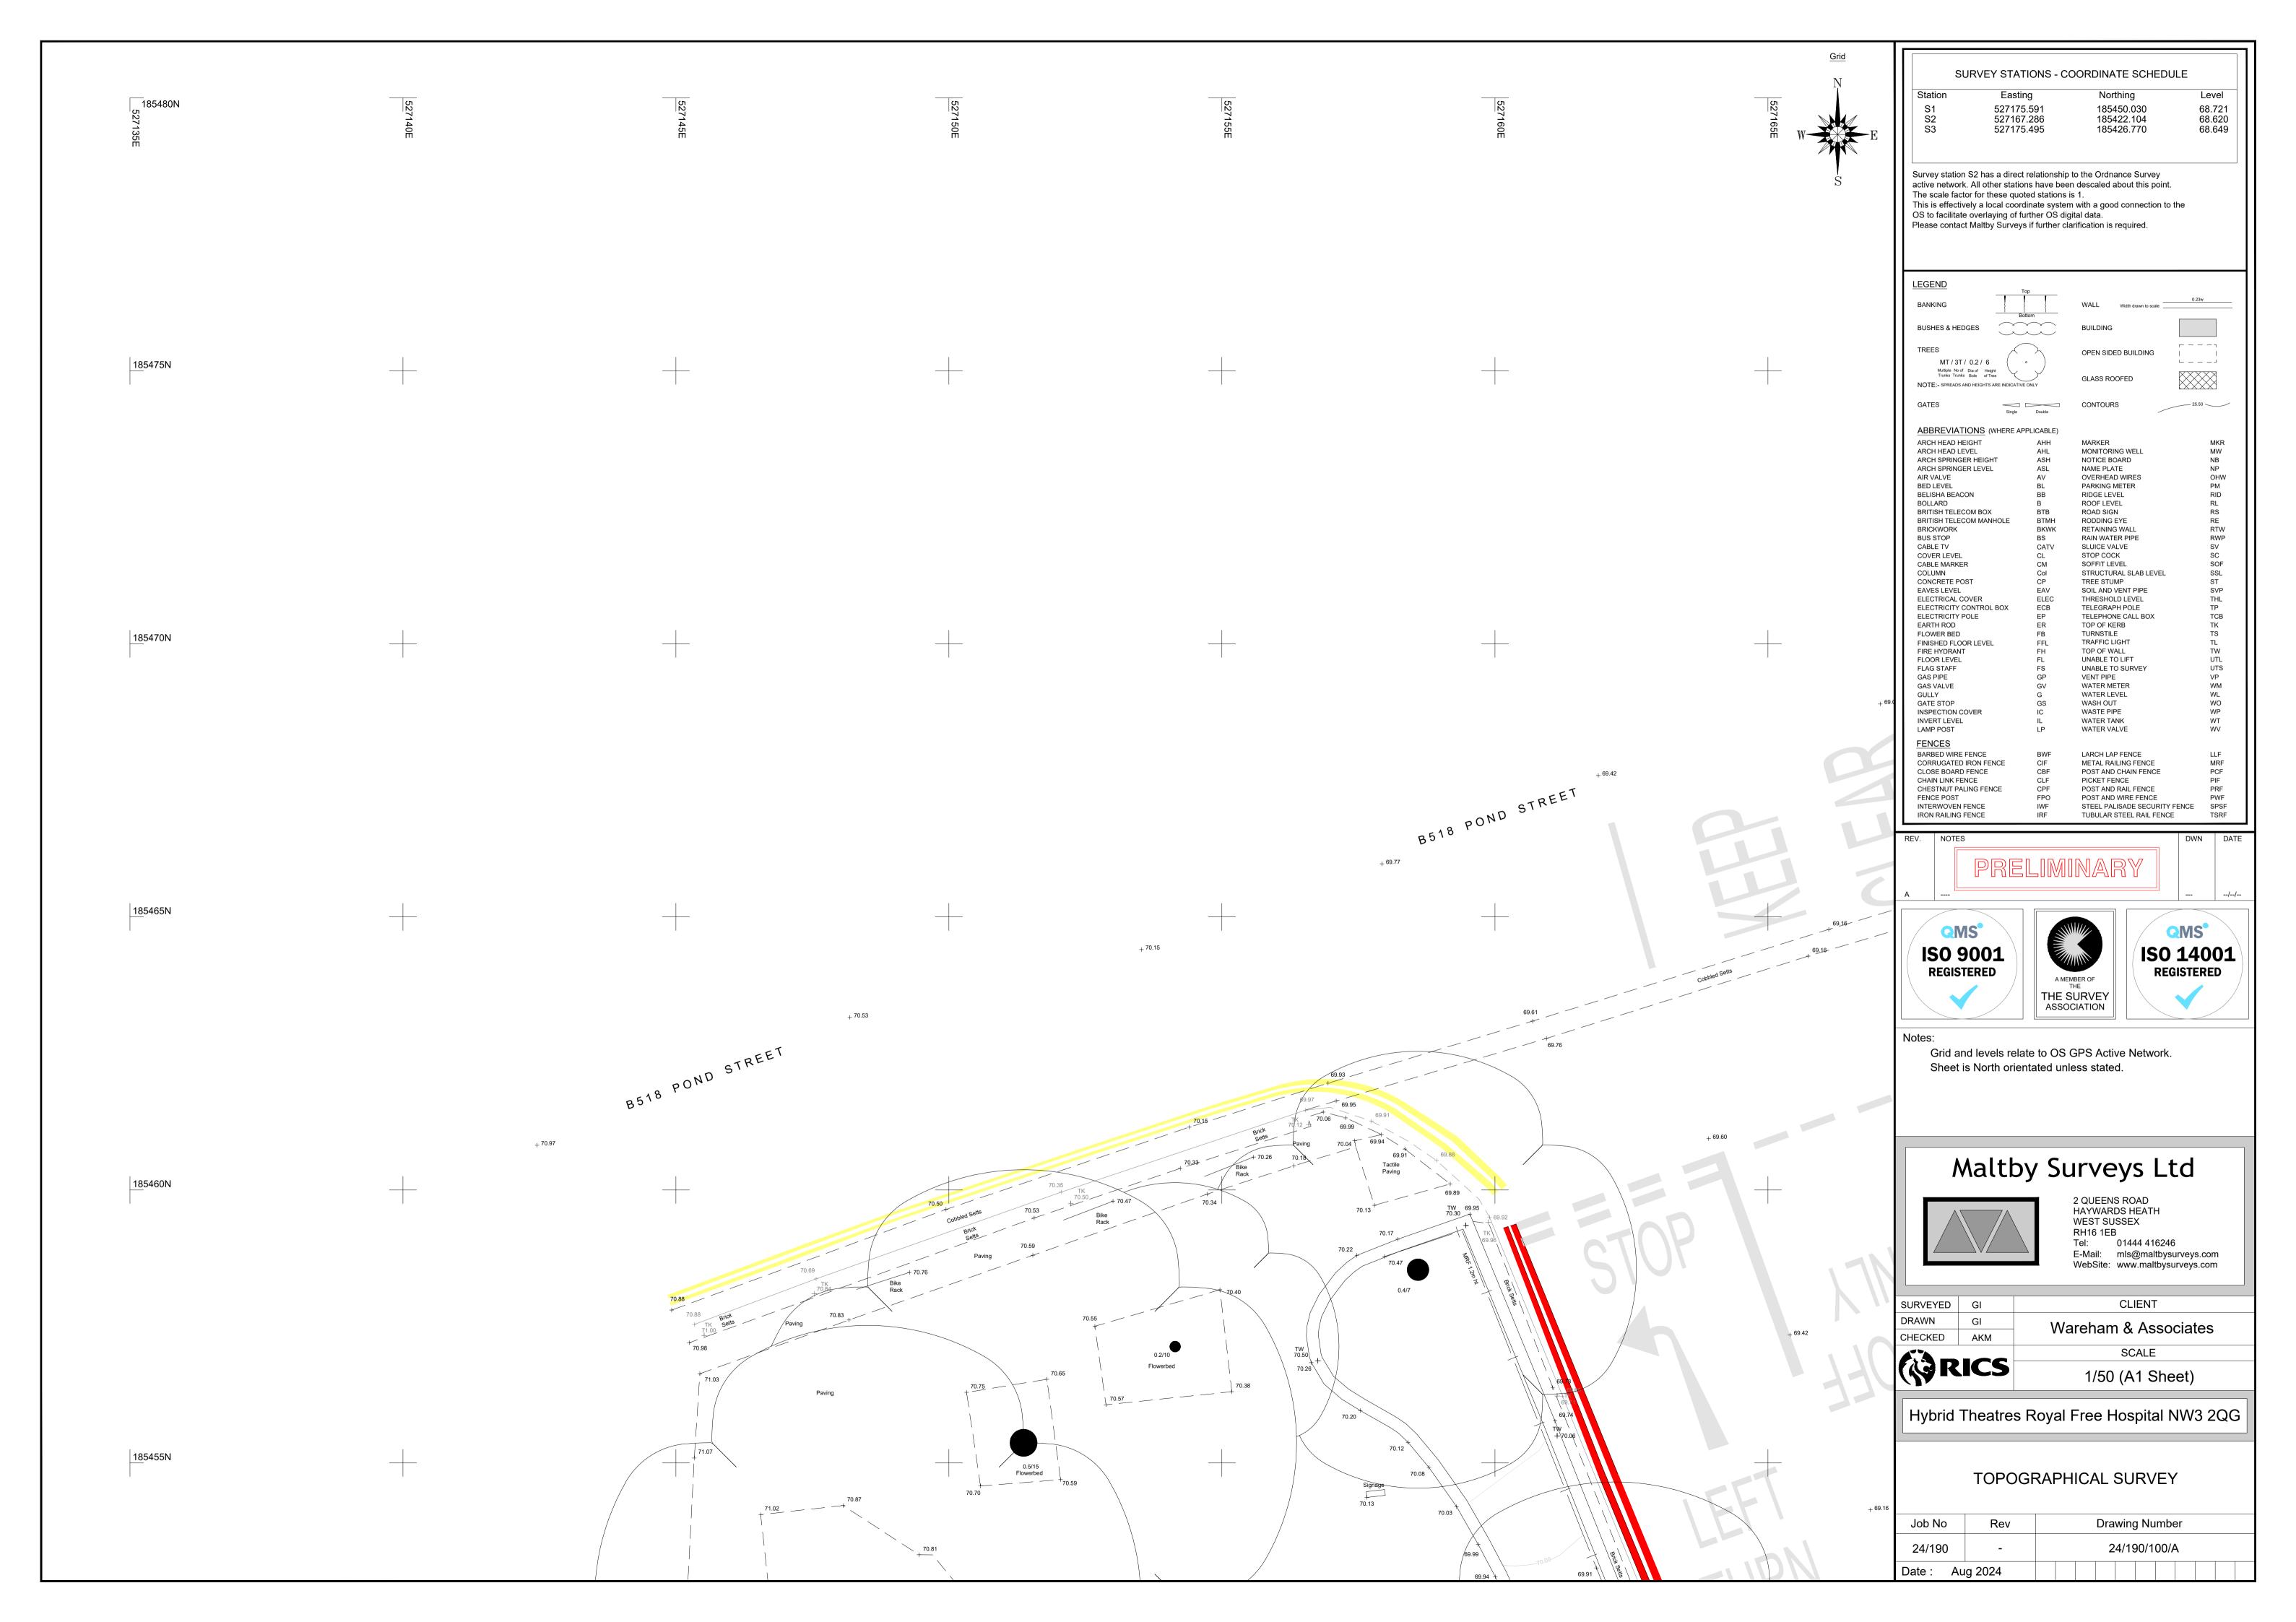

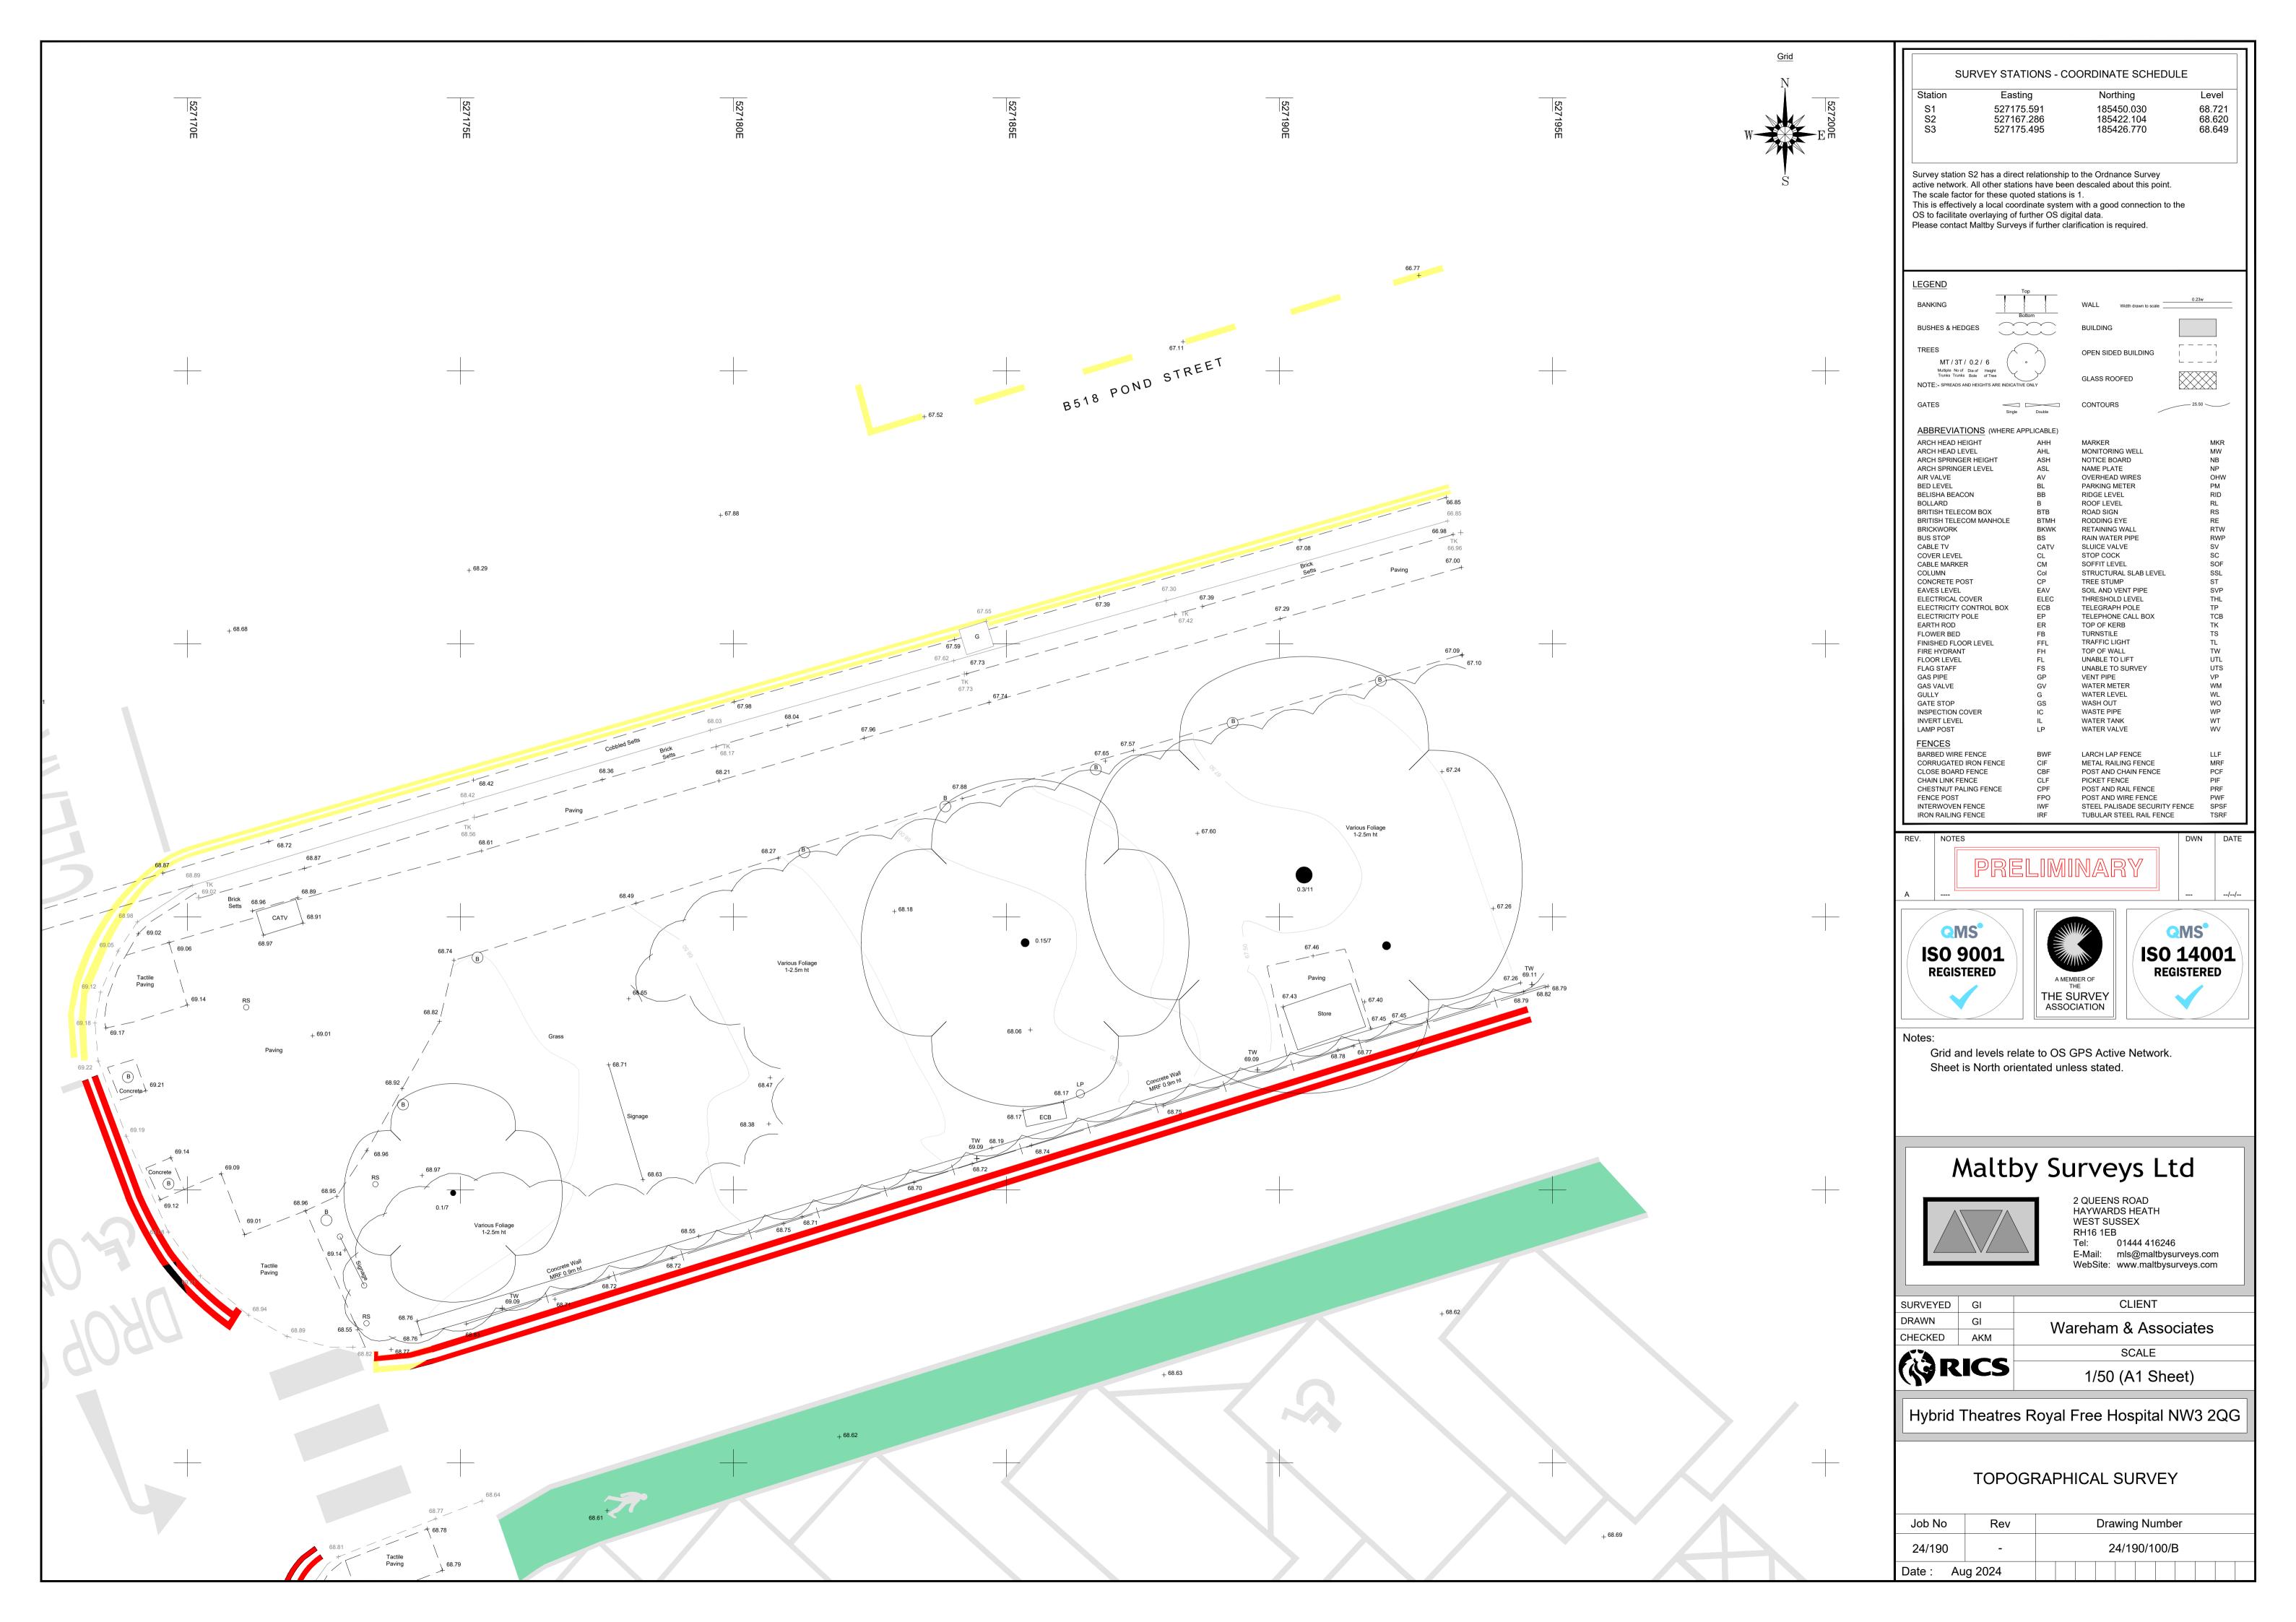


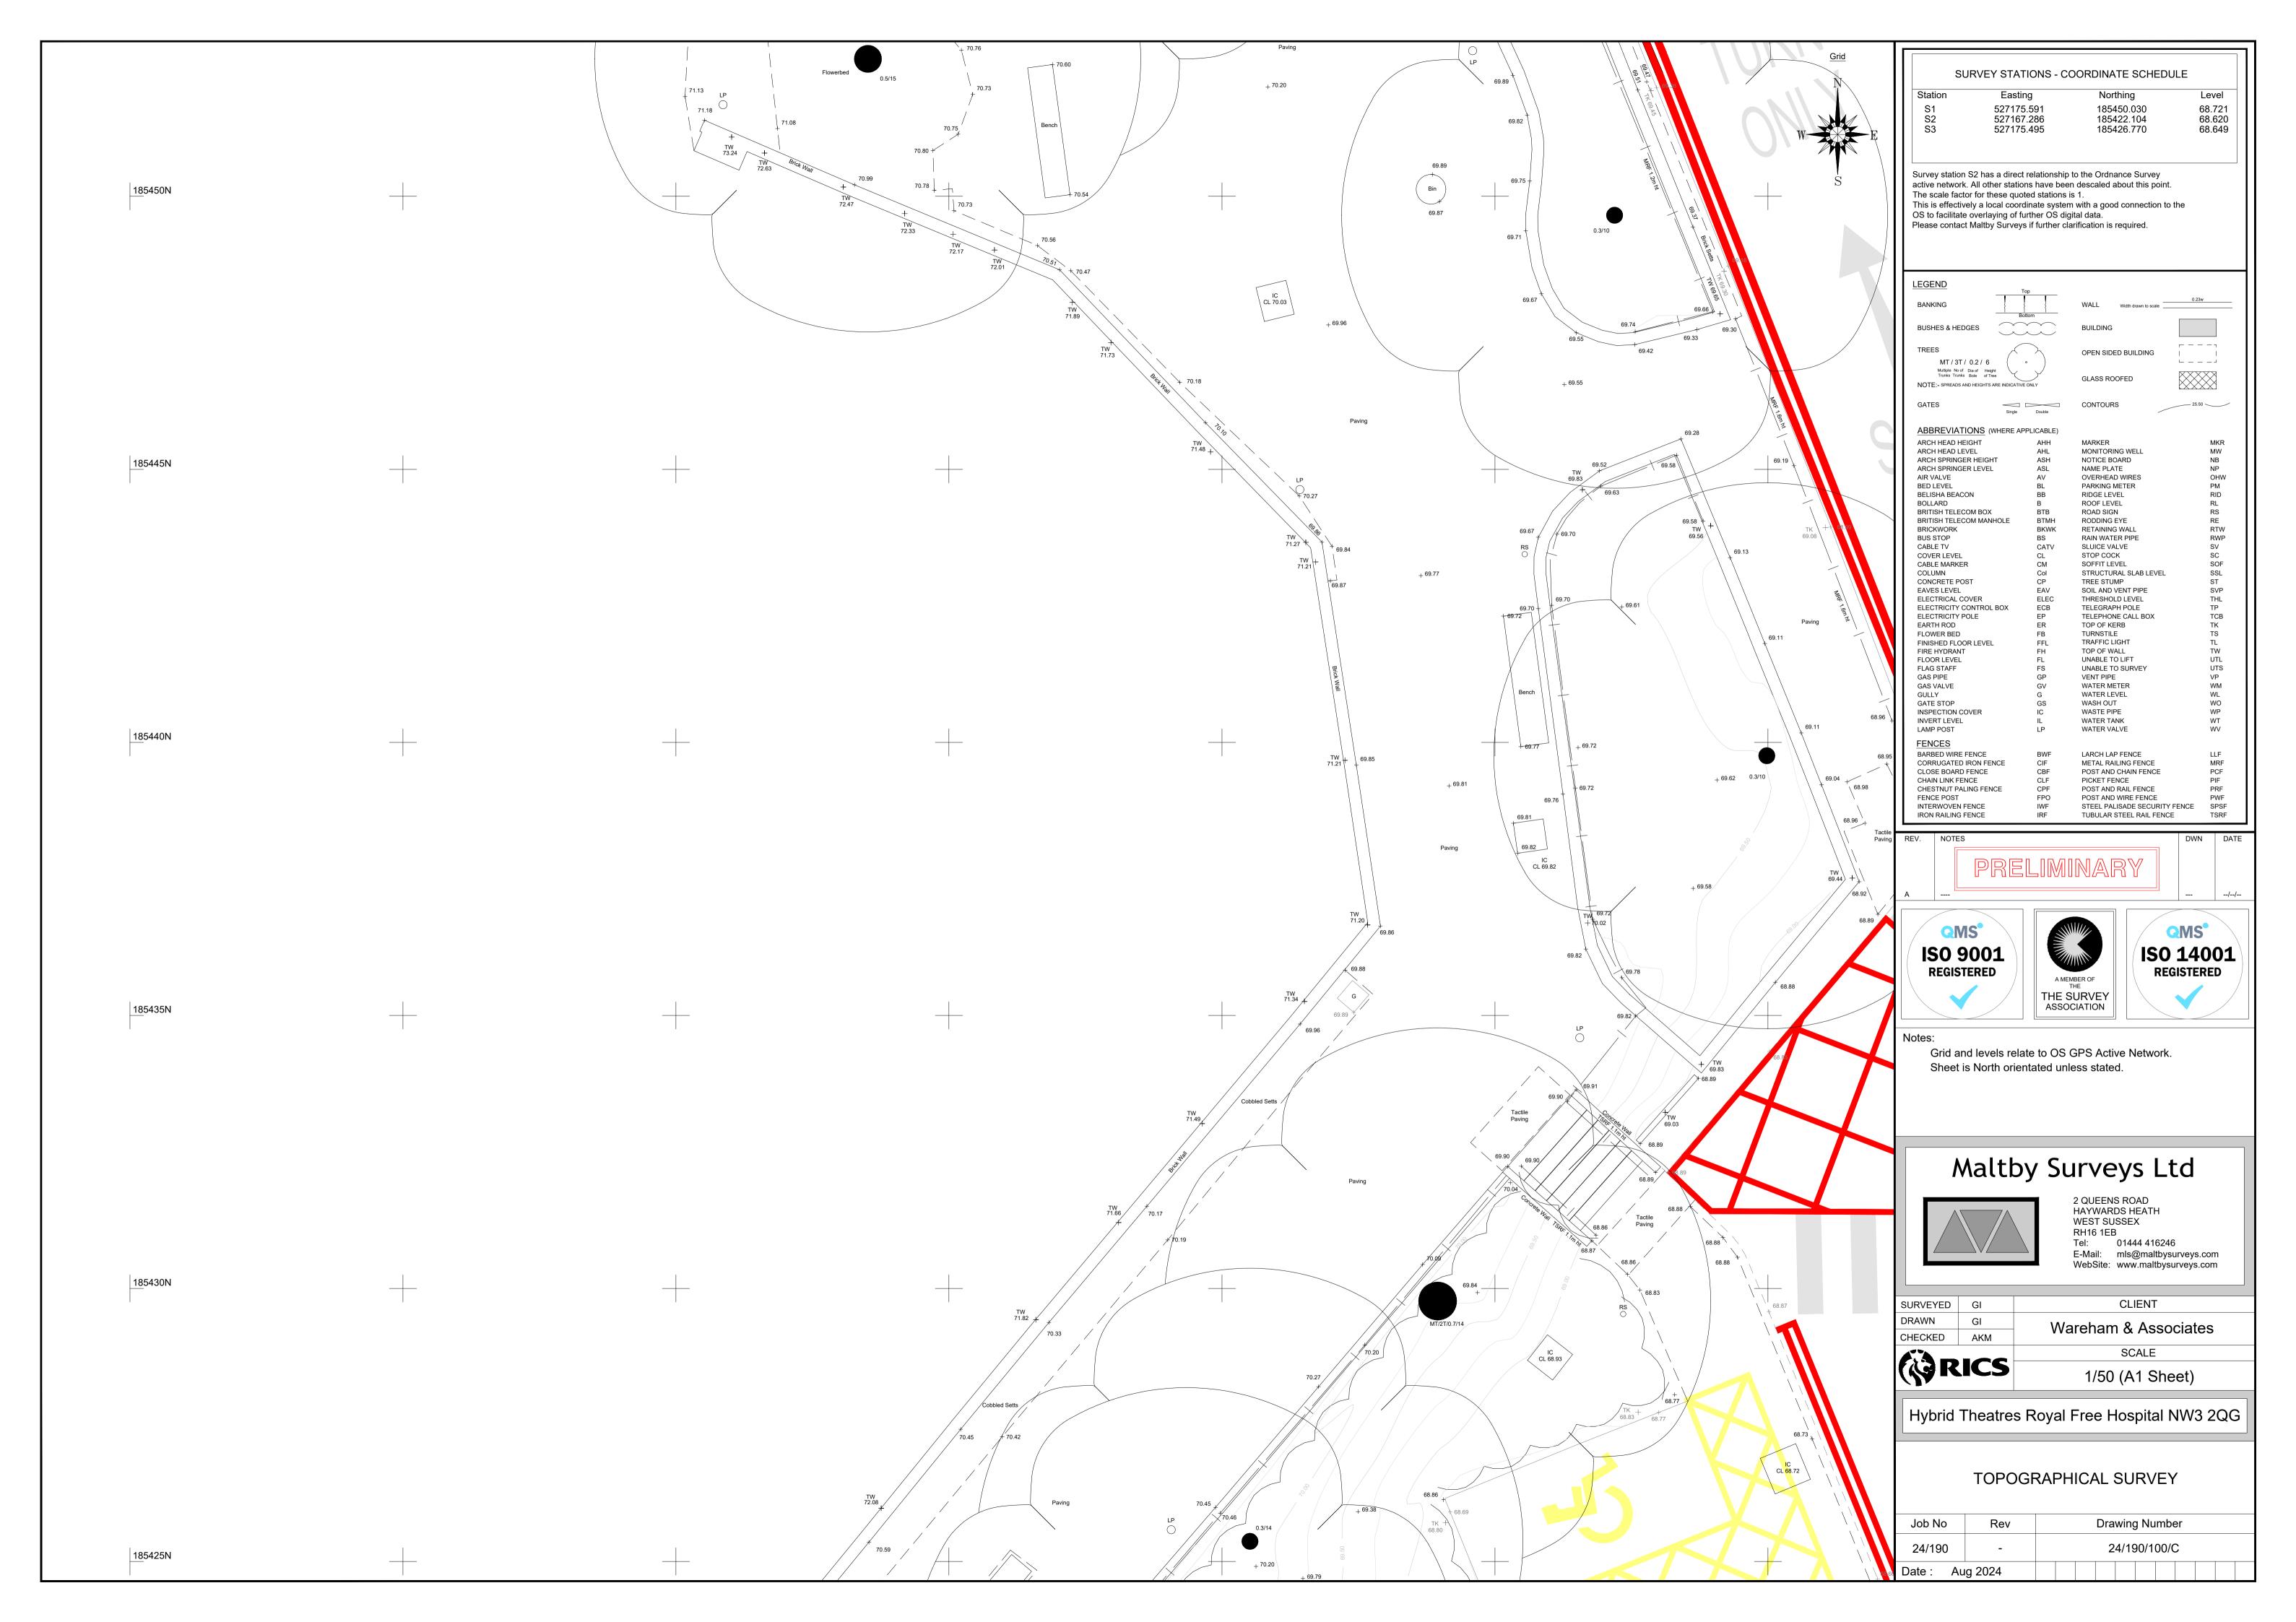


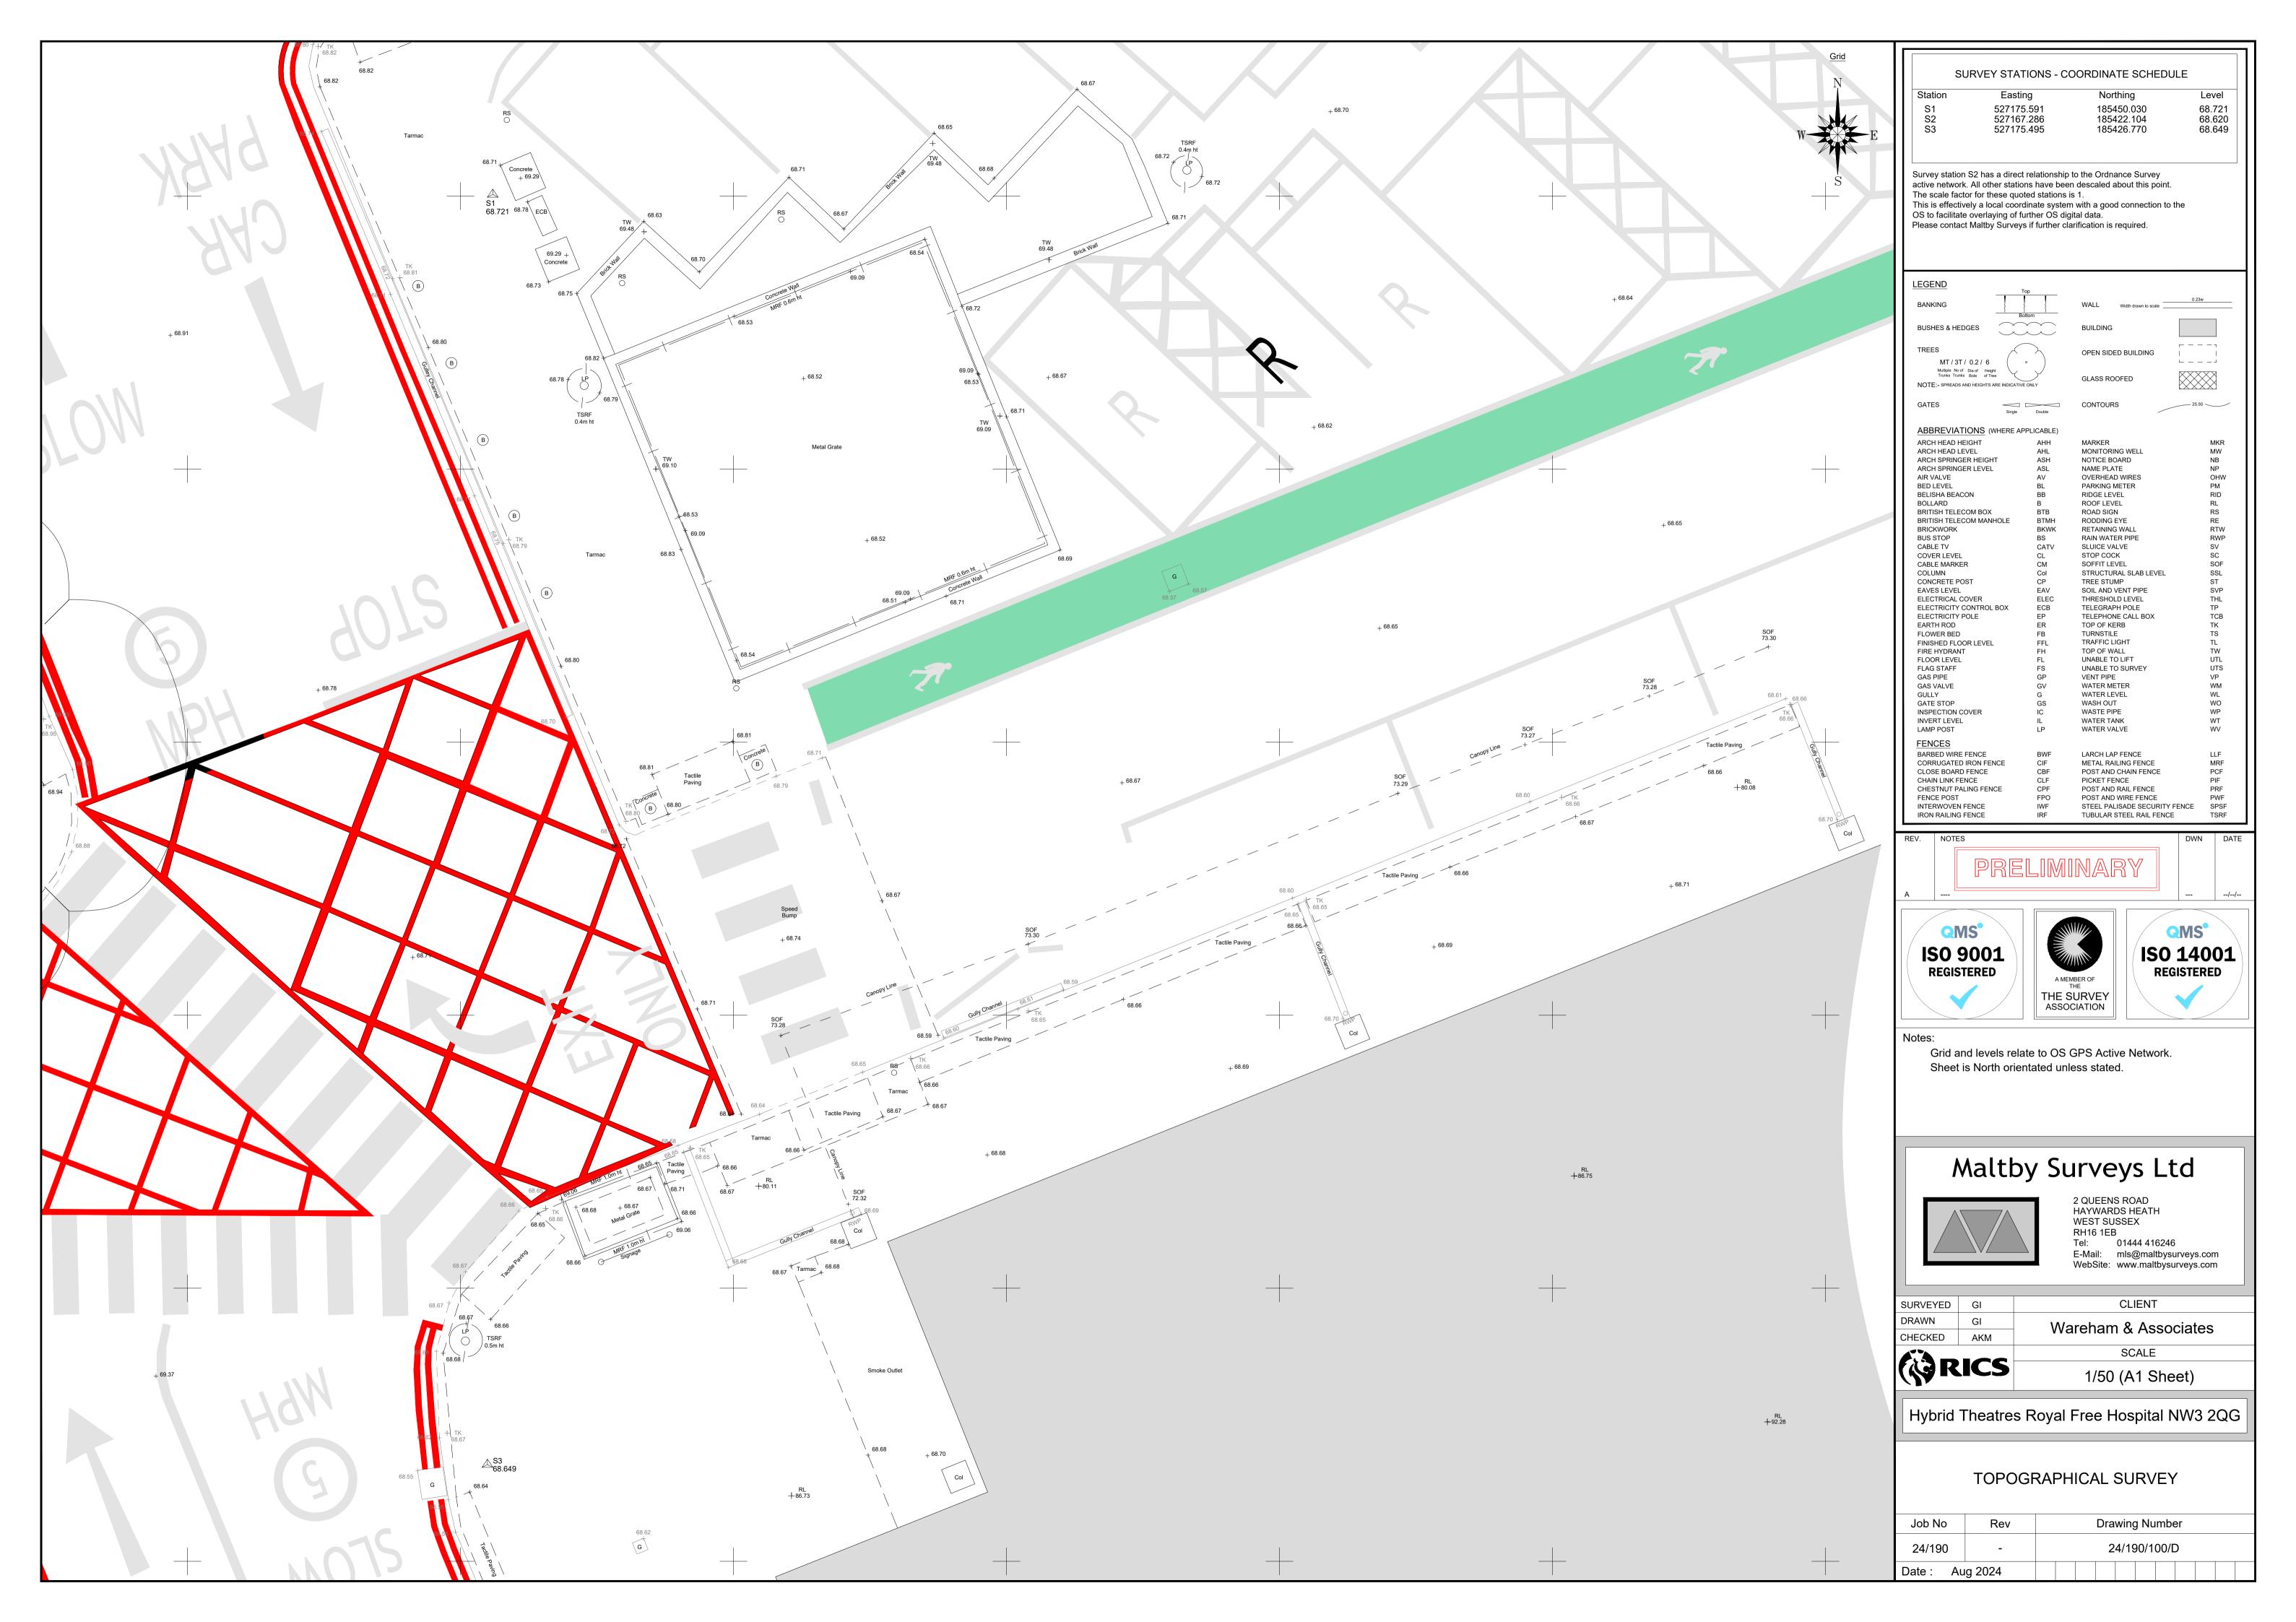

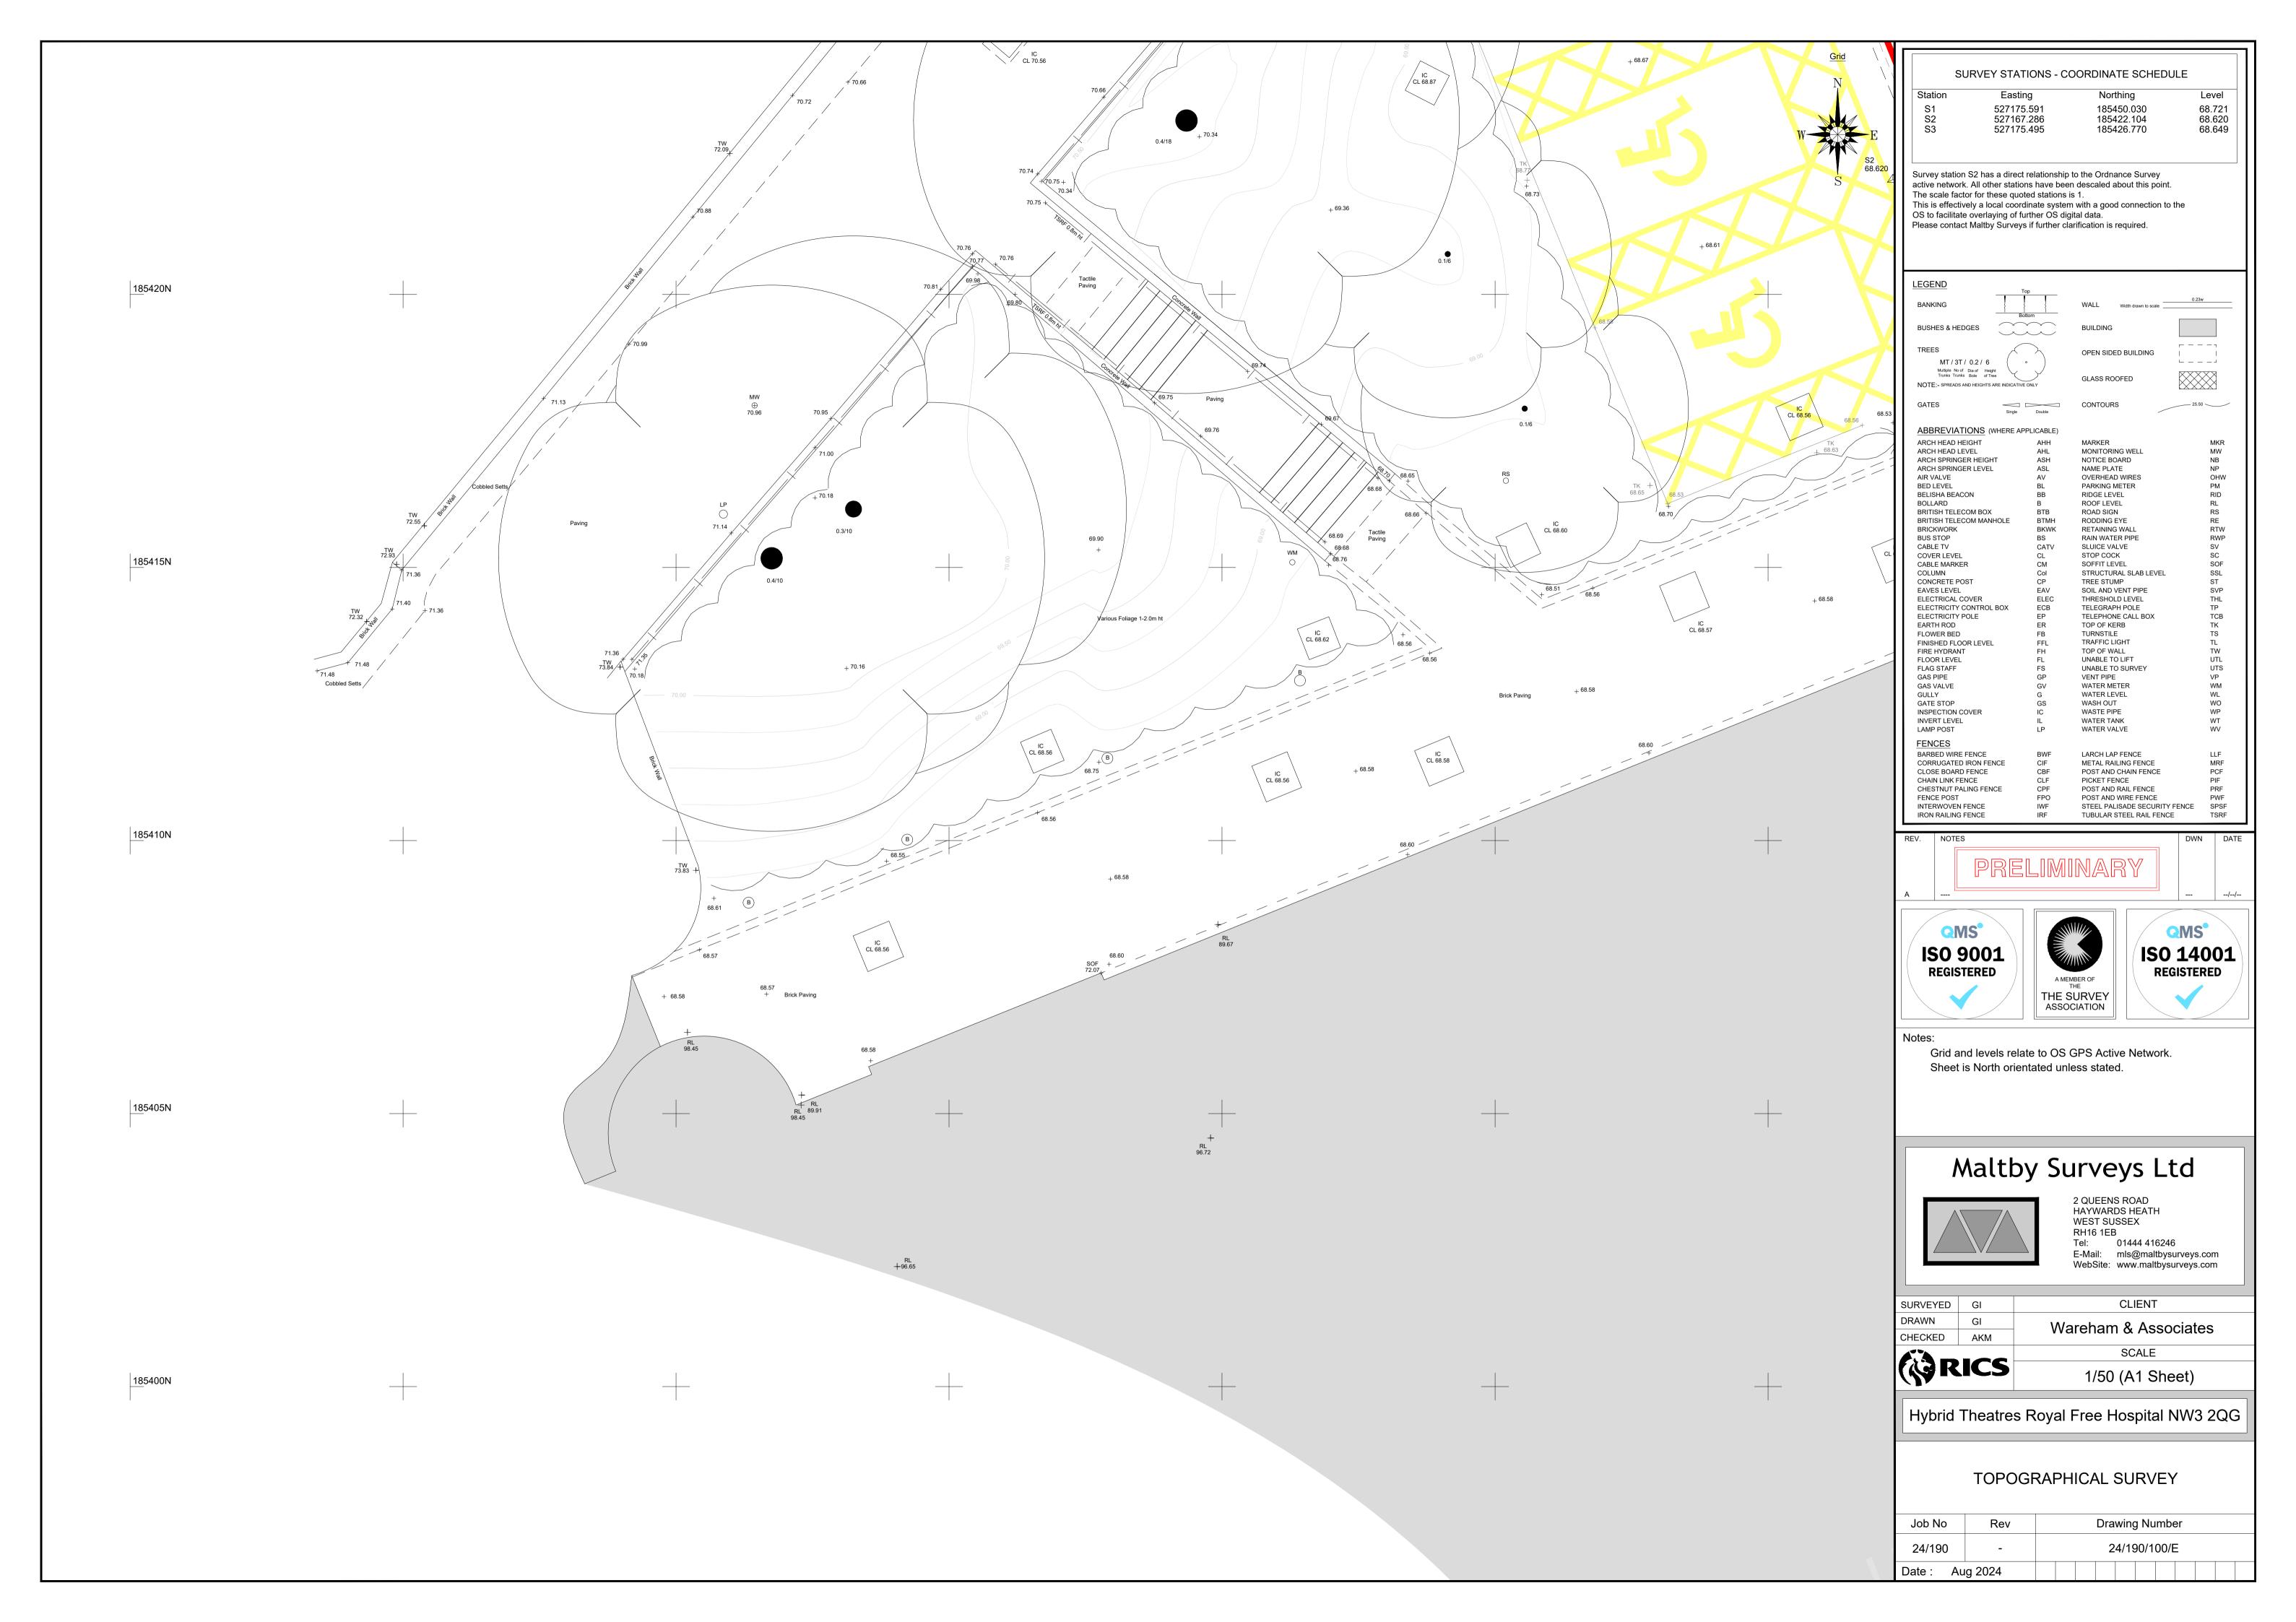



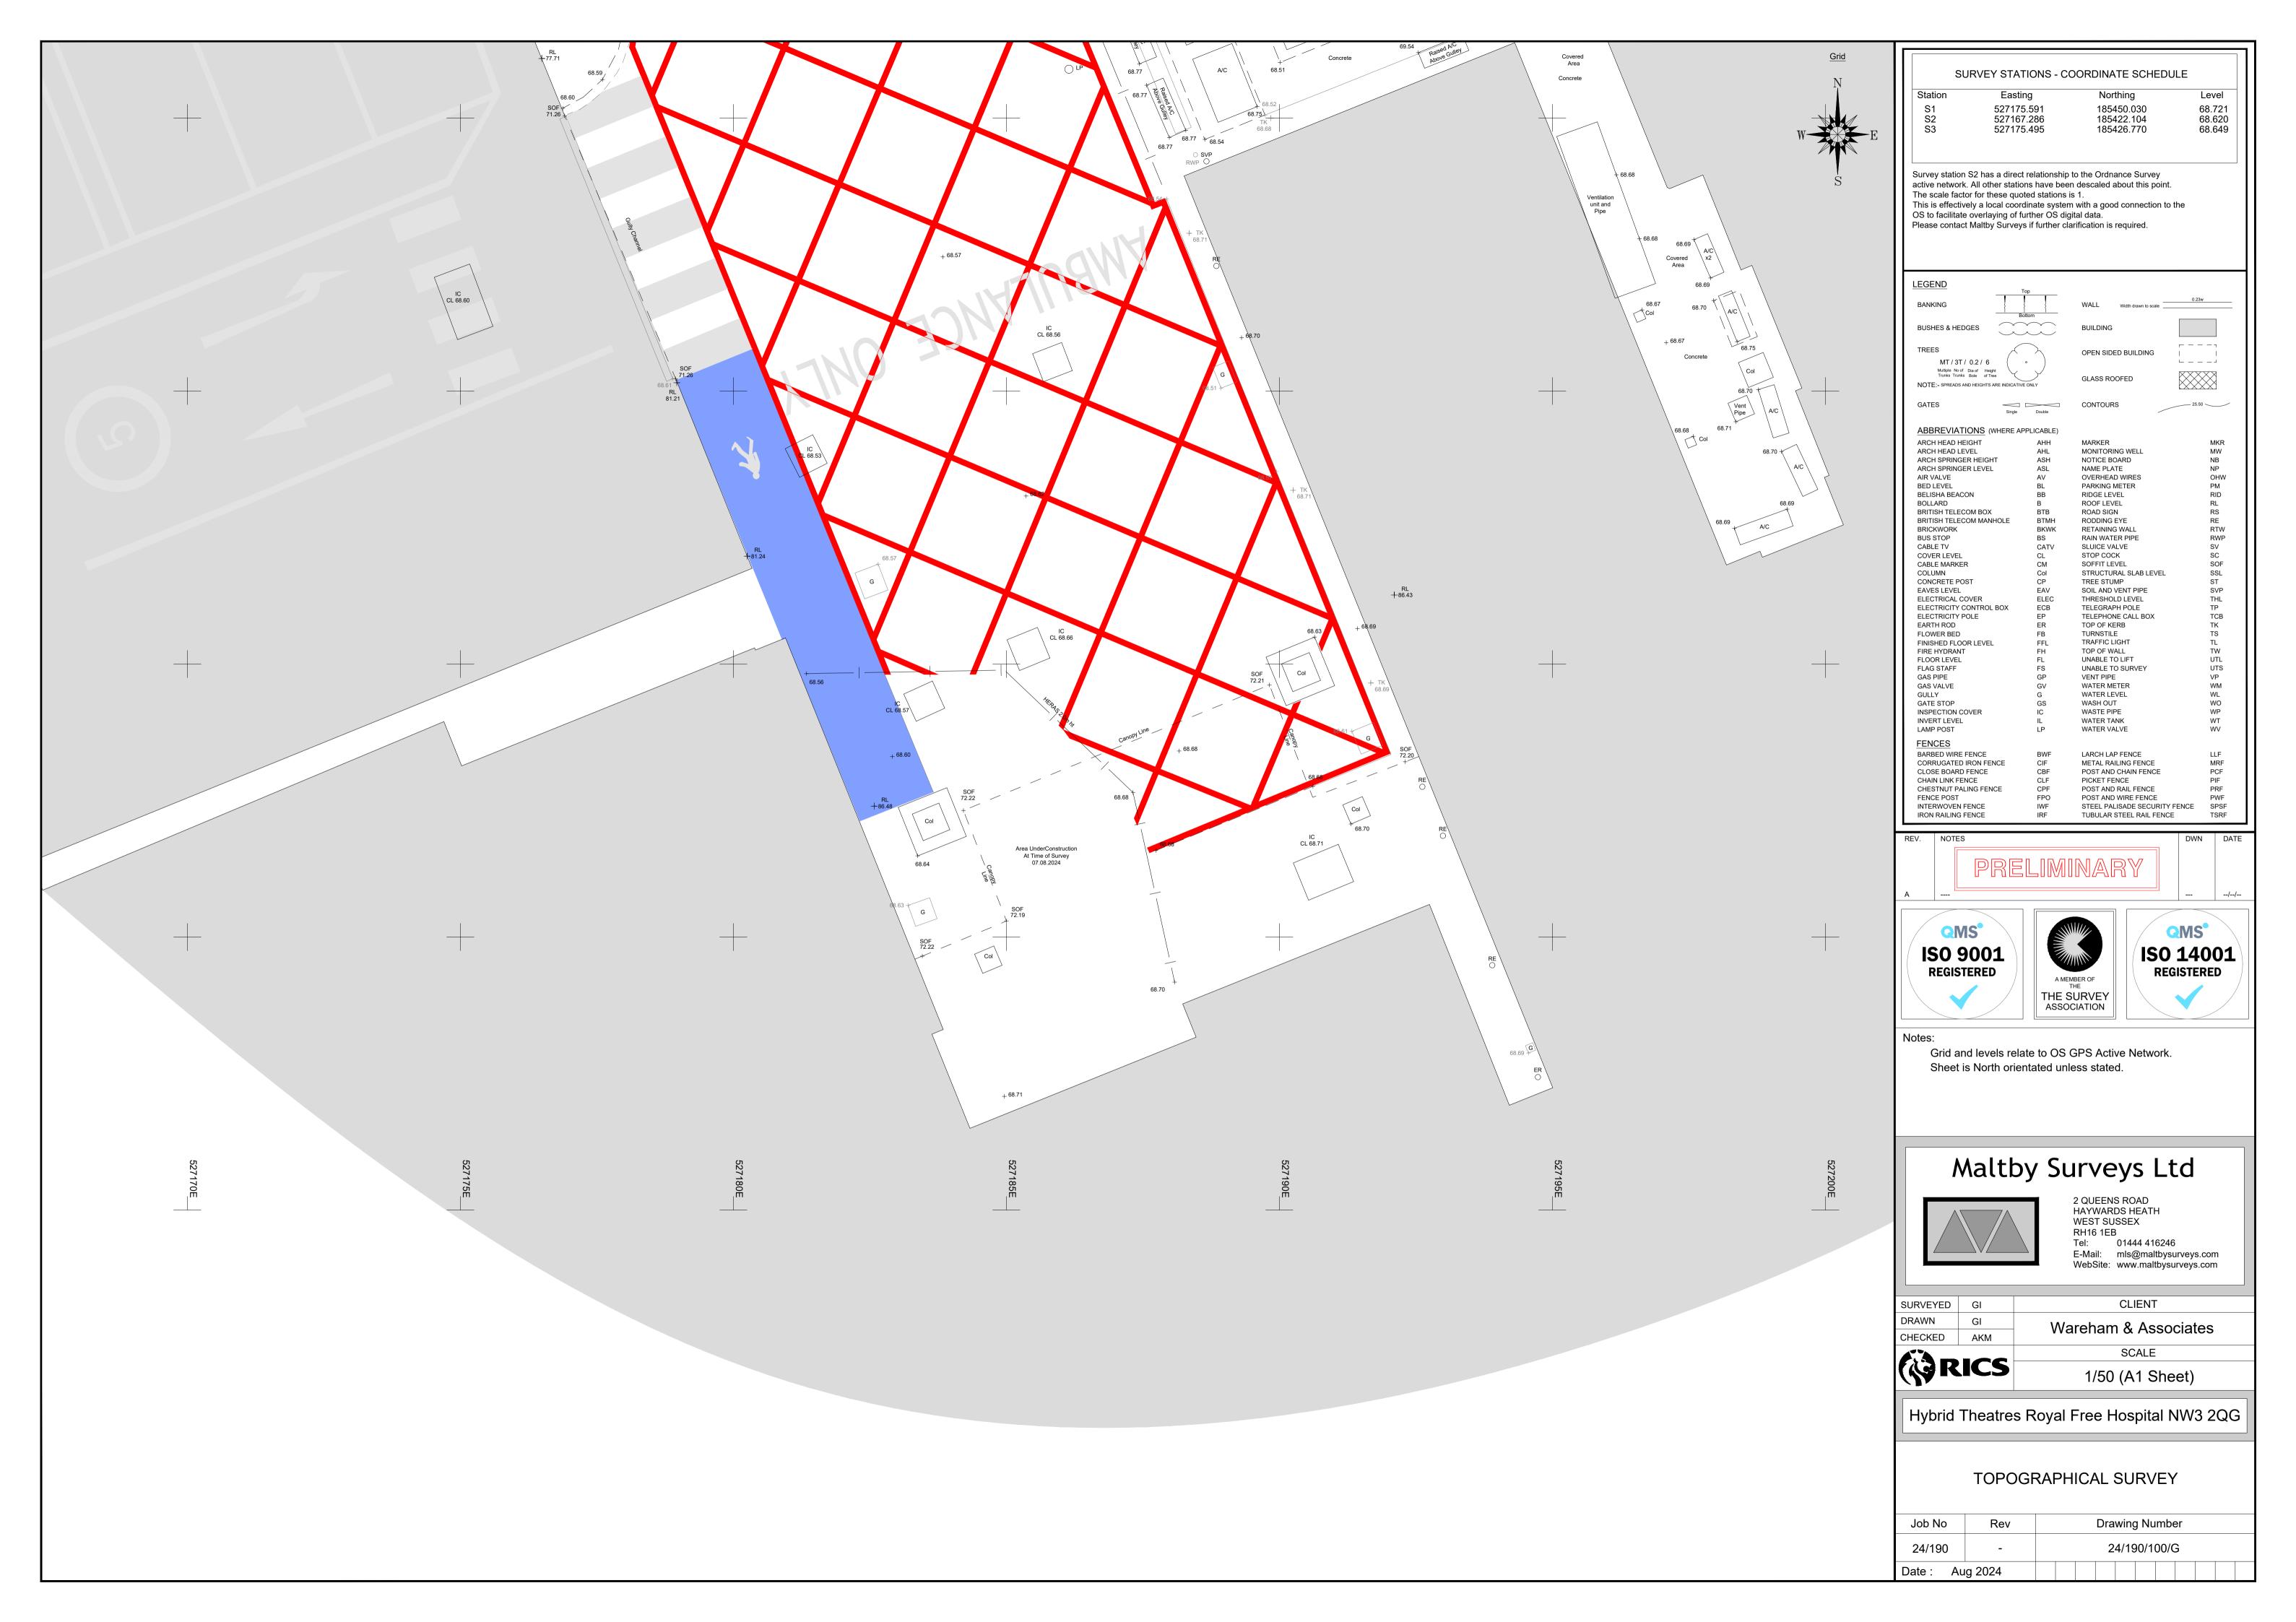

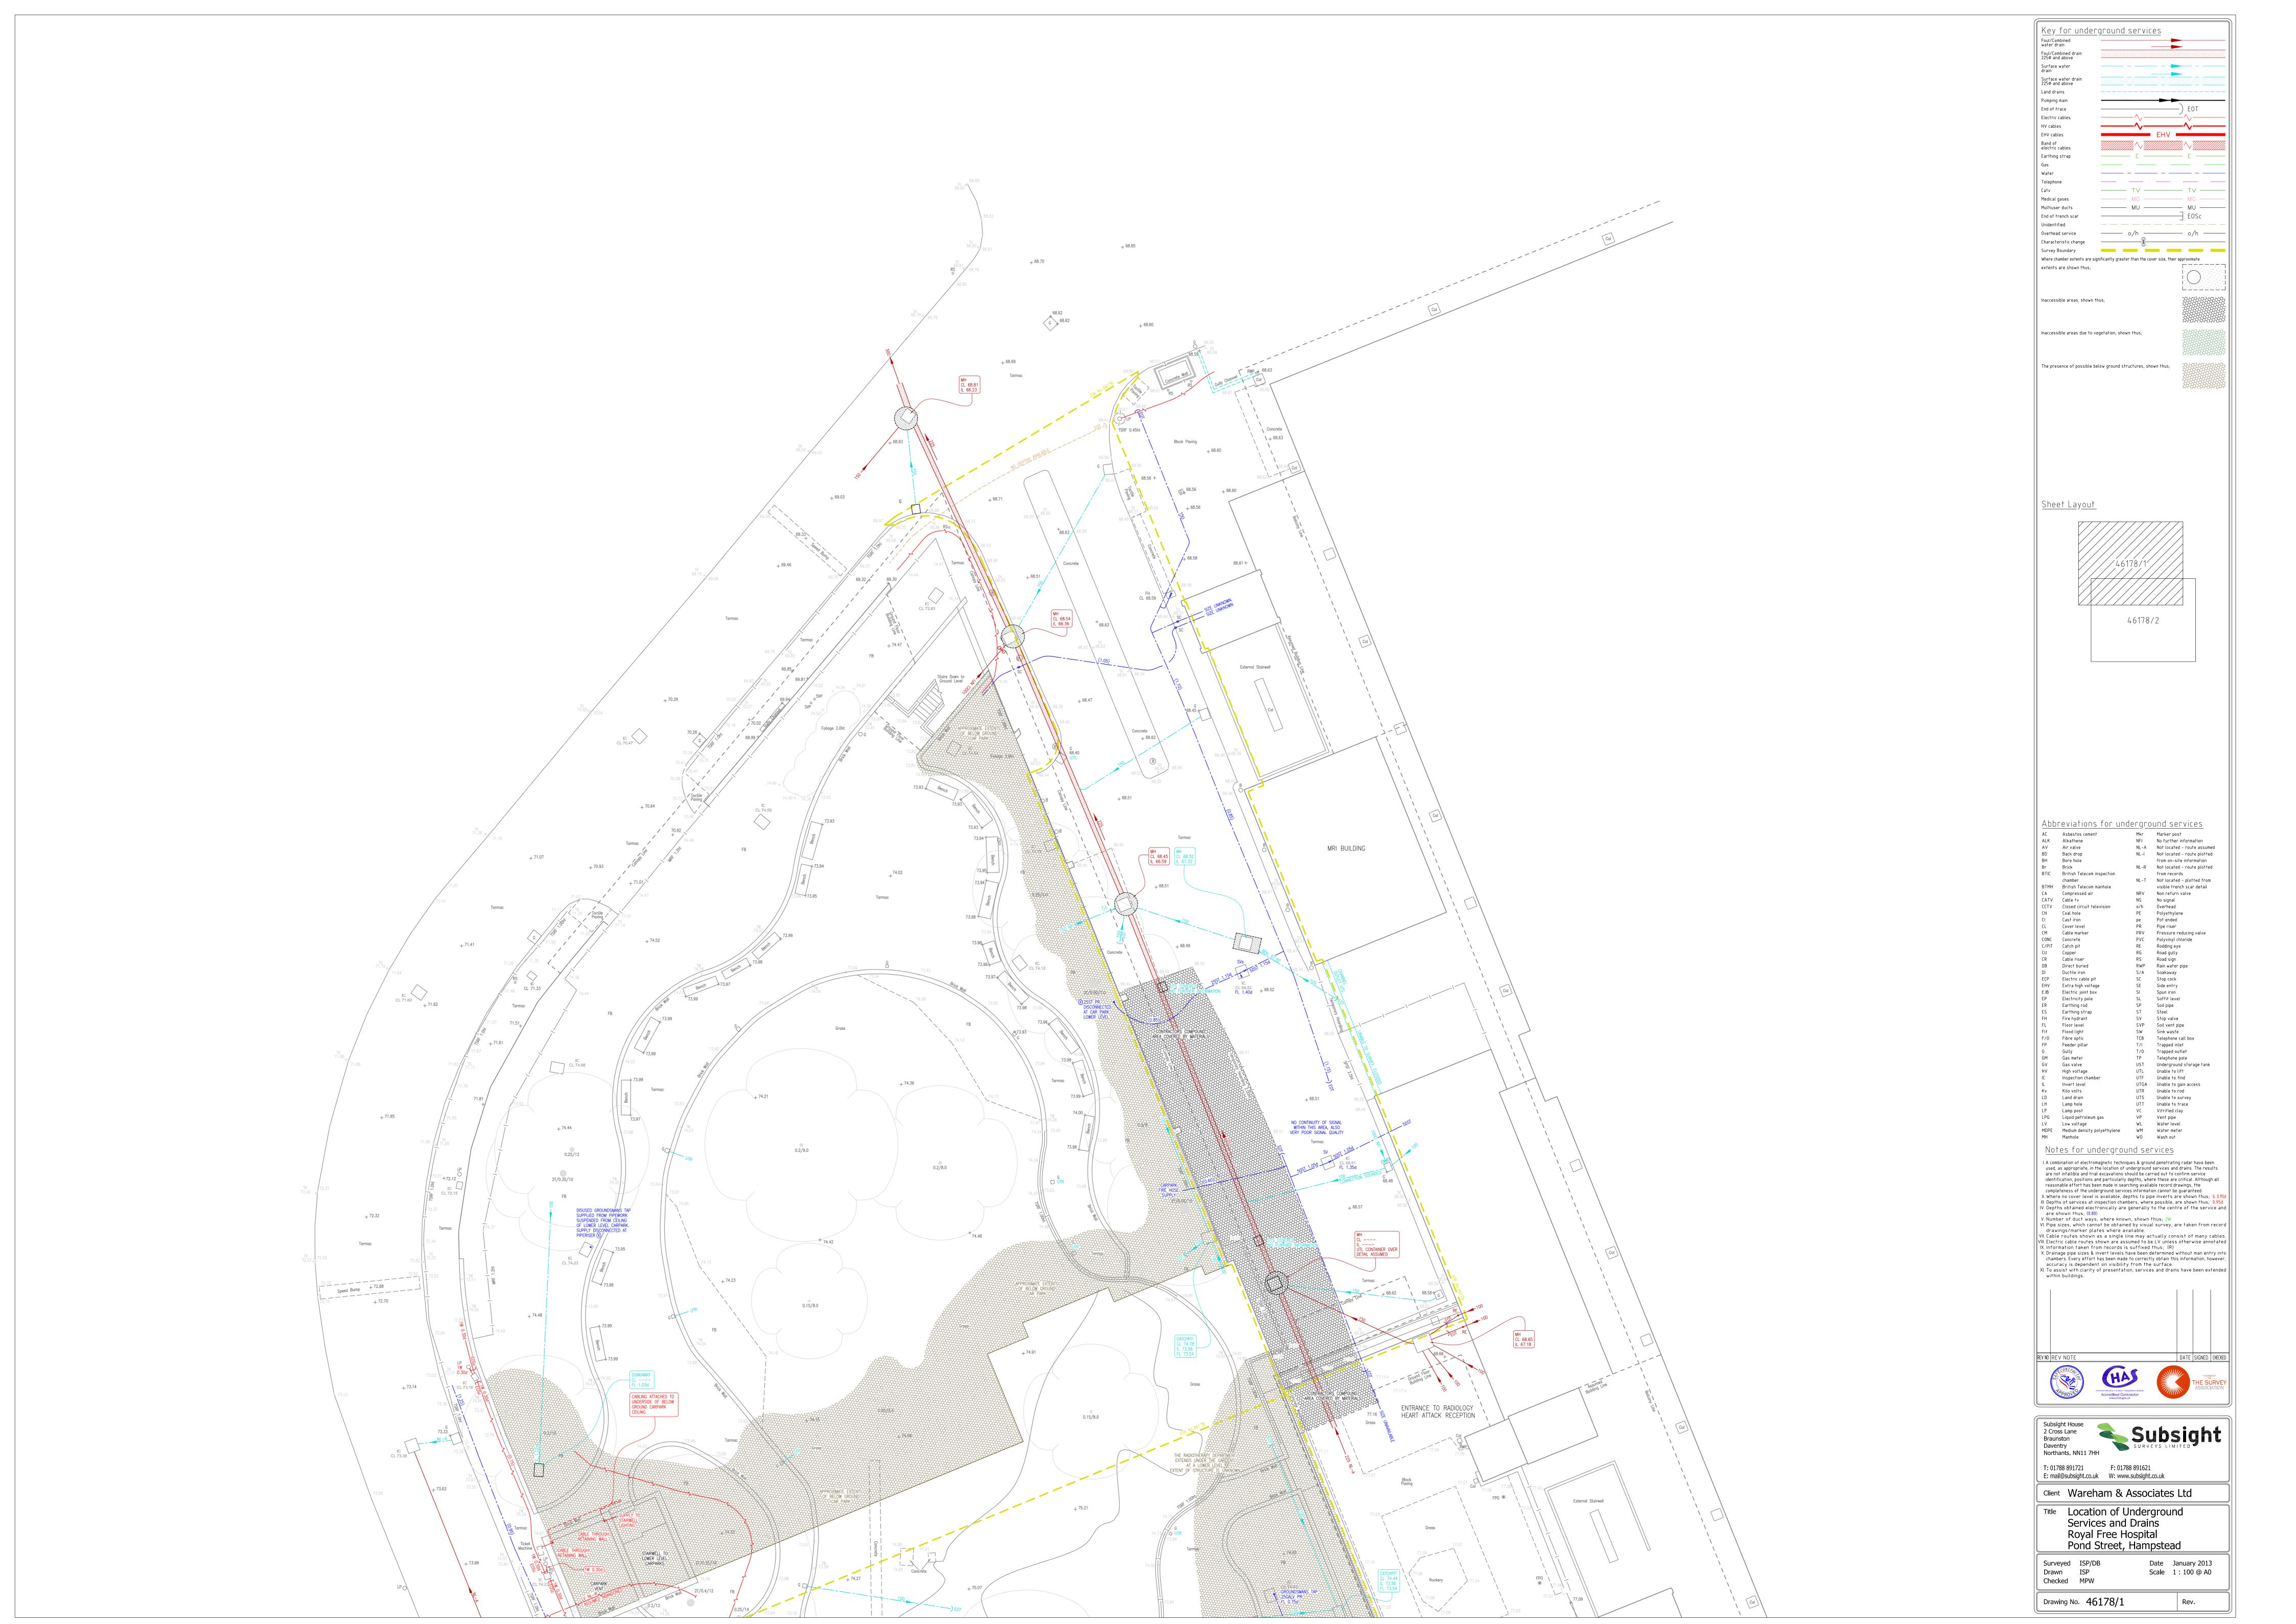

APPENDIX C -THAMES WATER ASSET LOCATION SEARC
Thames Water Asset Location Search (201



Thames Water Property Searches 12 Vastern Road READING RG1 8DB

Search address supplied Royal Free Hampstead Nhs Trust

Royal Free Hospital

Pond Street London NW3 2QG

Your reference 46178

Our reference ALS/ALS Standard/2013_2392815

Search date 21 January 2013

You are now able to order your Asset Location Search requests online by visiting www.thameswater-propertysearches.co.uk



Thames Water Utilities Ltd

Property Searches PO Box 3189 Slough SL1 4WW

DX 151280 Slough 13

T 0845 070 9148

E searches@thameswater.co.uk
I www.thameswaterpropertysearches.co.uk



Search address supplied: Royal Free Hampstead Nhs Trust, Royal Free Hospital, Pond Street, London, NW3 2QG

Dear Sir / Madam

An Asset Location Search is recommended when undertaking a site development. It is essential to obtain information on the size and location of clean water and sewerage assets to safeguard against expensive damage and allow cost-effective service design.

The following records were searched in compiling this report: - the map of public sewers & the map of waterworks. Thames Water Utilities Ltd (TWUL) holds all of these.

This search provides maps showing the position, size of Thames Water assets close to the proposed development and also manhole cover and invert levels, where available.

Please note that none of the charges made for this report relate to the provision of Ordnance Survey mapping information. The replies contained in this letter are given following inspection of the public service records available to this company. No responsibility can be accepted for any error or omission in the replies.

You should be aware that the information contained on these plans is current only on the day that the plans are issued. The plans should only be used for the duration of the work that is being carried out at the present time. Under no circumstances should this data be copied or transmitted to parties other than those for whom the current work is being carried out.

Thames Water do update these service plans on a regular basis and failure to observe the above conditions could lead to damage arising to new or diverted services at a later date.

Contact Us

If you have any further queries regarding this enquiry please feel free to contact a member of the team on 0845 070 9148, or use the address below:

Thames Water Utilities Ltd Property Searches PO Box 3189 Slough SL1 4WW

Email: searches@thameswater.co.uk

Web: <u>www.thameswater-propertysearches.co.uk</u>

Thames Water Utilities Ltd

Property Searches PO Box 3189 Slough SL1 4WW

DX 151280 Slough 13

T 0845 070 9148

E searches@thameswater.co.uk
I www.thameswaterpropertysearches.co.uk



Waste Water Services

Please provide a copy extract from the public sewer map.

Enclosed is a map showing the approximate lines of our sewers. Our plans do not show sewer connections from individual properties or any sewers not owned by Thames Water unless specifically annotated otherwise. Records such as "private" pipework are in some cases available from the Building Control Department of the relevant Local Authority.

Where the Local Authority does not hold such plans it might be advisable to consult the property deeds for the site or contact neighbouring landowners.

This report relates only to sewerage apparatus of Thames Water Utilities Ltd, it does not disclose details of cables and or communications equipment that may be running through or around such apparatus.

The sewer level information contained in this response represents all of the level data available in our existing records. Should you require any further Information, please refer to the relevant section within the 'Further Contacts' page found later in this document.

For your guidance:

- The Company is not generally responsible for rivers, watercourses, ponds, culverts or highway drains. If any of these are shown on the copy extract they are shown for information only.
- Any private sewers or lateral drains which are indicated on the extract
 of the public sewer map as being subject to an agreement under
 Section 104 of the Water Industry Act 1991 are not an 'as constructed'
 record. It is recommended these details be checked with the developer.

Clean Water Services

Please provide a copy extract from the public water main map.

Enclosed is a map showing the approximate positions of our water mains and associated apparatus. Please note that records are not kept of the positions of individual domestic supplies.

For your information, there will be a pressure of at least 10m head at the outside stop valve. If you would like to know the static pressure, please contact our Customer Centre on 0845 920 0800. The Customer Centre can

Thames Water Utilities Ltd

Property Searches PO Box 3189 Slough SL1 4WW

DX 151280 Slough 13

T 0845 070 9148

E searches@thameswater.co.uk
www.thameswaterpropertysearches.co.uk



also arrange for a full flow and pressure test to be carried out for a fee.

For your guidance:

- Assets other than vested water mains may be shown on the plan, for information only.
- If an extract of the public water main record is enclosed, this will show known public water mains in the vicinity of the property. It should be possible to estimate the likely length and route of any private water supply pipe connecting the property to the public water network.

Payment for this Search

A charge will be added to your suppliers account.

Thames Water Utilities Ltd

Property Searches PO Box 3189 Slough SL1 4WW

DX 151280 Slough 13

T 0845 070 9148

E searches@thameswater.co.uk
www.thameswaterpropertysearches.co.uk



Further contacts:

Waste Water queries

Should you require verification of the invert levels of public sewers, by site measurement, you will need to approach the relevant Thames Water Area Network Office for permission to lift the appropriate covers. This permission will usually involve you completing a TWOSA form. For further information please contact our Customer Centre on Tel: 0845 920 0800. Alternatively, a survey can be arranged, for a fee, through our Customer Centre on the above number.

If you have any questions regarding sewer connections, building over issues or any other questions regarding operational issues please direct them to our service desk. Which can be contacted by writing to:

Developer Services (Waste Water)
Thames Water
Clearwater Court
Vastern Road
Reading
RG1 8DB

Tel: 0845 850 2777

Email: developer.services@thameswater.co.uk

Should you require any further information regarding budget estimates, diversions or stopping up notices then please contact:

DevCon Team Asset Investment Thames Water Maple Lodge STW Denham Way Rickmansworth Hertfordshire WD3 9SQ

Tel: 01923 898 072

Email: devcon.team@thameswater.co.uk

Thames Water Utilities Ltd

Property Searches PO Box 3189 Slough SL1 4WW

DX 151280 Slough 13

T 0845 070 9148

E searches@thameswater.co.uk
www.thameswaterpropertysearches.co.uk



Clean Water queries

Should you require any advice concerning clean water operational issues or clean water connections, please contact:

Developer Services (Clean Water) Thames Water Clearwater Court Vastern Road Reading RG1 8DB

Tel: 0845 850 2777

Email: developer.services@thameswater.co.uk


Thames Water Utilities Ltd

Property Searches PO Box 3189 Slough SL1 4WW

DX 151280 Slough 13

T 0845 070 9148

E searches@thameswater.co.uk
I www.thameswaterpropertysearches.co.uk

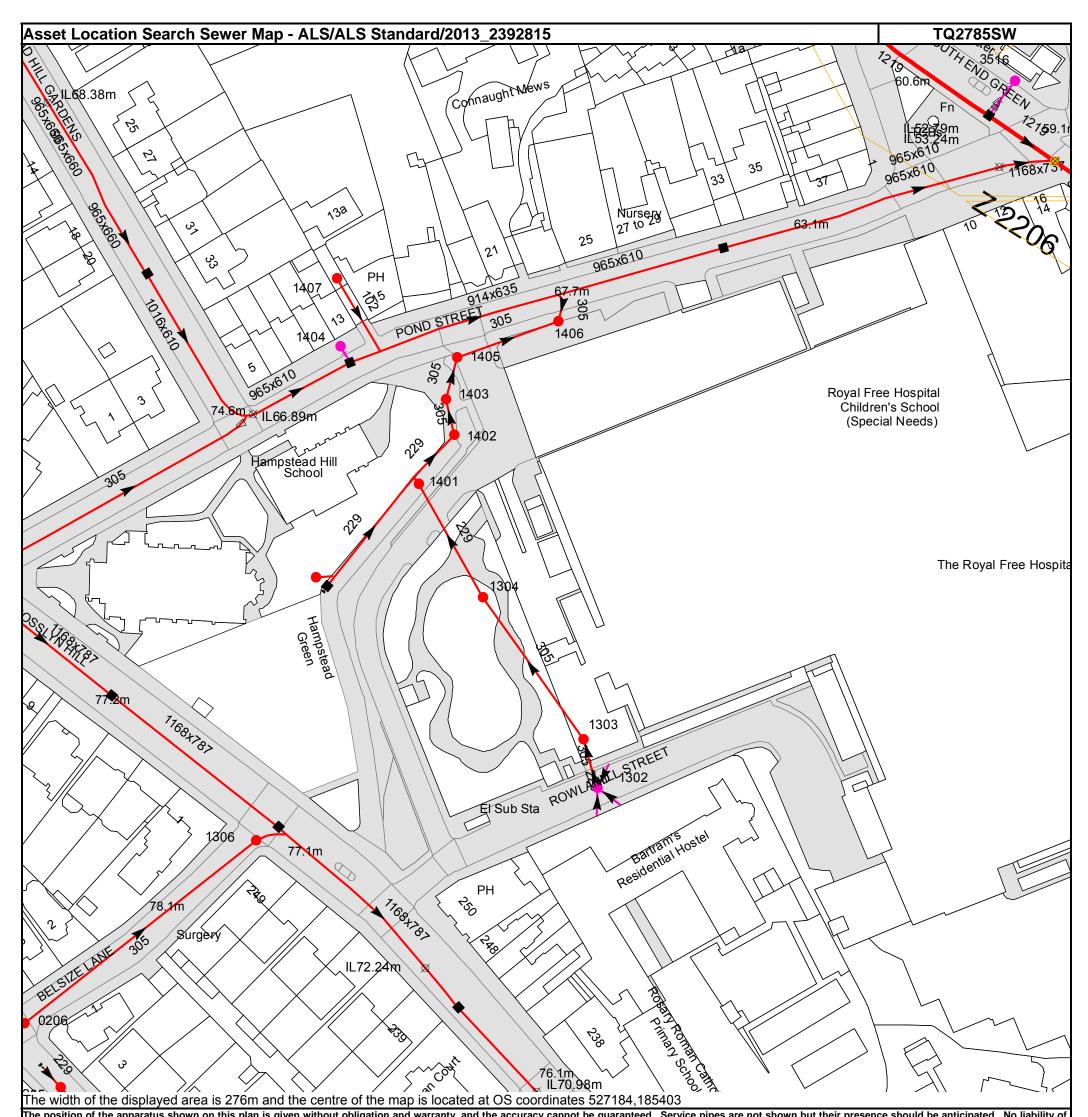

The position of the apparatus shown on this plan is given without obligation and warranty, and the accuracy cannot be guaranteed. Service pipes are not shown but their presence should be anticipated. No liability of any kind whatsoever is accepted by Thames Water for any error or omission. The actual position of mains and services must be verified and established on site before any works are undertaken.


Based on the Ordnance Survey Map with the Sanction of the controller of H.M. Stationery Office, License no. WU298557 Crown Copyright Reserved.

Manhole Reference	Manhole Cover Level	Manhole Invert Level
3516	58.97	53.07
1304	69.76	66.92
1415	n/a	n/a
1401	70.55	64.57
1402	n/a	63.21
1403	n/a	63.14
1405	n/a	63.07
1404	n/a	n/a
1406	n/a	62.88
1407	70.52	68.66
0206	n/a	n/a
0205	77.44	74.61
1306	n/a	n/a
1303	73.65	68.84
-	-	-
1302	74.88	69.98

The position of the apparatus shown on this plan is given without obligation and warranty, and the accuracy cannot be guaranteed. Service pipes are not shown but their presence should be anticipated. No liability of any kind whatsoever is accepted by Thames Water for any error or omission. The actual position of mains and services must be verified and established on site before any works are undertaken.



Public Sewer Types (Operated & Maintained by Thames Water)

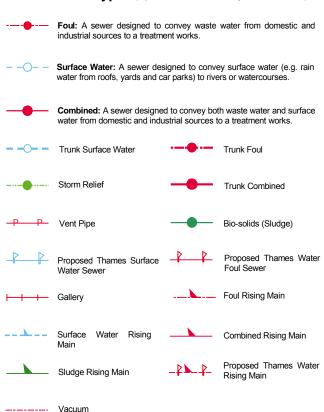

Sewer Fittings

A feature in a sewer that does not affect the flow in the pipe. Example: a vent is a fitting as the function of a vent is to release excess gas.

Air Valve

Dam Chase

Fitting

≥ Meter

♦ Vent Column

Operational Controls

A feature in a sewer that changes or diverts the flow in the sewer. Example: A hydrobrake limits the flow passing downstream.

Control Valve

Drop Pipe
Ancillary

✓ Weir

End Items

End symbols appear at the start or end of a sewer pipe. Examples: an Undefined End at the start of a sewer indicates that Thames Water has no knowledge of the position of the sewer upstream of that symbol, Outfall on a surface water sewer indicates that the pipe discharges into a stream or river.

Outfall

Undefined End

Inlet

Notes:

- 1) All levels associated with the plans are to Ordnance Datum Newlyn.
- 2) All measurements on the plans are metric.
- 3) Arrows (on gravity fed sewers) or flecks (on rising mains) indicate direction of flow.
- Most private pipes are not shown on our plans, as in the past, this information has not been recorded.
- 5) 'na' or '0' on a manhole level indicates that data is unavailable.

6) The text appearing alongside a sewer line indicates the internal diameter of the pipe in millimetres. Text next to a manhole indicates the manhole reference number and should not be taken as a measurement. If you are unsure about any text or symbology present on the plan, please contact a member of Property Insight on 0845 070 9148.

Other Symbols

Symbols used on maps which do not fall under other general categories

▲ / ▲ Public/Private Pumping Station

Change of characteristic indicator (C.O.C.I.)

Summit

Areas

Lines denoting areas of underground surveys, etc.

Agreement


Operational Site


Chamber

Tunnel

Conduit Bridge


Other Sewer Types (Not Operated or Maintained by Thames Water)

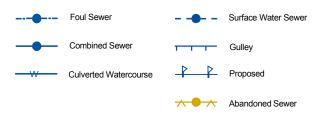

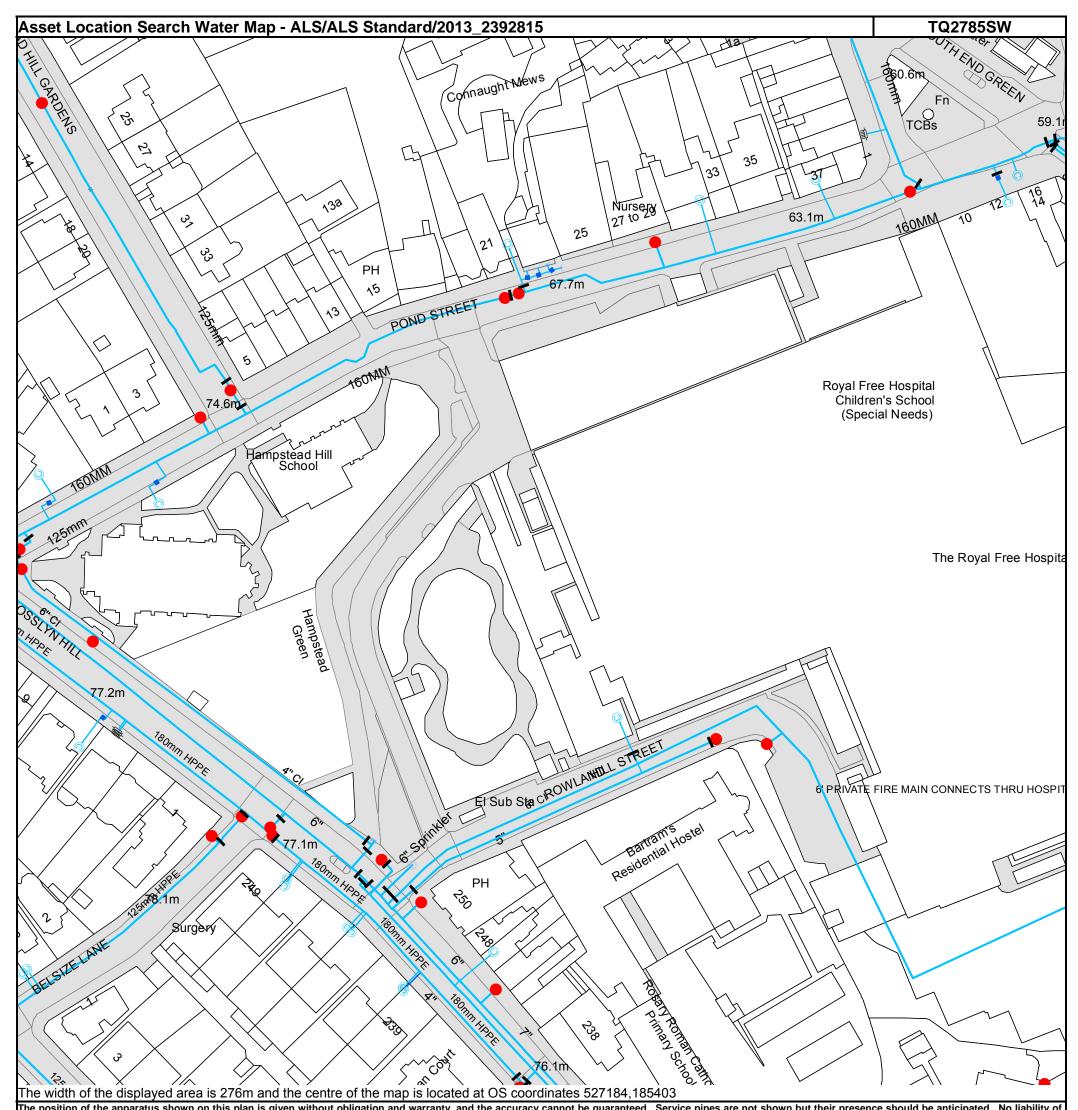

The position of the apparatus shown on this plan is given without obligation and warranty, and the accuracy cannot be guaranteed. Service pipes are not shown but their presence should be anticipated. No liability of any kind whatsoever is accepted by Thames Water for any error or omission. The actual position of mains and services must be verified and established on site before any works are undertaken.

Based on the Ordnance Survey Map with the Sanction of the controller of H.M. Stationery Office, License no. WU298557 Crown Copyright Reserved.

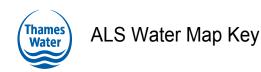

3" SUPPLY

3" FIRE

3" METERED

Water Pipes (Operated & Maintained by Thames Water)

Distribution Main: The most common pipe shown on water maps. With few exceptions, domestic connections are only made to distribution mains.

Trunk Main: A main carrying water from a source of supply to a treatment plant or reservoir, or from one treatment plant or reservoir to another. Also a main transferring water in bulk to smaller water mains used for supplying individual customers.

Supply Main: A supply main indicates that the water main is used as a supply for a single property or group of properties.

Fire Main: Where a pipe is used as a fire supply, the word FIRE will be displayed along the pipe.

Metered Pipe: A metered main indicates that the pipe in question supplies water for a single property or group of properties and that quantity of water passing through the pipe is metered even though there may be no meter symbol shown.

Transmission Tunnel: A very large diameter water pipe. Most tunnels are buried very deep underground. These pipes are not expected to affect the structural integrity of buildings shown on the map provided.

Proposed Main: A main that is still in the planning stages or in the process of being laid. More details of the proposed main and its reference number are generally included near the main.

PIPE DIAMETER	DEPTH BELOW GROUND			
Up to 300mm (12")	900mm (3')			
300mm - 600mm (12" - 24")	1100mm (3' 8")			
600mm and bigger (24" plus)	1200mm (4')			

Valves Operational Sites General PurposeValve **Booster Station** Air Valve Other Pressure ControlValve Other (Proposed) Customer Valve **Pumping Station** Service Reservoir **Hydrants Shaft Inspection** Single Hydrant Treatment Works Meters Unknown Meter Water Tower **End Items** Other Symbols Symbol indicating what happens at the end of a water main. Data Logger

Other Water Pipes (Not Operated or Maintained by Thames Water) Other Water Company Main: Occasionally other water company water pipes may overlap the border of our clean water coverage area. These mains are denoted in purple and in most cases have the owner of the pipe displayed along them.

Private Main: Indiates that the water main in question is not owned by Thames Water. These mains normally have text associated with them indicating the diameter and owner of the pipe.

Blank Flange

Capped End

Emptying Pit

Manifold

Fire Supply

Undefined End

Customer Supply



Search Code

IMPORTANT CONSUMER PROTECTION INFORMATION

This search has been produced by Thames Water Property Searches, Clearwater Court, Vastern Road, Reading RG1 8DB, which is registered with the Property Codes Compliance Board (PCCB) as a subscriber to the Search Code. The PCCB independently monitors how registered search firms maintain compliance with the Code.

The Search Code:

- provides protection for homebuyers, sellers, estate agents, conveyancers and mortgage lenders who
 rely on the information included in property search reports undertaken by subscribers on residential
 and commercial property within the United Kingdom
- · sets out minimum standards which firms compiling and selling search reports have to meet
- promotes the best practise and quality standards within the industry for the benefit of consumers and property professionals
- enables consumers and property professionals to have confidence in firms which subscribe to the code, their products and services.

By giving you this information, the search firm is confirming that they keep to the principles of the Code. This provides important protection for you.

The Code's core principles

Firms which subscribe to the Search Code will:

- display the Search Code logo prominently on their search reports
- · act with integrity and carry out work with due skill, care and diligence
- at all times maintain adequate and appropriate insurance to protect consumers
- conduct business in an honest, fair and professional manner
- handle complaints speedily and fairly
- ensure that products and services comply with industry registration rules and standards and relevant laws
- monitor their compliance with the Code

Complaints

If you have a query or complaint about your search, you should raise it directly with the search firm, and if appropriate ask for any complaint to be considered under their formal internal complaints procedure. If you remain dissatisfied with the firm's final response, after your complaint has been formally considered, or if the firm has exceeded the response timescales, you may refer your complaint for consideration under The Property Ombudsman scheme (TPOs). The Ombudsman can award compensation of up to £5,000 to you if he finds that you have suffered actual loss as a result of your search provider failing to keep to the Code.

Please note that all queries or complaints regarding your search should be directed to your search provider in the first instance, not to TPOs or to the PCCB.

TPOs Contact Details


The Property Ombudsman scheme Milford House 43-55 Milford Street Salisbury Wiltshire SP1 2BP Tel: 01722 333306

Fax: 01722 332296 Email: admin@tpos.co.uk

You can get more information about the PCCB from www.propertycodes.org.uk

PLEASE ASK YOUR SEARCH PROVIDER IF YOU WOULD LIKE A COPY OF THE SEARCH CODE

APPENDIX D -PLANNING STAGE - PRELIM BELOW GROUND DRAINAGE DESIGN Wareham & Associates Preliminary Drainage Drawings Drawing. No. 201758-WAL-V1-DR-DR-C-0001-Drainage Layout Drawing. No. 201758-WAL-V1-DR-DR-C-0010- Long Section Drawing. No. 201758-WAL-V1-DR-DR-C-0020-Drainage Detail

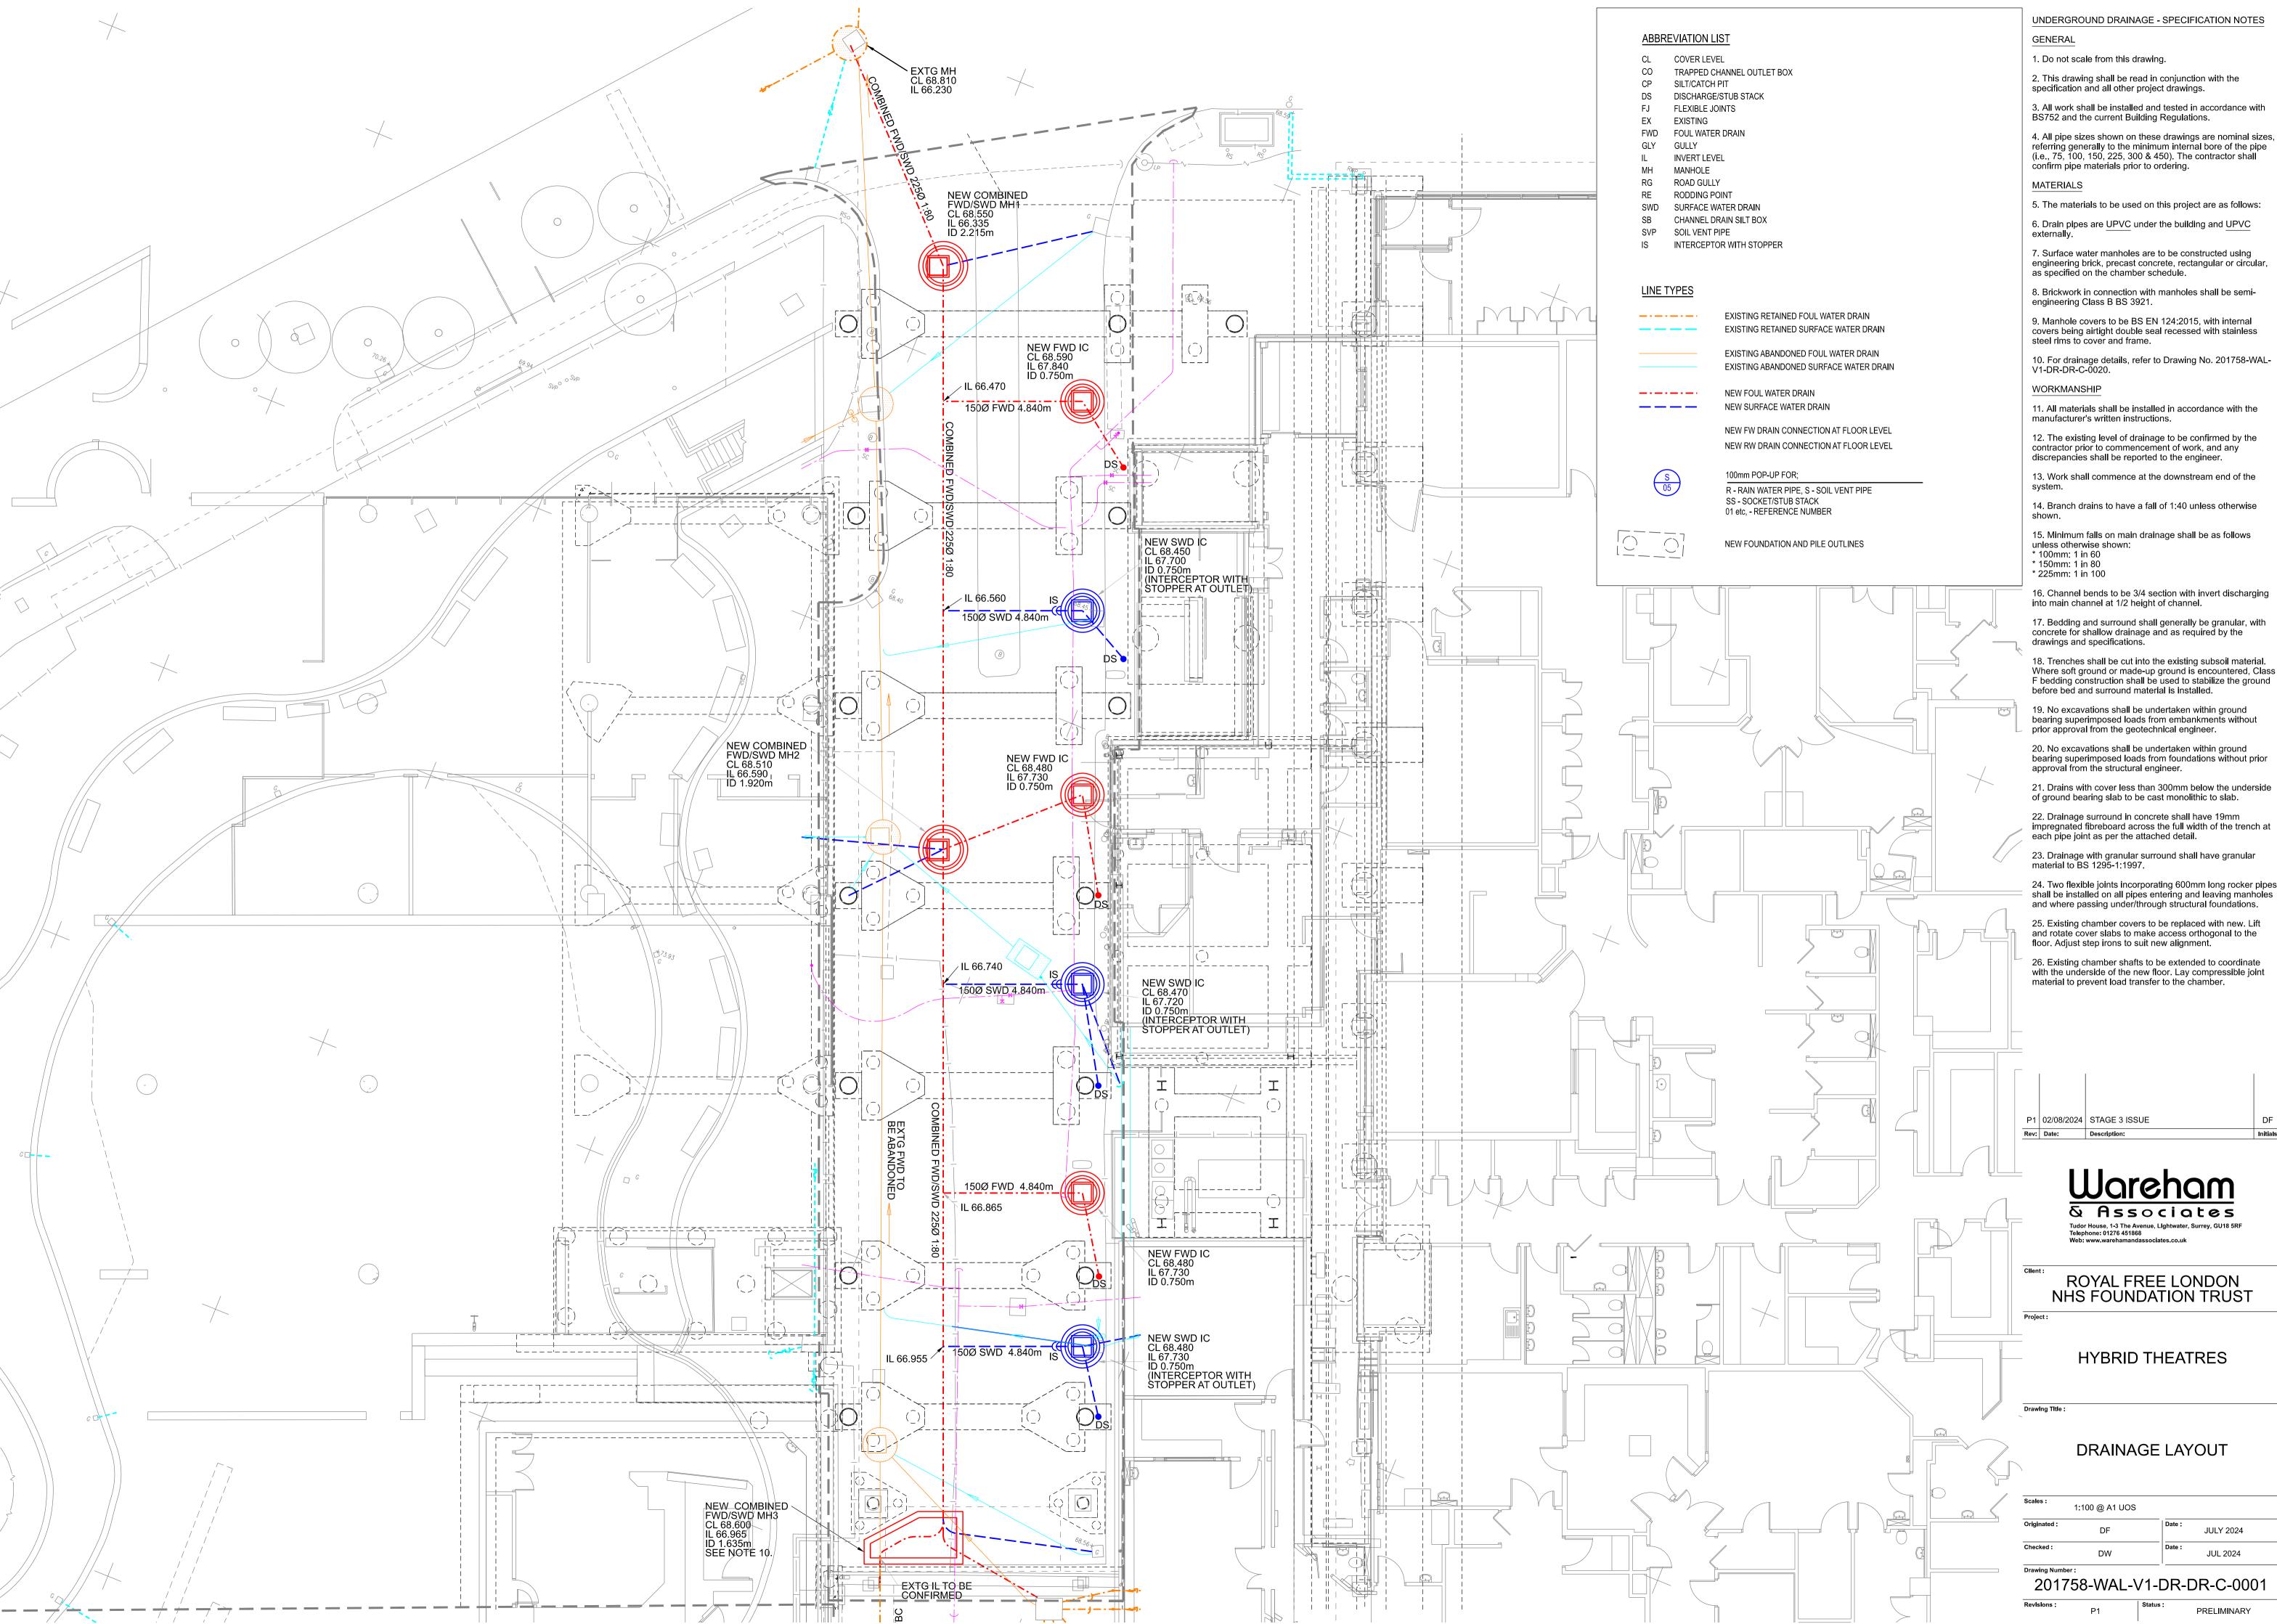

UNDERGROUND DRAINAGE - SPECIFICATION NOTES

3. All work shall be installed and tested in accordance with BS752 and the current Building Regulations.

4. All pipe sizes shown on these drawings are nominal sizes,

5. The materials to be used on this project are as follows:

6. Drain pipes are UPVC under the building and UPVC

8. Brickwork in connection with manholes shall be semi-

9. Manhole covers to be BS EN 124:2015, with internal covers being airtight double seal recessed with stainless

10. For drainage details, refer to Drawing No. 201758-WAL-V1-DR-DR-C-0020.

11. All materials shall be installed in accordance with the

12. The existing level of drainage to be confirmed by the

discrepancies shall be reported to the engineer.

17. Bedding and surround shall generally be granular, with concrete for shallow drainage and as required by the

F bedding construction shall be used to stabilize the ground

prior approval from the geotechnical engineer.

impregnated fibreboard across the full width of the trench at

24. Two flexible joints incorporating 600mm long rocker pipes shall be installed on all pipes entering and leaving manholes and where passing under/through structural foundations.

25. Existing chamber covers to be replaced with new. Lift and rotate cover slabs to make access orthogonal to the floor. Adjust step irons to suit new alignment.


26. Existing chamber shafts to be extended to coordinate with the underside of the new floor. Lay compressible joint material to prevent load transfer to the chamber.


NHS FOUNDATION TRUST


HYBRID THEATRES

DRAINAGE LAYOUT

JULY 2024

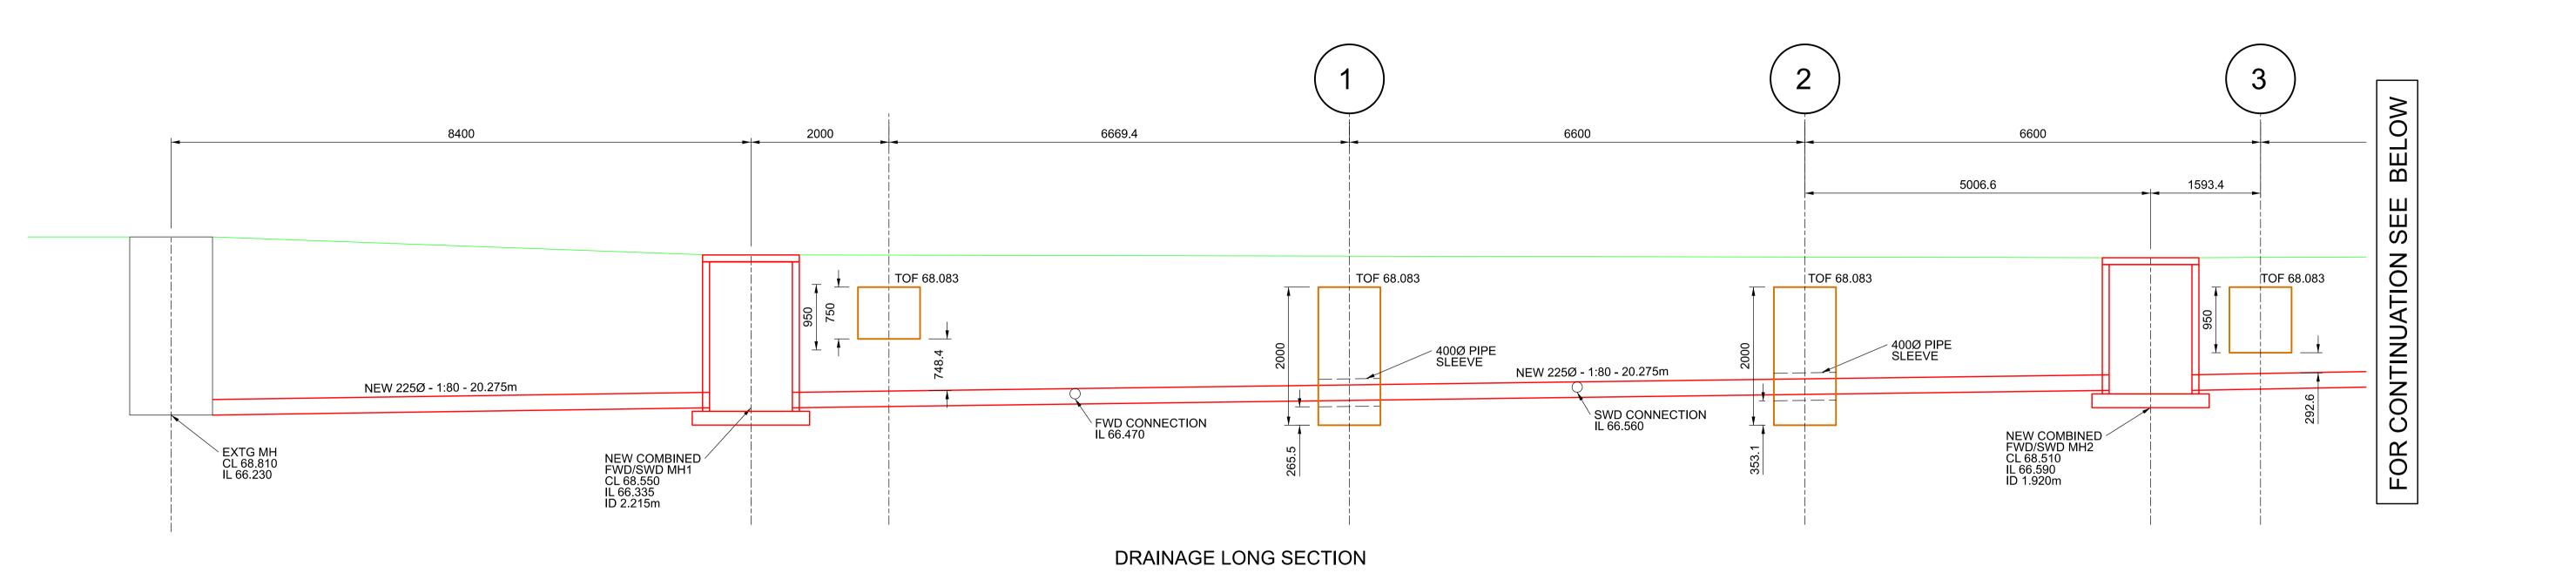

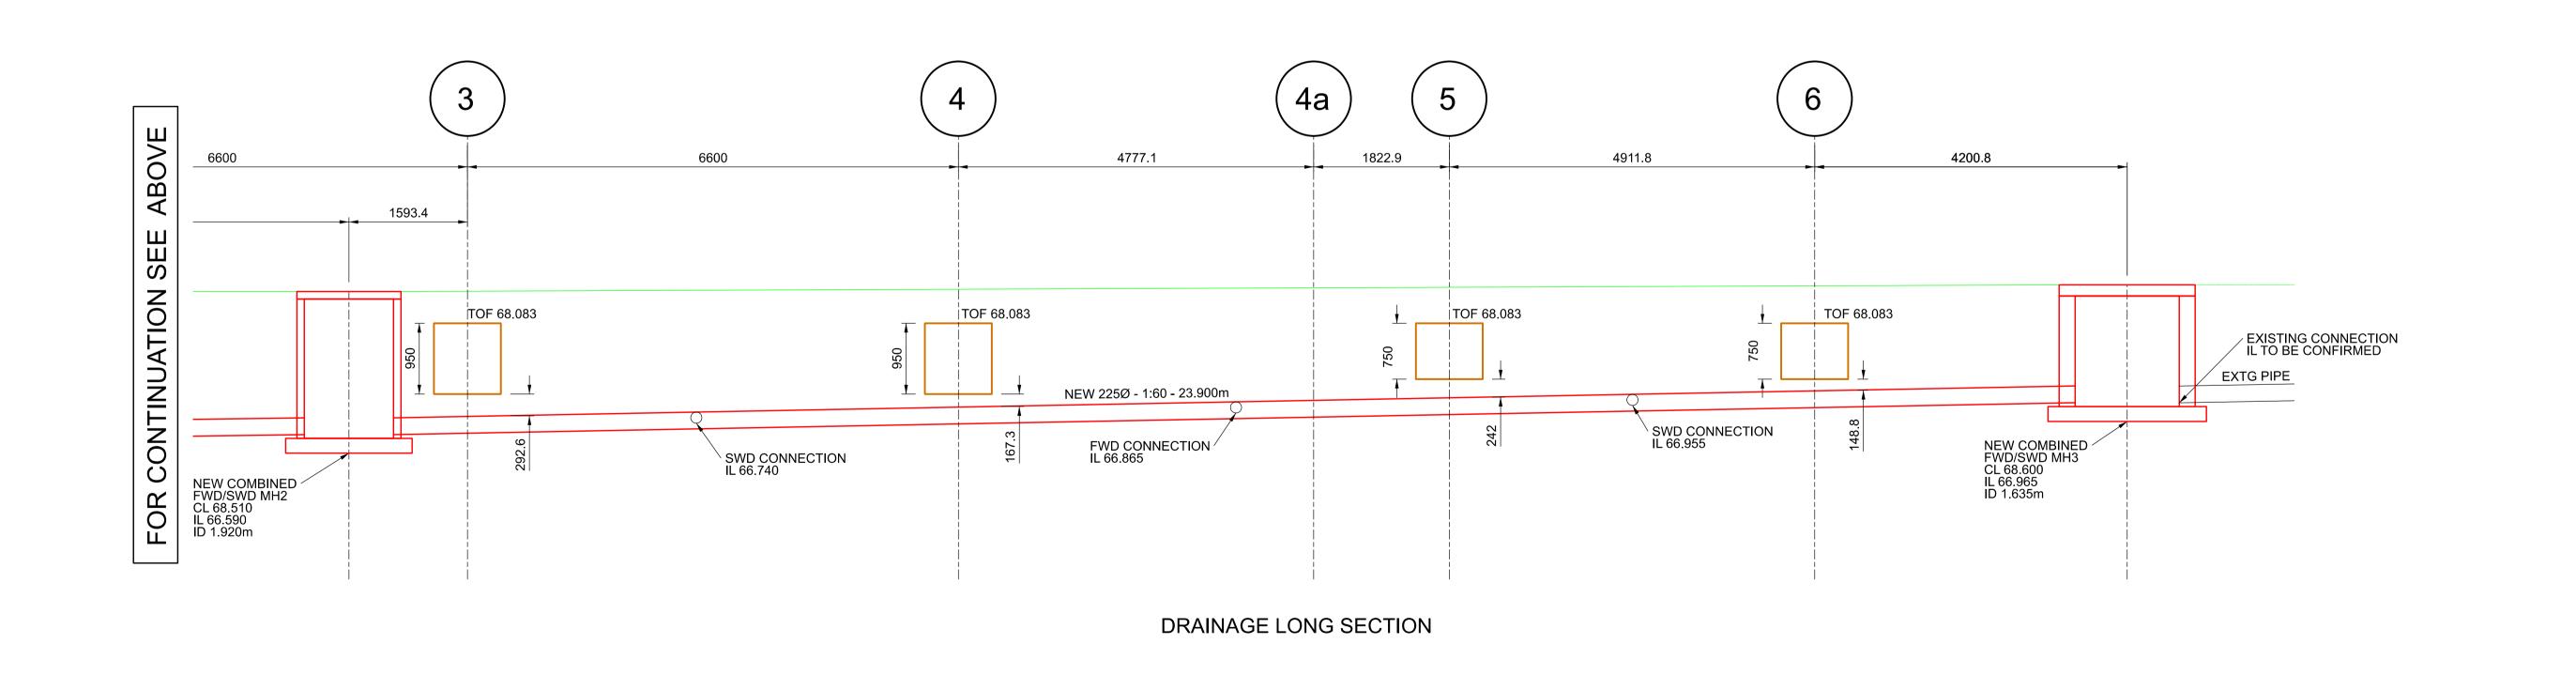

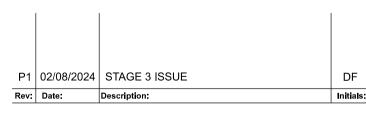






HYBRID THEATRES

Drawing Title :

DRAINAGE LONG SECTION


Scales :	1:50 @ A1 UOS		
Originated :	DF	Date : JULY 2	2024
Checked:	DW	Date : JULY 2	2024

PRELIMINARY

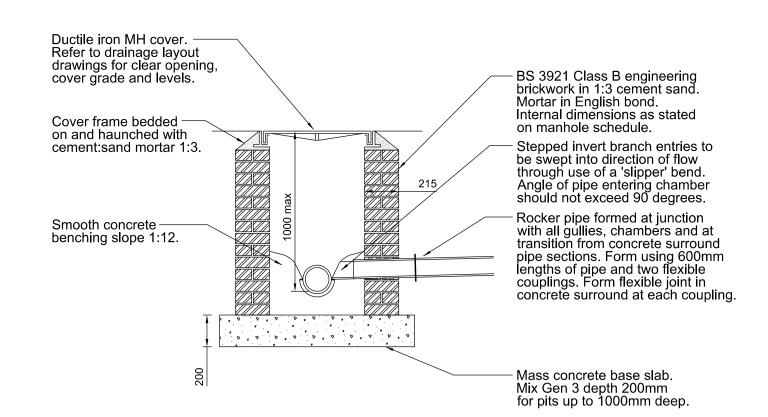


TYPICAL SECTION THROUGH BRICK BUILT SHALLOW INSPECTION CHAMBER (FOR USE ONLY WHERE COVER SIZE MATCHES CHAMBER SIZE)


SCALE: NTS

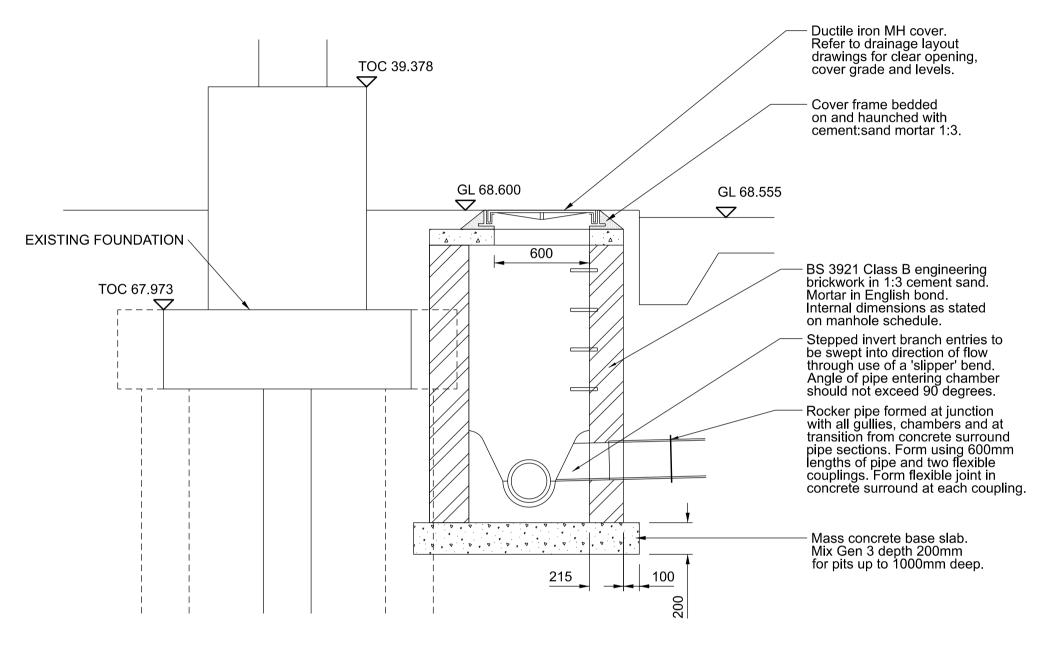


CROSS SECTION DETAIL A - A (SEE DRAWING 201758-WAL-V1-DR-DR-C-0001 FOR LOCATION)

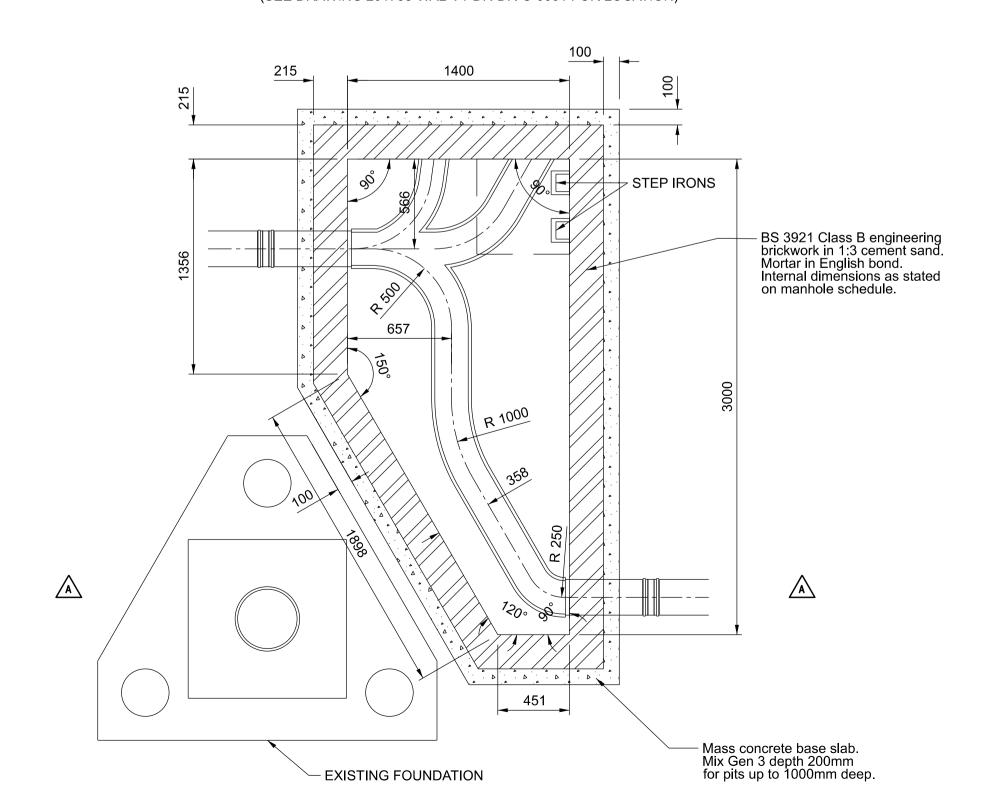



IRREGULAR SHAPED MANHOLE PLAN
(SEE DRAWING 201758-WAL-V1-DR-DR-C-0001 FOR LOCATION)

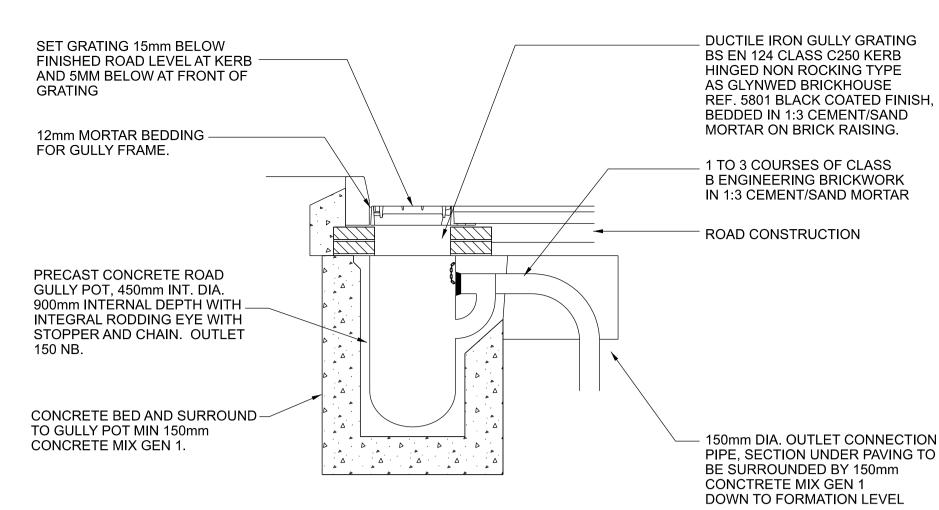

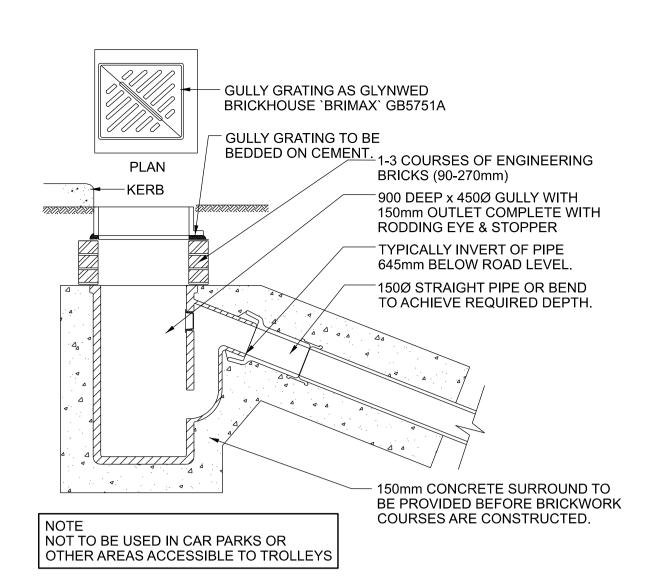


CLAYWARE GULLY IN PEDESTRIAN PAVEMENTS

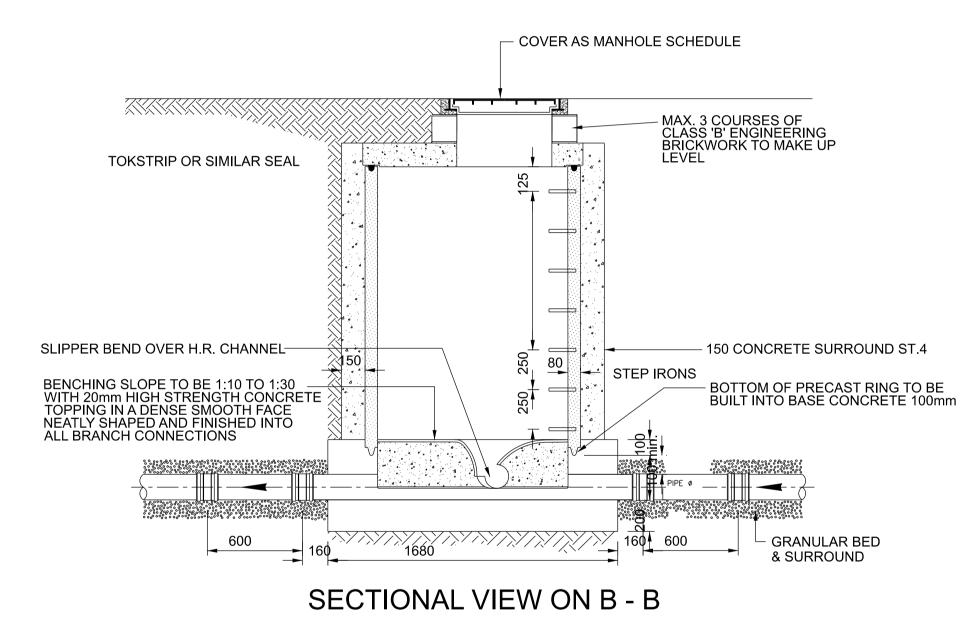


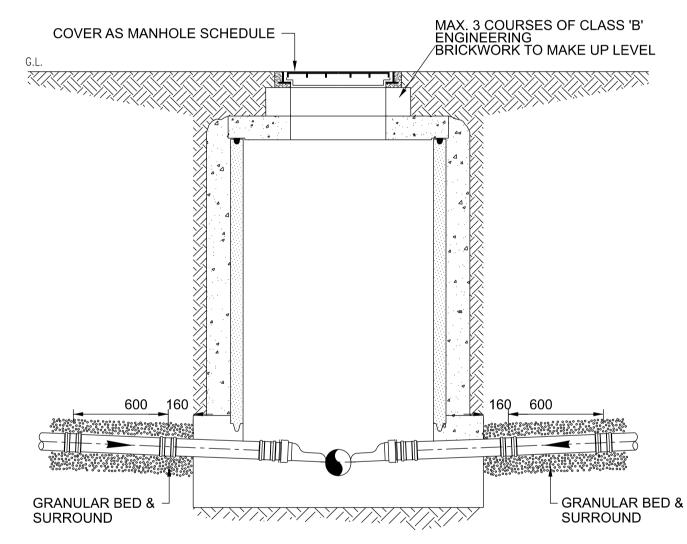

SECTIONAL VIEW ON C - C

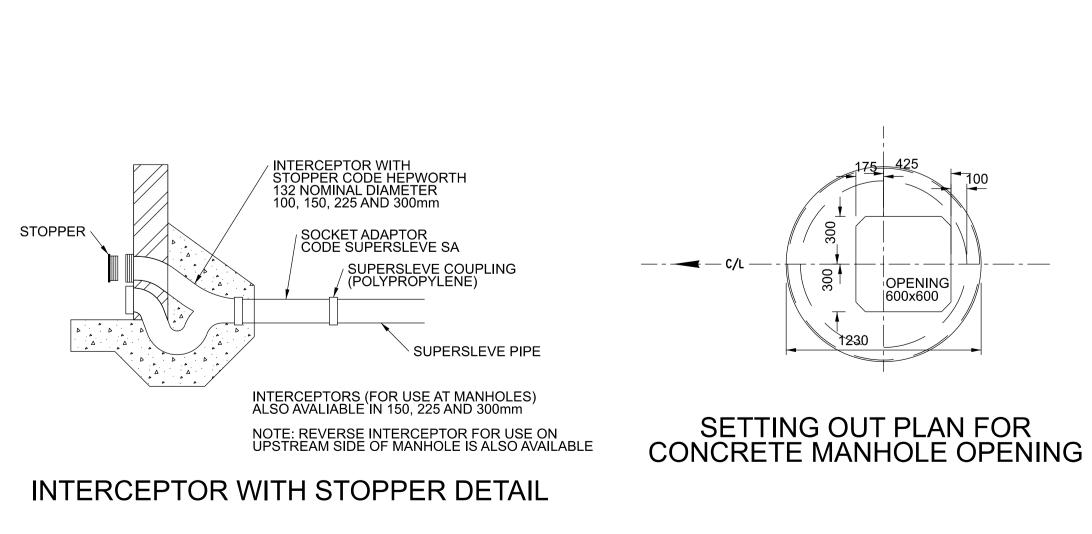

TYPICAL 1200 ID CIRCULAR CONCRETE MANHOLE (MAXIMUM DEPTH 3000mm)

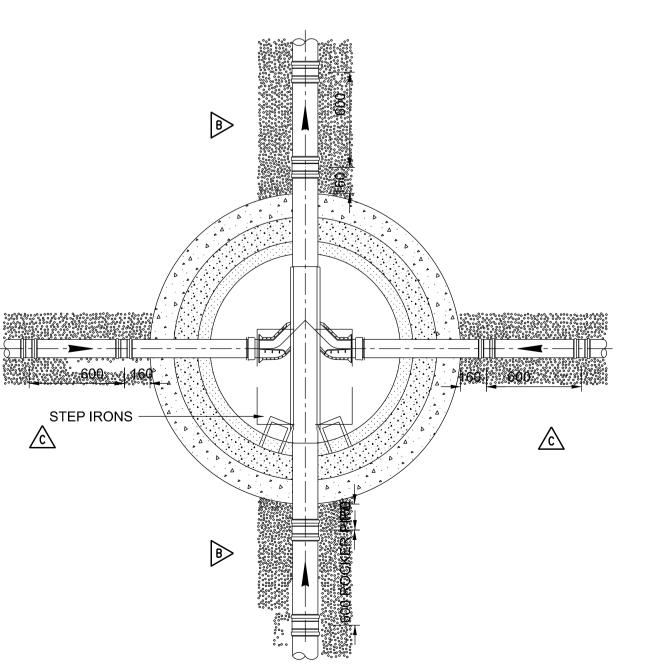



1:25 @ A1 UOS

201758-WAL-V1-DR-DR-C-0020

JULY 2024

JULY 2024