


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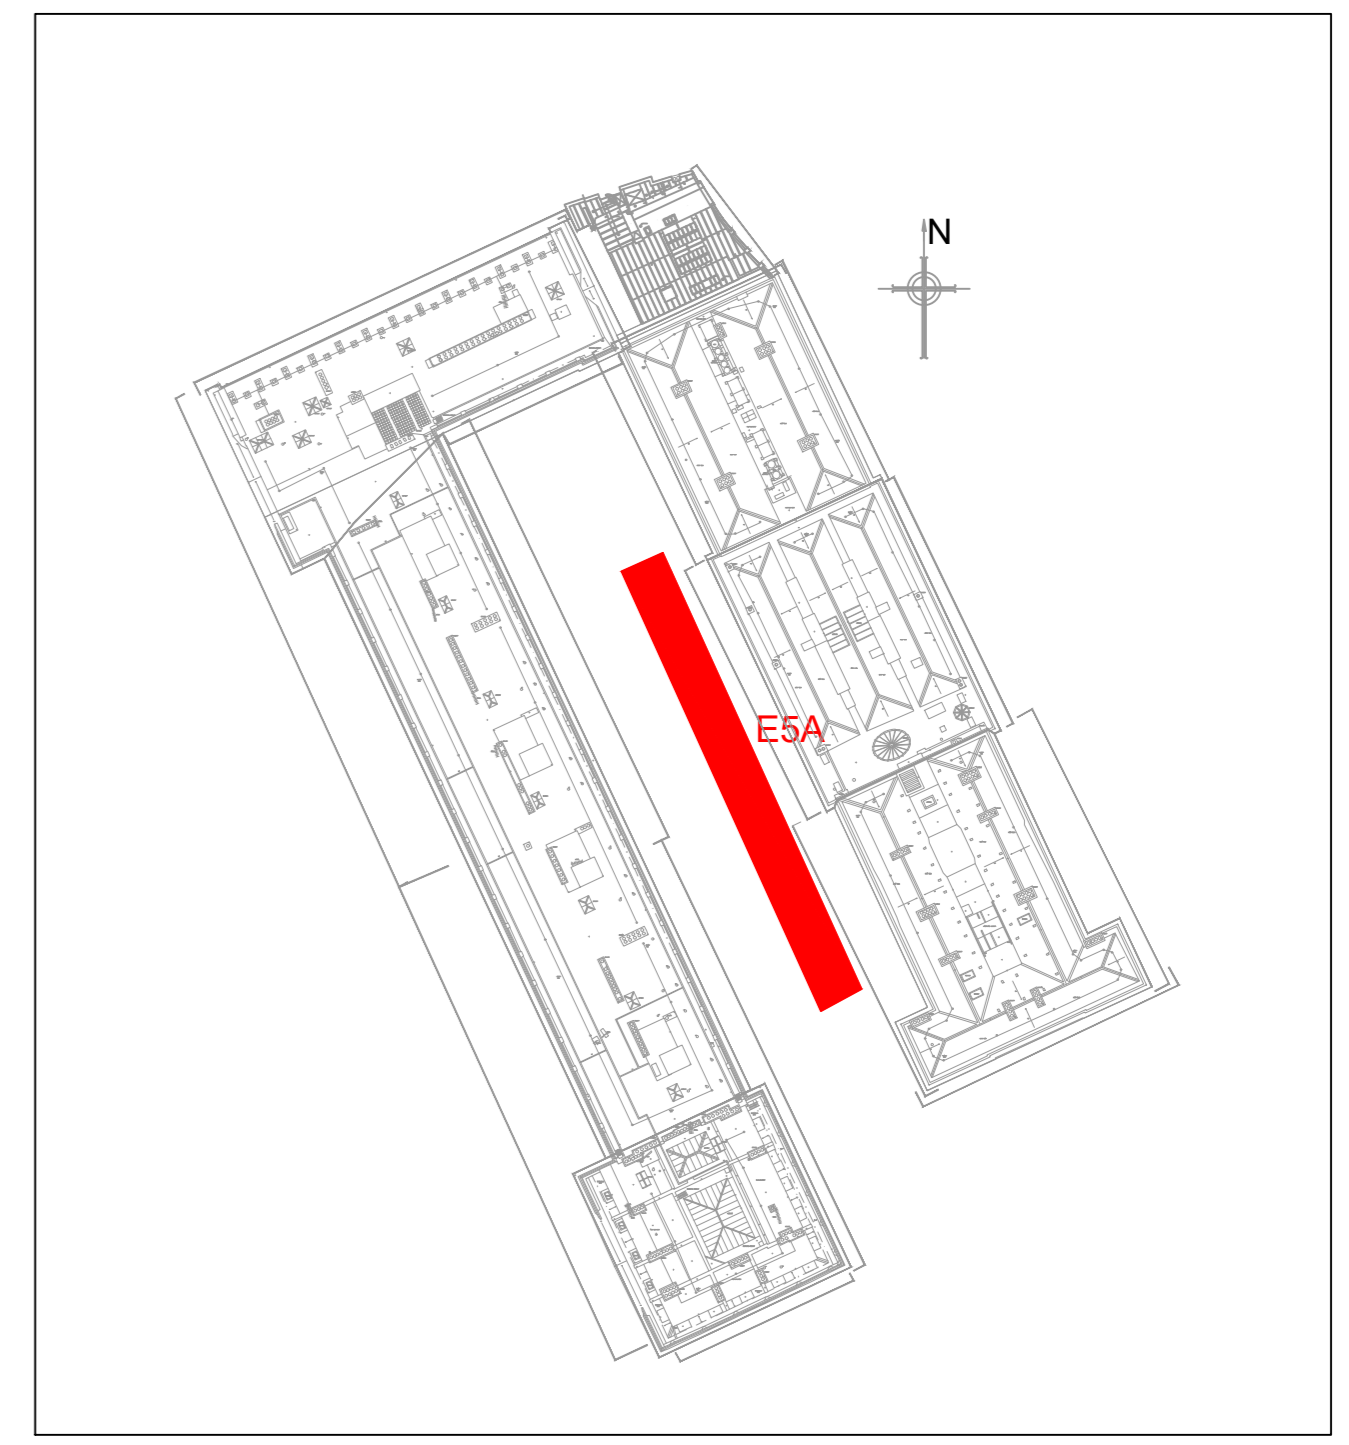
This drawing is to be read in conjunction with all other relevant drawings and specifications.

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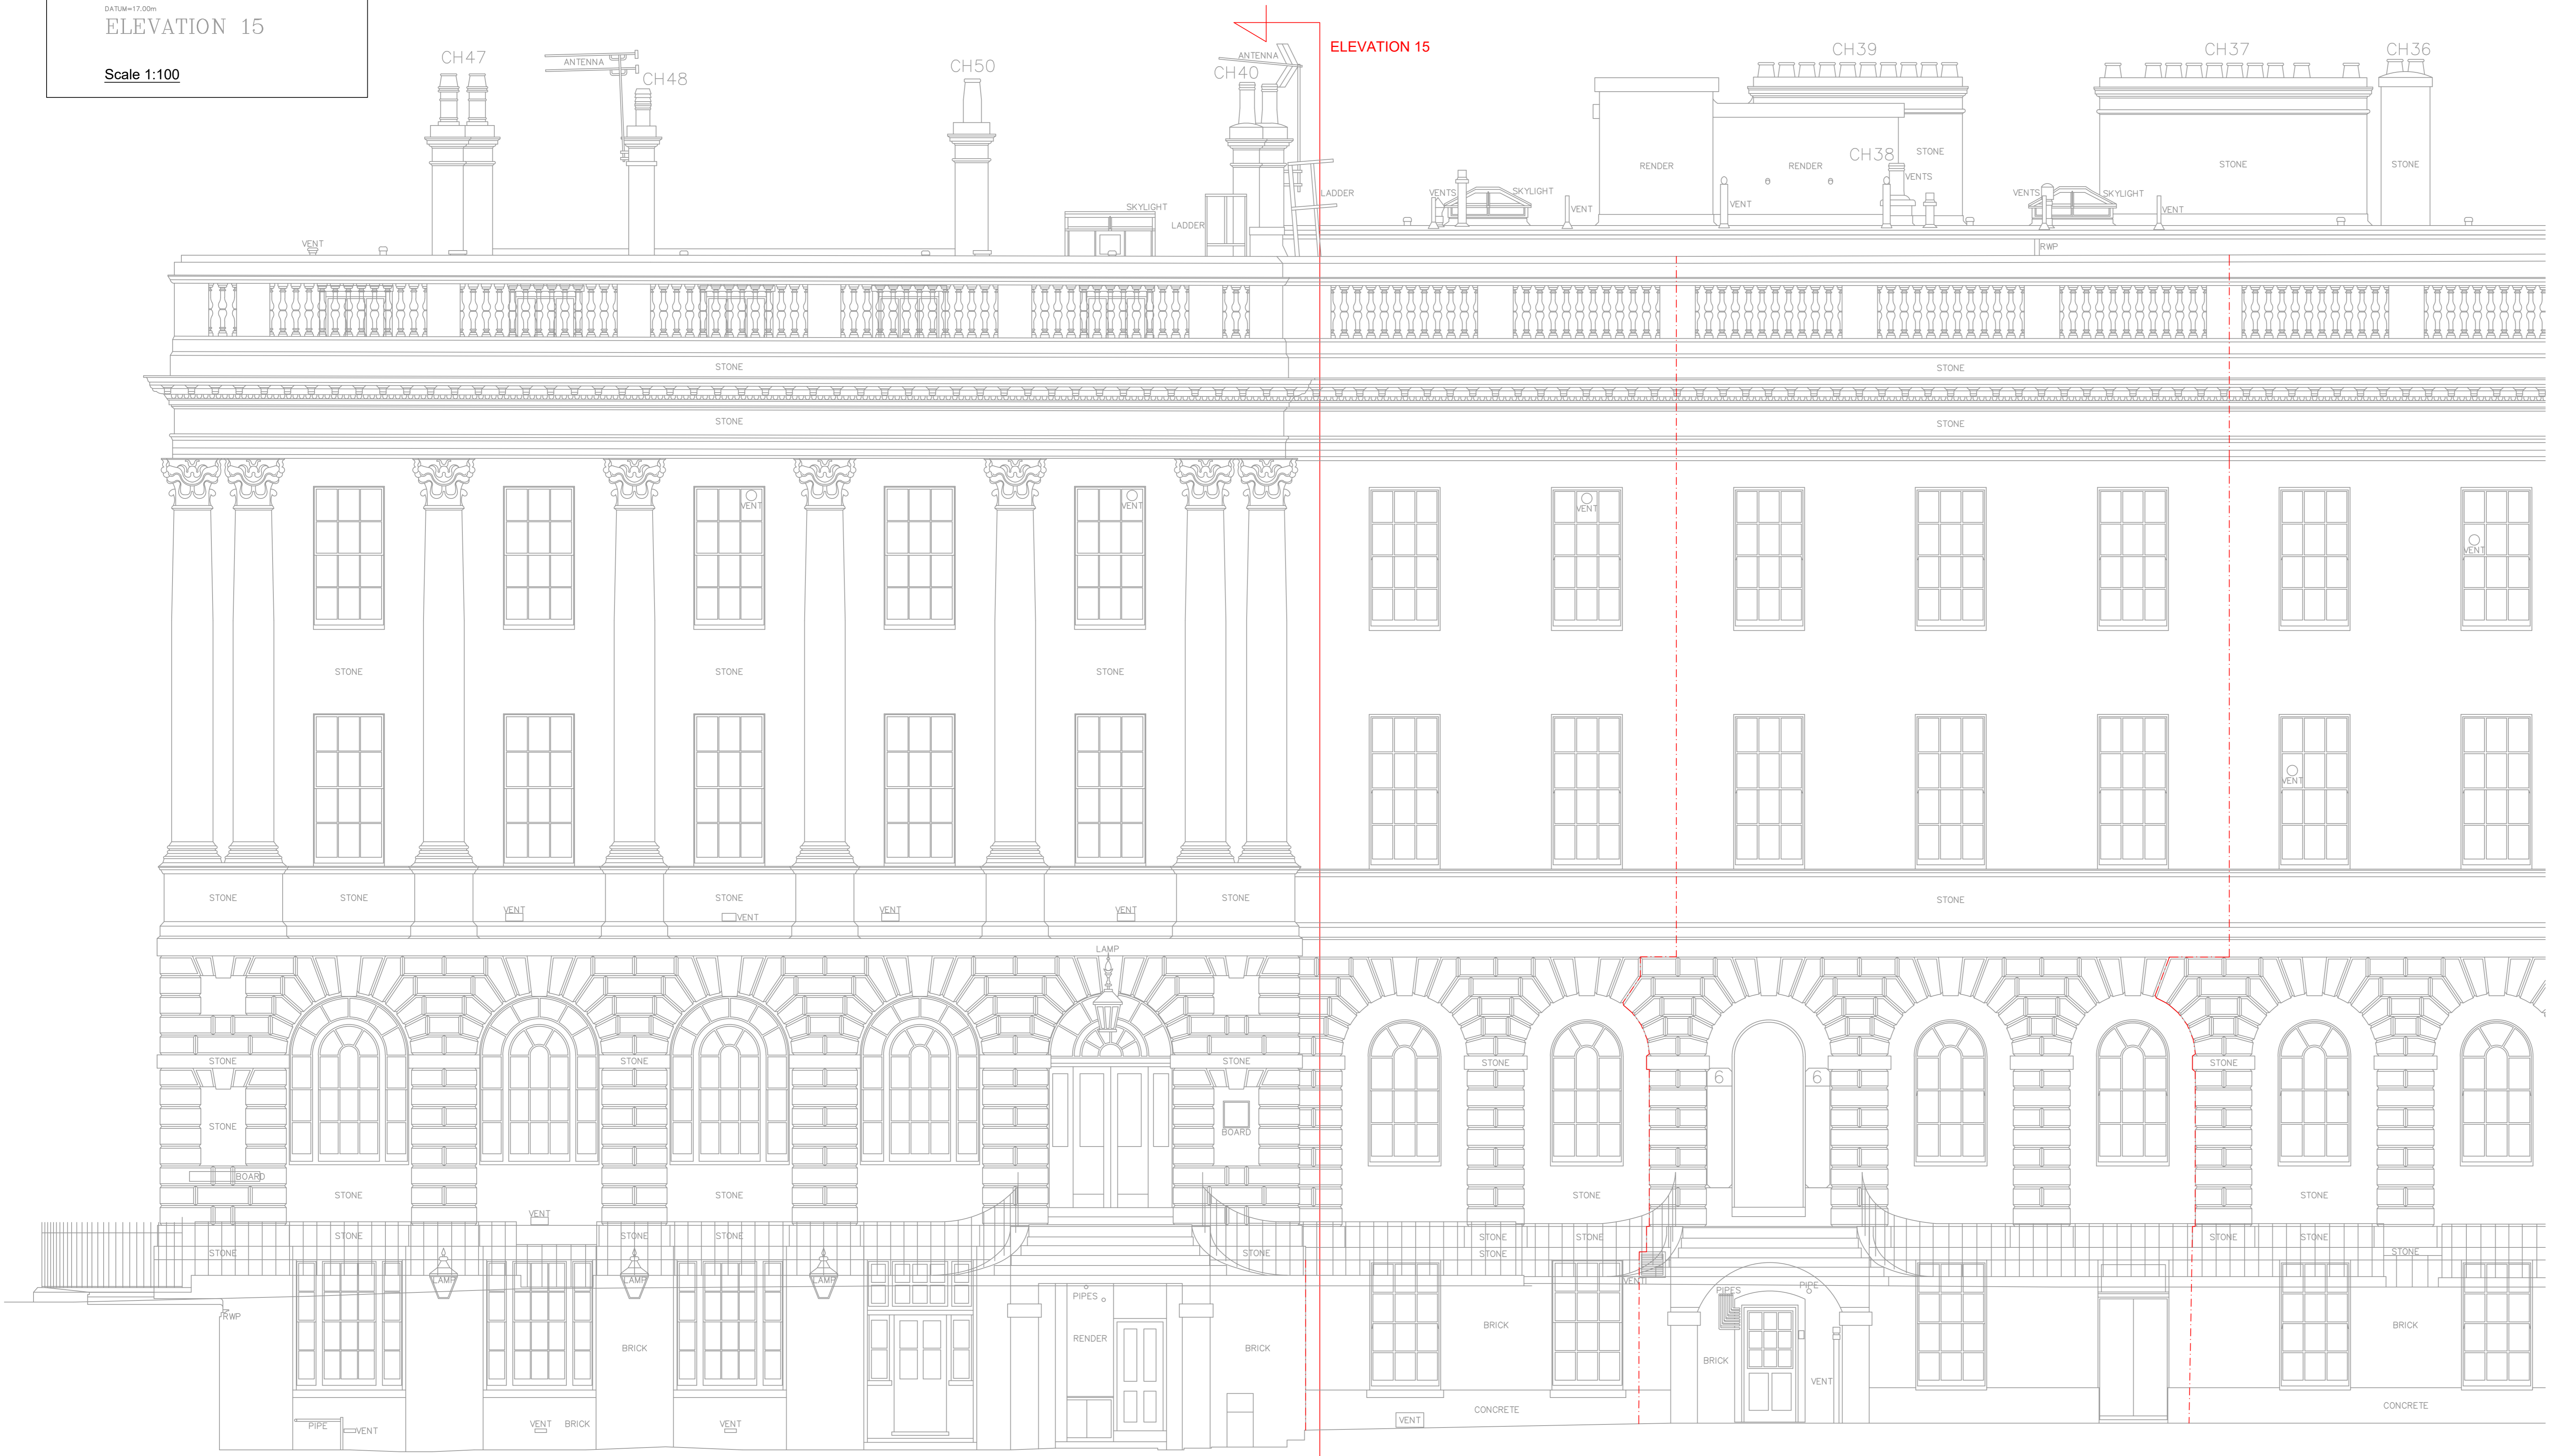
Legend:

--- Lighting protection HVI Conductor

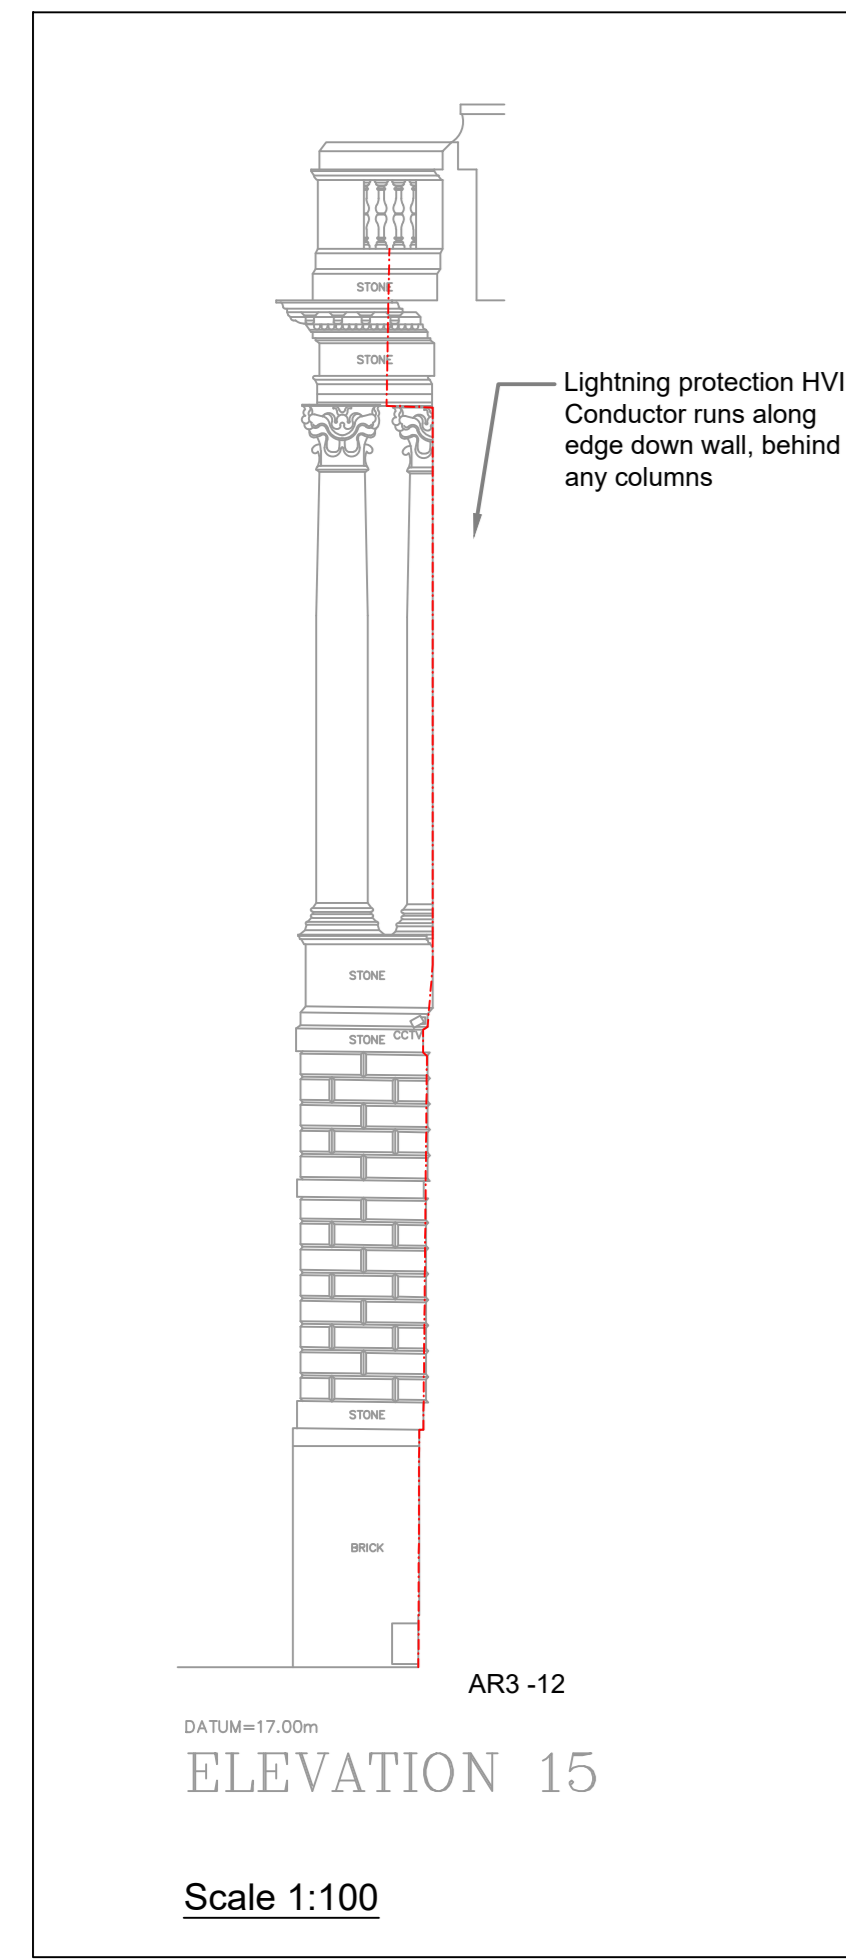

- Notes:
- Do not scale this drawing (printed or electronic version).
 - This drawing indicates design intent only and shall not be used as a working drawing or installation drawing. The Contractor shall be responsible for producing his own fully coordinated working drawings.
 - Contractors must check all dimensions on site prior to ordering materials or commencing work. Any discrepancies must be reported to the engineer immediately.
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 - This drawing should be read in conjunction with all relevant construction, electrical sub-conditions, supply chain drawings and specifications for exact setting out, size and type of components.
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 - Graphical representations of equipment on this drawing have been indicated, but are representative only. Please refer to specifications and / or details for actual sizes and or specific contractor construction information.
 - All builders work associated with the mechanical and electrical services installation must be included for.
 - Contractor to review site Asbestos register prior to commencing work.
 - All power and control wiring associated with the mechanical services installation must be included for.
 - The position of all equipment shown is indicative only. Final positions to be determined & indicated on working drawings.
 - Refer to presence detector installation instructions for wiring, switch type & final position.
 - Refer to mechanical layout drawings for position of outlets to mechanical plant.
 - Refer to mechanical drawings for extract fan details.
 - Cable containment (if indicated) is shown as indicative only. Contractor to determine cable containment routes and sizes to suit the installation.

- Note:-
- HVI conductor shall be painted to match the existing stonework/paint.
 - Where HVI conductors are installed behind/adjacent RWPs these shall be coloured black.



DATUM=+17.00m

ELEVATION 5A

Scale 1:50

AR3-9 AR3-7

| | | | |
|------------------------|------------------------|--------------|------------|
| PROJ Scale Bar Added | 01/02/2011 | NT1 | PC |
| PROJ Information Issue | 11/05/2011 | NT1 | PC |
| REV Description | Date | Drawn By | Checked By |
| Project No: 502705 | Scale @ A3: 1:50@1:100 | Drawn By: JP | |

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Vision, form and function

Project: HSLI Stone Building
 Lighting Protection System
 Stone Buildings
 London WC2A 3TL

Client: Honourable Society of Lincoln's Inn

File: Lighting Protection
 Elevation E5A

Drawing Number: HSLISB-IWD-XX-XX-DR-E-6818
 Status: Purpose of drawing: Information
 Revision: P02