
13.0 Appendix B


Construction Audit






BASEMENT

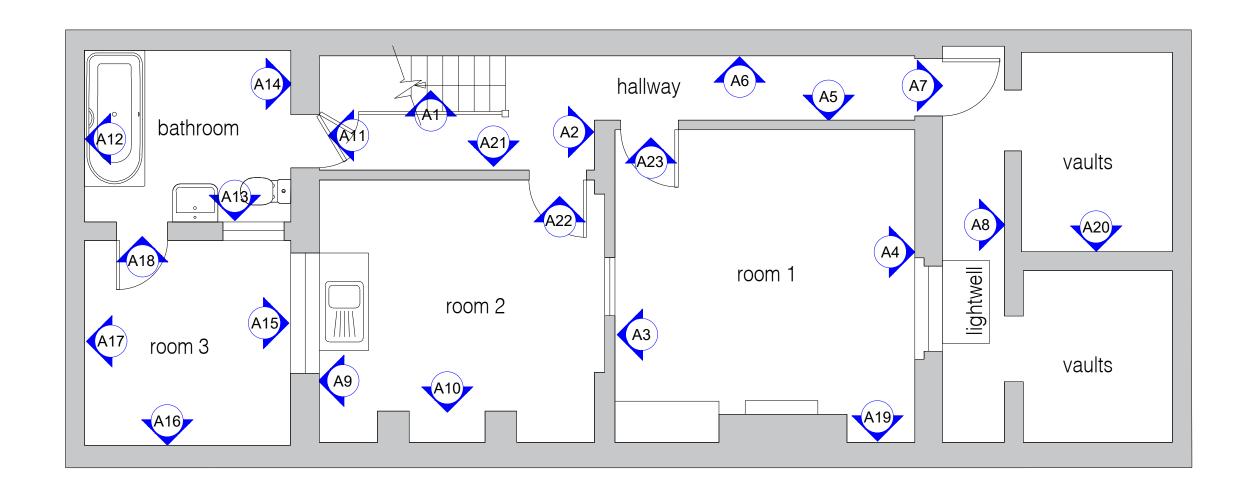

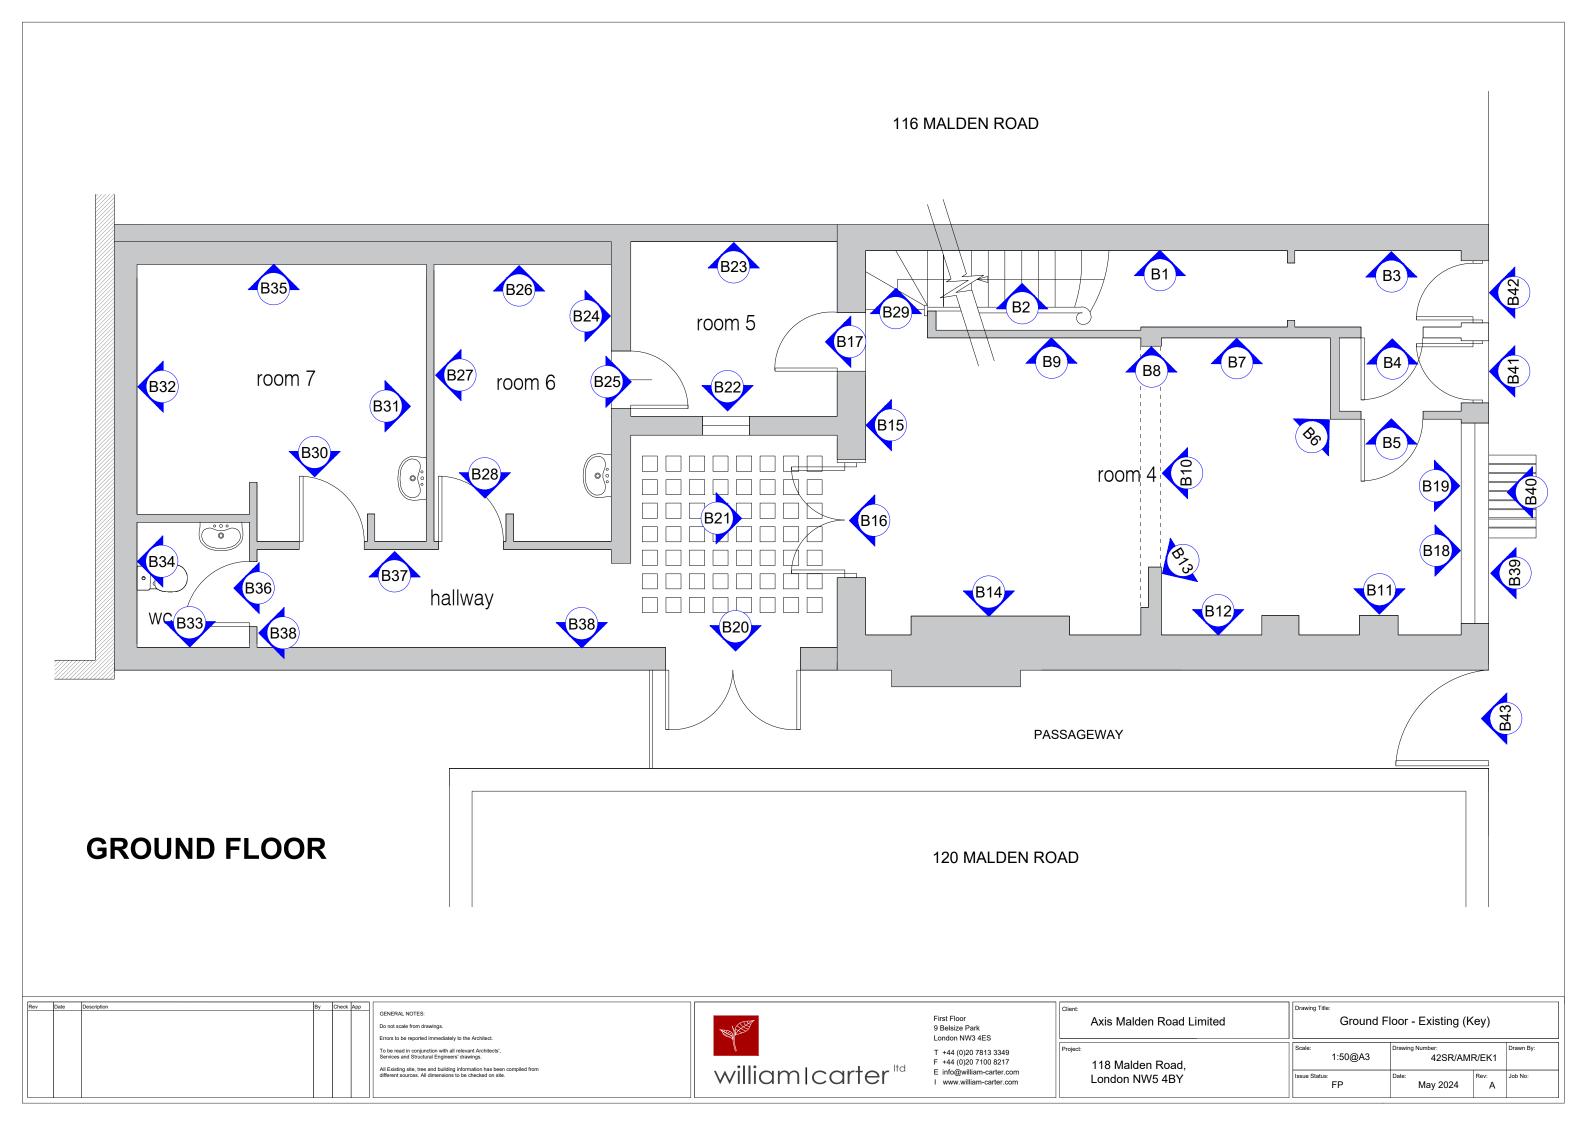


116 MALDEN ROAD

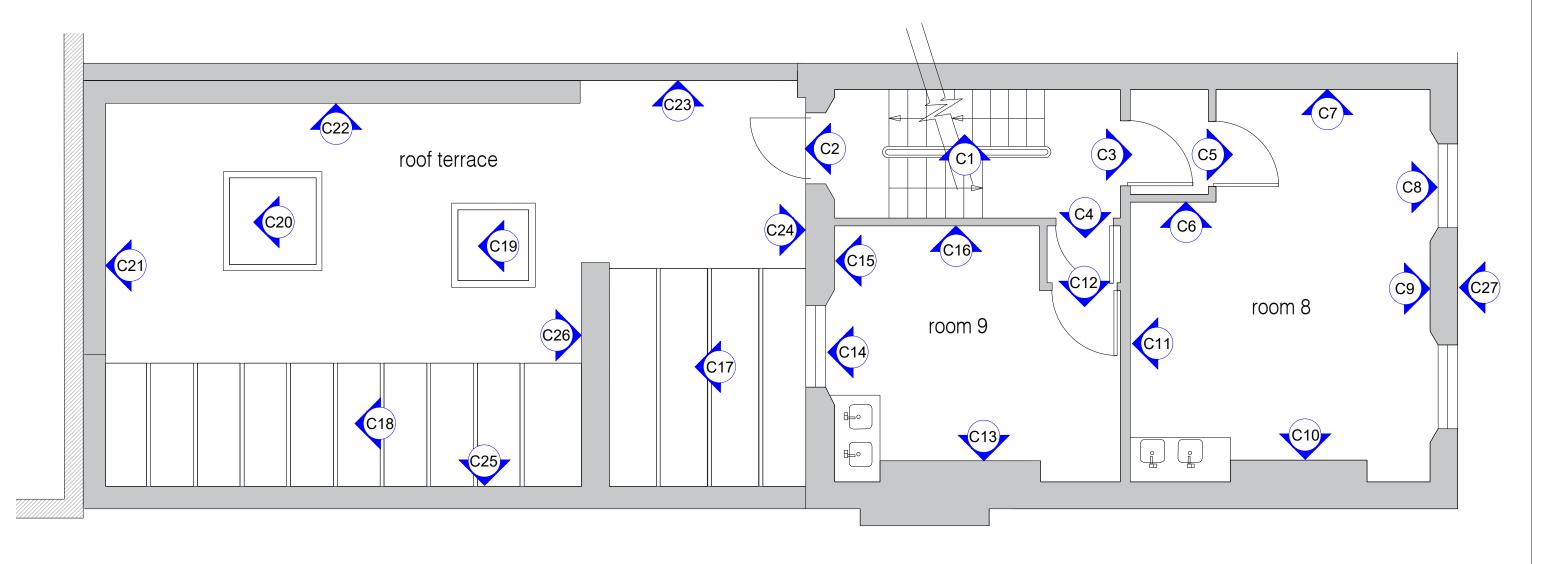



120 MALDEN ROAD

Rev	Date	Description	By Chec	ck App	GENERAL NOTES: Do not scale from drawings. Errors to be reported immediately to the Architect.		First Floor 9 Belsize Park London NW3 4ES	Axis Malden Road Limited	Drawing Title: First Floor	r - Existing (Key)
					To be read in conjunction with all relevant Architects', Services and Structural Engineers' drawings. All Existing site, tree and building information has been compiled from different sources. All dimensions to be checked on site.	• II • Itd	T +44 (0)20 7813 3349 F +44 (0)20 7100 8217	Project: 118 Malden Road,	Scale: 1:50@A3	Drawing Number: Drawn By: 42SR/AMR/EK1
					afferent sources. All almensions to be checked on site.	william I carter "	I www.william-carter.com	London NW5 4BY	Issue Status:	Date: Rev: Job No:

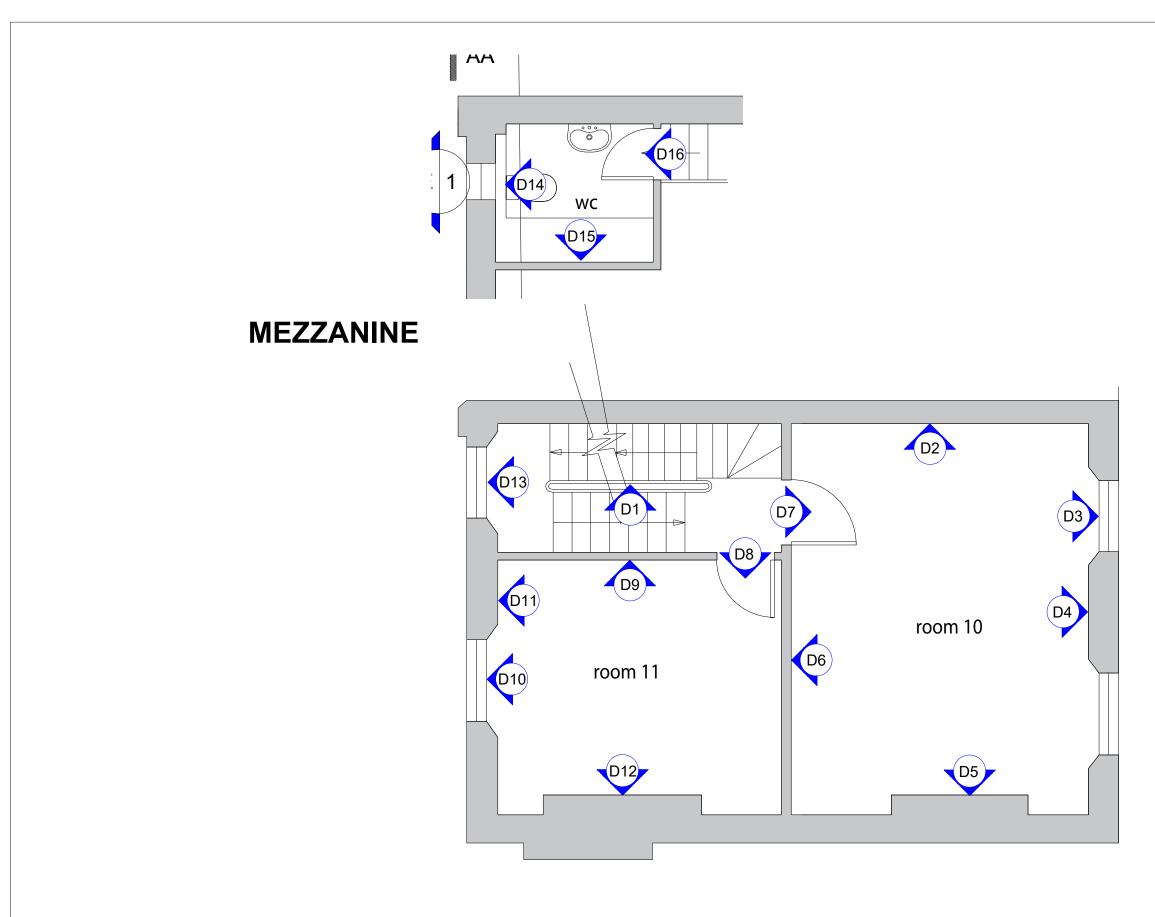

SECOND FLOOR

Rev	Date	Description	Ву	Check	Арр		
						GENERAL NOTES:	Ħ
						Do not scale from drawings.	İ
						Errors to be reported immediately to the Architect.	İ
						To be read in conjunction with all relevant Architects', Services and Structural Engineers' drawings.	
						All Existing site, tree and building information has been compiled from different sources. All dimensions to be checked on site.	




First Floor 9 Belsize Park London NW3 4ES

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Axis Malden Road Limited	Second Floor - Existing (Key)			
118 Malden Road,	Scale: Drawing Number: 42SR/AMR/EK1 Drawn By:			
London NW5 4BY	Issue Status:	Date: May 2024	Rev:	Job No:



Construction Audit

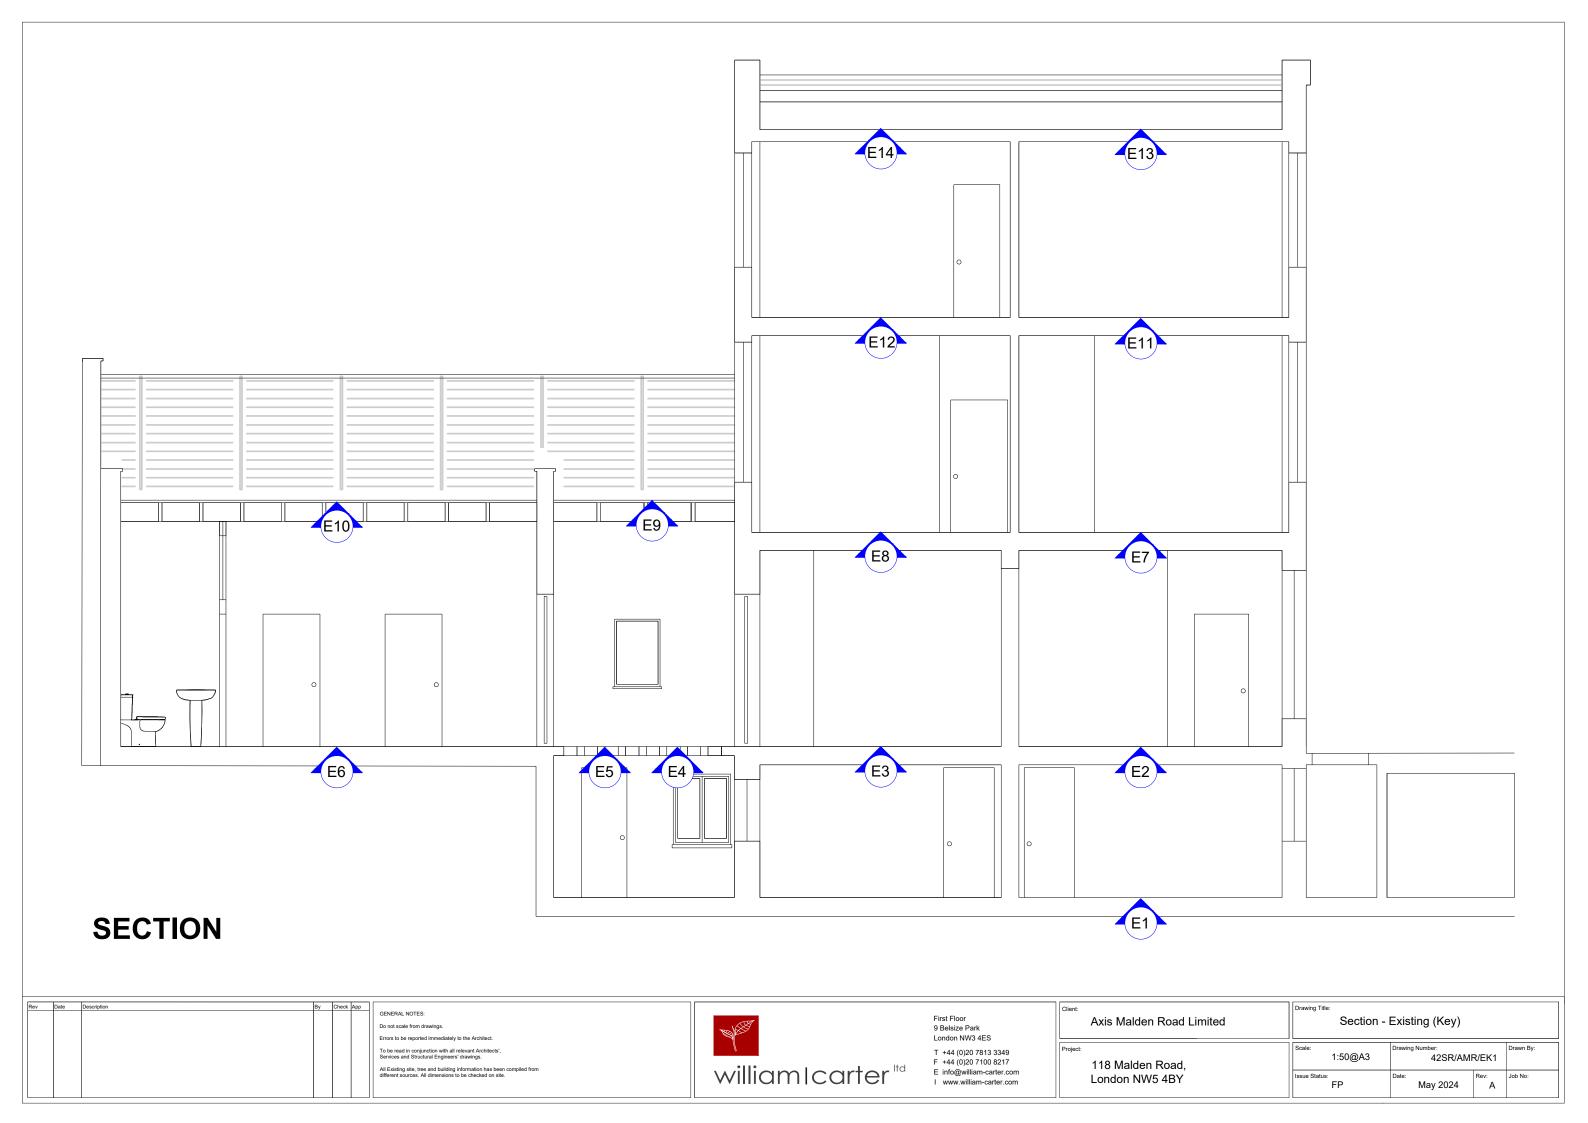DESCRIPTION	KEY	PHOTOGRAPH
DESCRIPTION	IXE I	THOTOGRAFIT
Basement Staircase:	A1	The same of the sa
Timber construction.		
Basement Wall:	A2	
9" Brickwork with render and plaster finish.		
Basement Wall:	А3	
Part 9" / Part 4" Brickwork with render and plaster finish.		

Α3 **Basement Wall:** Α4 9" Brickwork with render and plaster finish internally. Timber sash window – single glazed (boarded) Α4 Basement Hallway: A5, A6, Α7 A5: Brick retaining wall with render and plaster finish – thickness tbc. A6: 4" Brickwork with render and plaster finish. A7: Timber framed glazed door (boarded internally).

	T	
Basement Door: Timber framed single glazed door (boarded internally).	A7	
Vaults: 4" Brickwork.	A8	
Basement Wall: 9" Brickwork with render and plaster finish internally, render only externally. Timber casement window – single glazed.	A9	

Basement Wall:	A10	
Brick retaining wall with render and plaster finish – thickness tbc. Brick chimneybreast.		
Basement Door: Timber panelled.	A11	
Basement Wall: Brick retaining wall with part render and plaster / part tiled finish – thickness tbc.	A12	
Basement Wall: 9" Brickwork with part render and plaster / part tiled finish internally, render only externally. Timber casement windows – single glazed, positioned internally and externally.	A13	

Basement Wall:	A14	
9" Brickwork with part render and plaster / part tiled finish.		
Basement Wall:	A15	
9" Brickwork with render and plaster finish internally, render only externally. Timber casement window – single glazed.		
	A15	
Basement Wall: Brick retaining wall with render finish — thickness tbc.	A16	

Basement Wall:	A17	
Brick retaining wall with render finish – thickness tbc.		
Basement Door:	A18	
Flush timber door.		
Basement Wall:	A19	
Brick retaining wall with render and plaster finish – thickness tbc. Brick chimneybreast.		
Ground Floor Wall & Staircase: B1: Ground floor party wall. Brickwork with plaster finish – presumed 13.5" thickness. B2: Timber staircase.	B1, B2	

Ground Floor Wall:	В3	
Ground floor party wall. Brickwork with plaster finish – presumed 13.5" thickness.		
Ground Floor Door: Flush timber – presumed FD30.	B4	PORTANT
Ground Floor Door: Flush timber – presumed FD30.	B5	
Ground Floor Wall: Partition wall – 75mm x 50mm nominal timber stud with plasterboard and plaster finish.	B6	

Ground Floor Wall:	B7	
Partition wall – 75mm x 50mm nominal timber stud with plasterboard and plaster finish.		
Steel Column: Presumed 152 x 152 x 37 UC.	B8	
Ground Floor Wall: Partition wall – 75mm x 50mm nominal timber stud with plasterboard and plaster finish.	В9	
Ground Floor Wall: Partition wall – 75mm x 50mm nominal timber stud with plasterboard and plaster finish.	B9	

	T	
Steel Beam:	B10	
Presumed 2No. 200 x 90 x 30 PFCs		
	B10	
Ground Floor Wall: B12: 13.5" Brickwork with render and plaster finish. B11: Brick chimneybreast.	B11, B12	
Ground Floor Wall: 4" Brickwork with render and plaster finish.	B13	

Ground Floor Wall:	B14	
13.5" Brickwork with render and plaster finish. Brick chimneybreast. Timber joinery in front		
Ground Floor Wall: 13.5" Brickwork with render and plaster finish.	B15	
Ground Floor Doors: Timber framed glazed double doors.	B16	
Ground Floor Door: Flush timber – presumed FD30.	B17	

Ground Floor Beam:	B18	
Timber bressummer beam. 2No. 200mm x 100mm.		
Ground Floor Shopfront:	B19	
Aluminium framed, single glazed shopfront with external roller shutter.		
	B19	
Ground Floor Doors: Timber panelled external double doors.	B20	

Ground Floor:	B21	
150mm Concrete with glass lights.		
Ground Floor Wall:	B22	
9" Brickwork with render and plaster finish.		
Internal timber casement window.		
Ground Floor Wall:	B23	
Ground floor party wall. Brickwork with plaster finish – presumed 9" thickness.		
Ground Floor Wall:	B24, B25	
B24: 9" Brickwork with render and plaster finish.		
B25: Flush timber – presumed FD30.		

	B24, B25	
Ground Floor Wall: 250mm cavity wall – 100mm dense concrete block / 50mm insulation / 100 dense concrete block with render and plaster finish internally. Built inside of the party wall.	B26	
	B26	
	B26	

Ground Floor Wall: 100mm dense concrete block with render and plaster finish.	B27	
Ground Floor Door: Flush timber – presumed FD30.	B28	
Ground Floor Stairs:	B29	
Timber construction.		
Ground Floor Door: Flush timber – presumed FD30.	B30	

Ground Floor Wall:	B31	
100mm dense concrete block with render and plaster finish.		
Ground Floor Wall:	B32	
250mm cavity wall – 100mm dense concrete block / 50mm insulation / 100 dense concrete block with render and plaster finish internally. Built inside of the party wall.		
Ground Floor Wall: 250mm cavity wall – 100mm dense concrete block / 50mm insulation / 100 dense concrete block with render and plaster finish internally. Built inside of the party wall.	B33	
Ground Floor Wall: 250mm cavity wall – 100mm dense concrete block / 50mm insulation / 100 dense concrete block with render and plaster finish internally. Built inside of the party wall.	B34	

	B34	
Ground Floor Wall: 250mm cavity wall – 100mm dense concrete block / 50mm insulation / 100 dense concrete block with render and plaster finish internally. Built inside of the party wall.	B35	
Ground Floor Wall and Door: B38: 100mm dense concrete block with render and plaster finish. B36: Flush timber door – presumed FD30	B36, B38	S V C C 1 OF D V C W S A
Ground Floor Wall and Door: 100mm dense concrete block with render and plaster finish.	B37	

B37 Ground Floor Wall: B38 250mm cavity wall – 100mm dense concrete block / 50mm insulation / 100 dense concrete block with render and plaster finish internally. Built inside of the party wall. **B38 Ground Floor Shopfront:** B39 Aluminium framed, single glazed shopfront with external roller shutter.

Ground Floor Pavement Grill:	B40	
Ground Floor Door: Aluminium glazed entrance door.	B41	
Ground Floor Door: Aluminium glazed entrance door.	B42	
Ground Floor Side Gate:	B43	

First Floor Staircase:	C1	
Timber construction.		
First Floor Window: Timber single glazed casement with steel security grill.	C2	
First Floor Door: Flush timber – presumed FD30.	C3	
First Floor Door: Flush timber – presumed FD30.	C4	

First Floor Door and Wall:	C5, C6	
C5: Flush timber – presumed FD30. C6: Partition wall – 75mm x 50mm nominal timber stud with plasterboard and plaster finish.		
First Floor Wall: Brickwork party wall with plaster finish – presumed 9" thickness.	C7	
First Floor Window: Timber framed sash window – single glazed.	C8	Four Trees Surgery
First Floor Wall: 13.5" Brickwork with plaster finish.	C9	

First Floor Wall:	C10	
13.5" Brickwork with plaster finish. Brick chimneybreast.		
First Floor Wall: 100mm x 50mm Stud wall with plaster and lathe finish.	C11	
First Floor Door: Flush timber – presumed FD30.	C12	
First Floor Wall: 13.5" Brickwork with plaster finish. Brick chimneybreast.	C13	

	1	
First Floor Wall and Window: C15: 13.5" Brickwork with plaster finish. C14: Timber framed sash window – single glazed, with steel security grill.	C14, C15	
First Floor Wall: 100mm x 50mm Stud wall with plaster and lathe finish.	C16	
First Floor Roof: C17, C18: Steel framed single glazed roof. C19, C20: PVC Rooflights. C21: 250mm Cavity parapet wall (100 dense concrete block, 50mm cavity, 100 dense concrete block) with render finish. Once weathered concrete coping on top. Built in front of party wall.	C17, C18, C19, C20, C21	
First Floor Roof: 250mm Cavity parapet wall (100 dense concrete block, 50mm cavity, 100 dense concrete block) with render finish. Once weathered concrete coping on top. Built in front of party wall.	C22	

First Floor Roof:	C23	
9" Brick party wall.		
First Floor Rear Elevation: 13.5" Brickwork, plastered internally.	C24	
First Floor Roof: 250mm Cavity parapet wall (100 dense concrete block, 50mm cavity, 100 dense concrete block) with render finish. Once weathered concrete coping on top.	C25	
First Floor Roof: 250mm Cavity parapet wall (100 dense concrete block, 50mm cavity, 100 dense concrete block) with render finish. Once weathered concrete coping on top.	C26	

First Floor Front Elevation:	C27	
13.5" Brickwork, plastered internally.		Four Trees Surgery Page 1 and
	C27	Four Trees Surgery
Second Floor Staircase: Timber construction.	D1	
Second Floor Wall: Brickwork party wall with plaster finish — presumed 9" thickness.	D2	

Second Floor Window:	D3	
Timber framed sash window – single glazed.		
Second Floor Wall:	D4	
13.5" Brickwork with plaster finish.		
Second Floor Wall:	D5	
13.5" Brickwork with plaster finish.		
Brick chimneybreast.		
Second Floor Wall:	D6	
100mm x 50mm Stud wall with plaster and lathe finish.		

Second Floor Door:	D7	
Flush timber door – Presumed FD30.		
Second Floor Door: Flush timber door – Presumed FD30.	D8	
Second Floor Wall:	D9	
70mm x 50mm Stud wall with plaster and lathe finish.		
Second Floor Window: Timber framed sash window – single glazed.	D10	

Second Floor Walls: D11: 13.5" Brickwork with plaster finish. D12: 13.5" Brickwork with plaster finish. Brick chimneybreast	D11, D12	
	D12	
Second Floor Window: Timber framed sash window – single glazed.	D13	
Second Floor Mezzanine Wall and Window: 9" Brickwork with plaster finish. Timber framed casement window – single glazed.	D14	

Second Floor Mezzanine Wall:	D15	
100mm x 50mm Stud wall with plaster and lathe finish.		
Second Floor Mezzanine Door:	D16	
Panelled timber door.		
Basement Floor: 150mm Thick dense concrete slab.	E1	
Ground Floor: 200mm x 50mm Timber joists at approximately 350mm centres. Running front to back.	E2, E3	

	E2, E3	
	E2, E3	
Ground Floor: 100mm x 70mm Timber joists. Running front to back	E4	
Ground Floor: 150mm Concrete with glass lights.	E5	

Ground Floor:	E6	
250mm Thick dense concrete slab.		
First Floor:	E7	
190mm x 50mm Timber joists at approximately 400 centres. Running front to back. Strapped to masonry along flank wall. Plaster and lathe beneath, pine floorboards above.		
	E7	
	E7	

	E7	
First Floor: 190mm x 50mm Timber joists at approximately 400 centres. Running front to back. Plaster and lathe beneath, pine floorboards above.	E8	
	E8	
	E8	

Ground Floor Roof:	E9, E10	
200mm x 50mm Timber joists with 75mm firrings, pine boarded deck and asphalt roof covering. Plasterboard beneath.		
Second Floor: 190mm x 50mm Timber joists at approximately 400 centres. Running front to back. Plaster and lathe beneath, pine floorboards above.	E11	
	E11	
Second Floor: 190mm x 50mm Timber joists at approximately 400 centres. Running front to back. Plaster and lathe beneath, pine floorboards above.	E12	

	E12	
		2 10 10 10 10 10 10 10 10 10 10 10 10 10
Second Floor Ceiling: 75mm x 50mm Timber Joists at approximately 400mm centres. Running front to back.	E13, E14	
	E13, E14	
Ground Floor Hallway		

Vaults	
Room 1	
Room 2	
Basement Bathroom	

Room 3	
Room 4	
Room 5	
Room 6	

Room 7	
WC	
Plumbing and Electrical Installations	
Plumbing and Electrical Installations	

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