Appendix 2

Proposed drawings Rev A, 31.05.24



Drawing no: 2203-3-099

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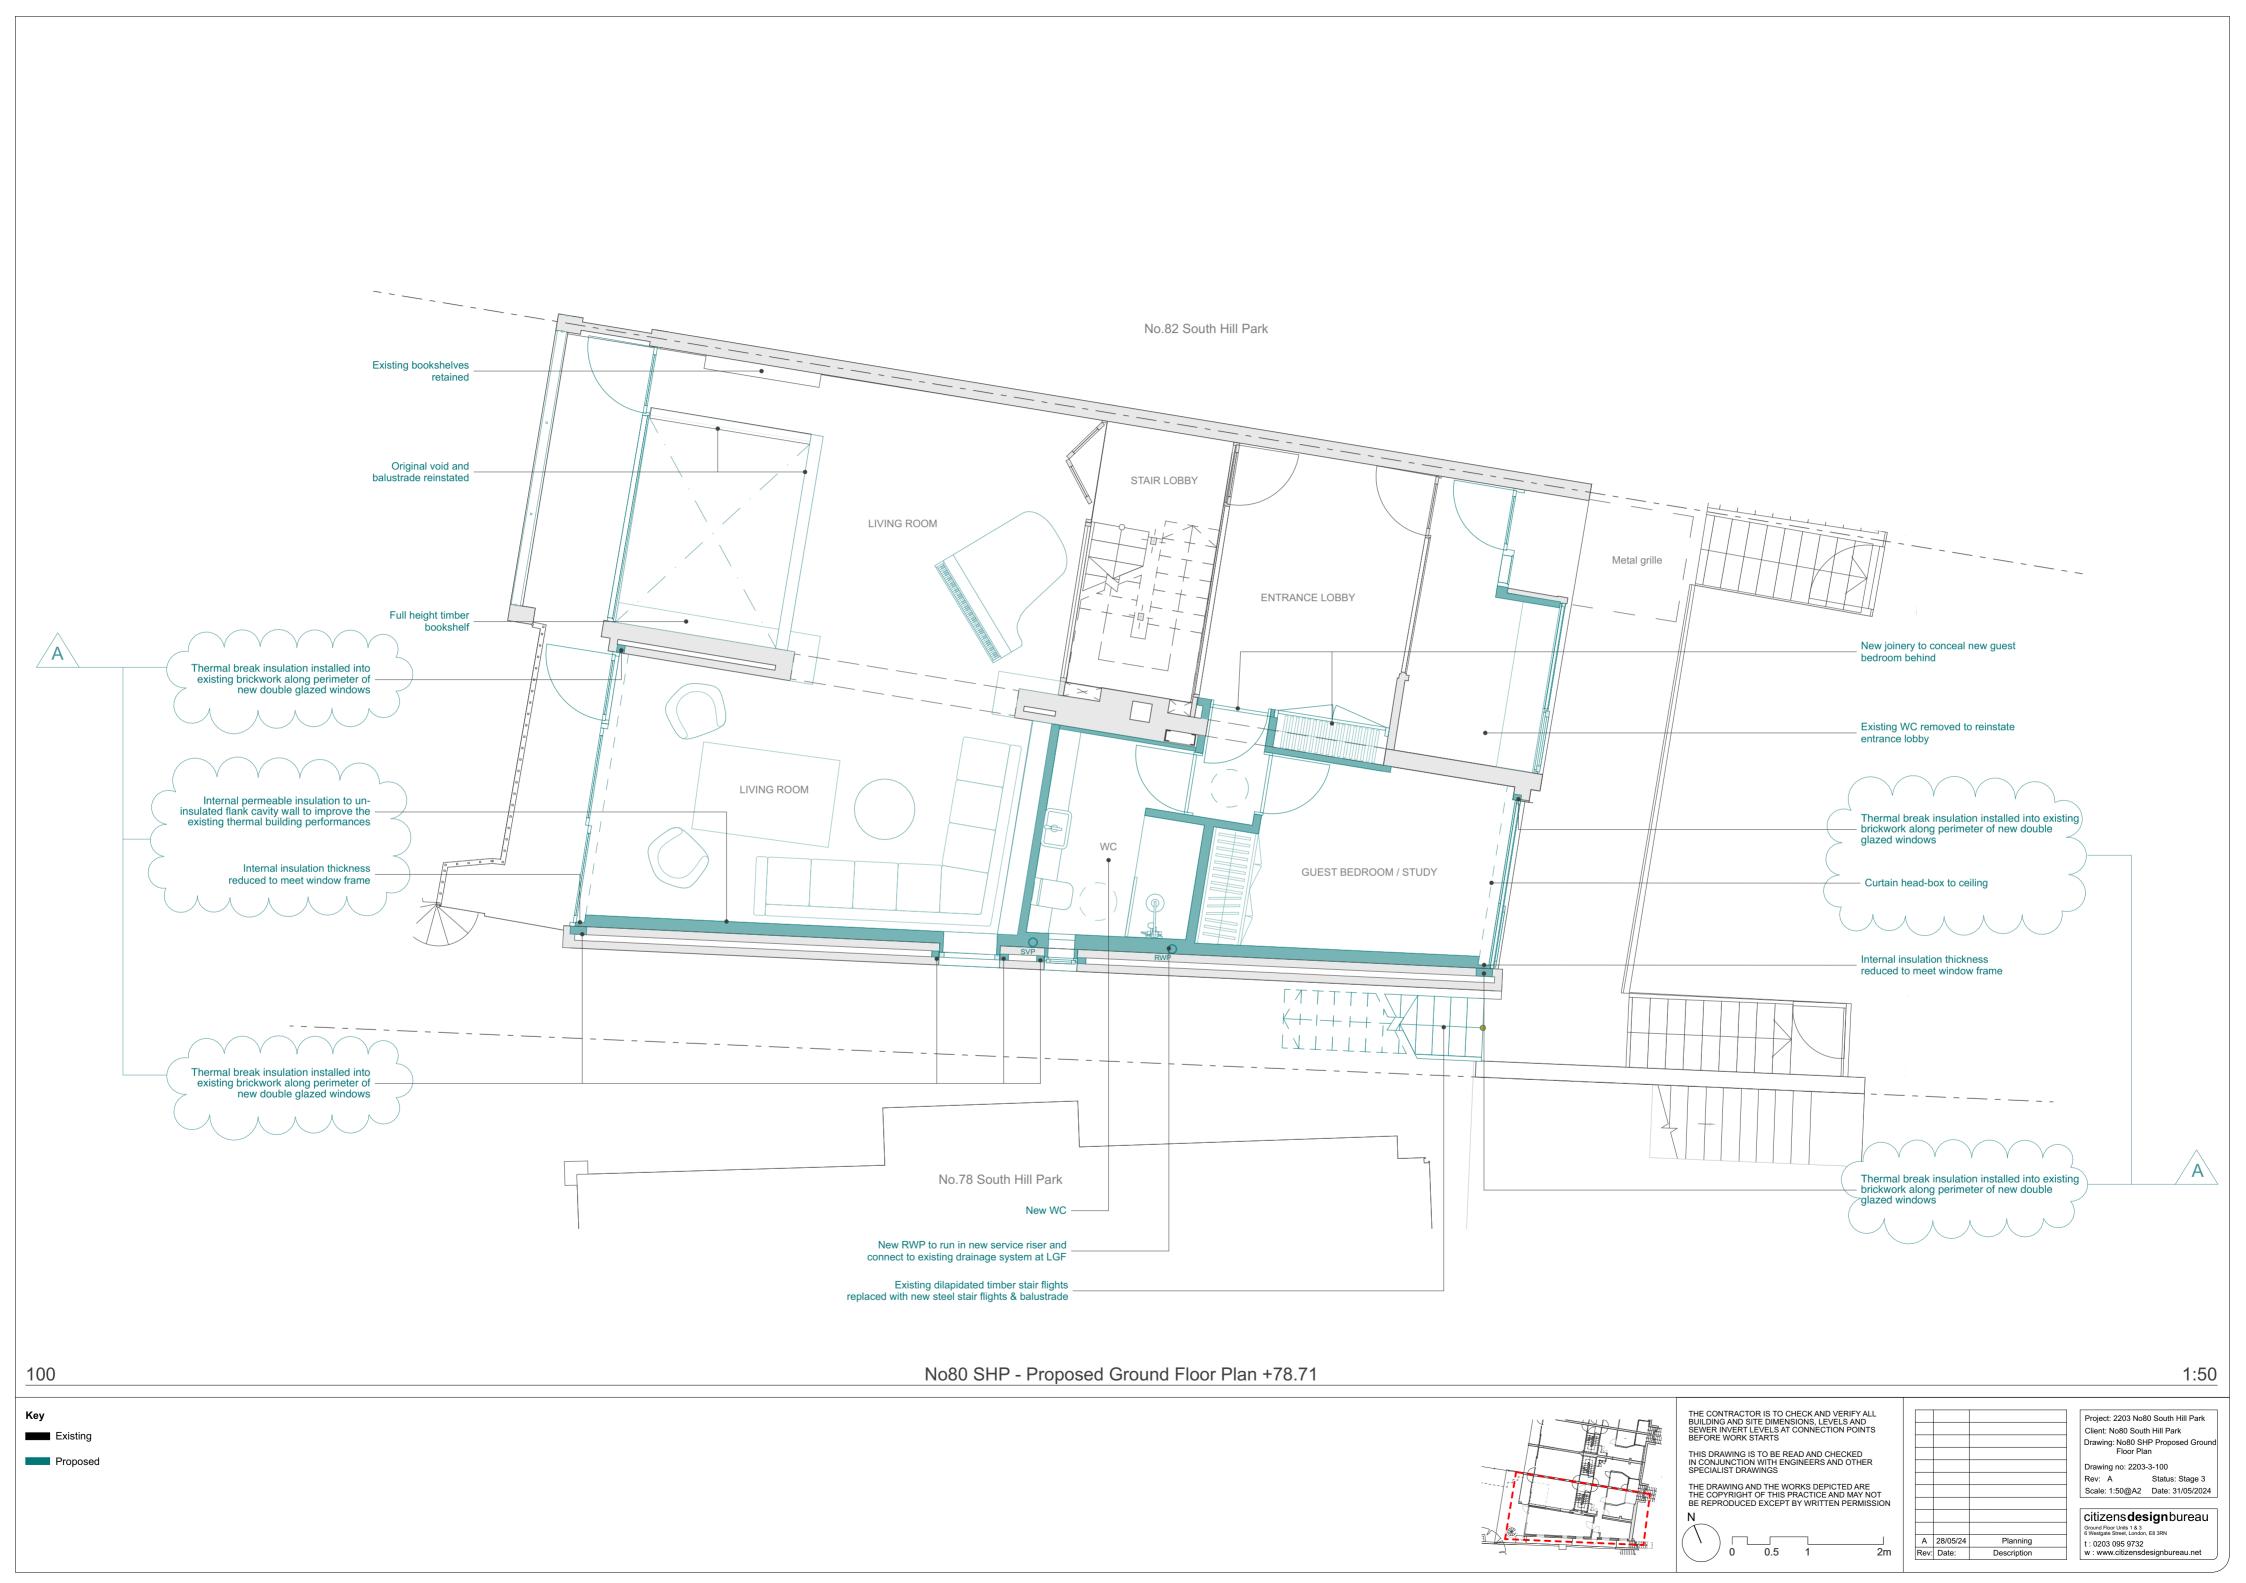
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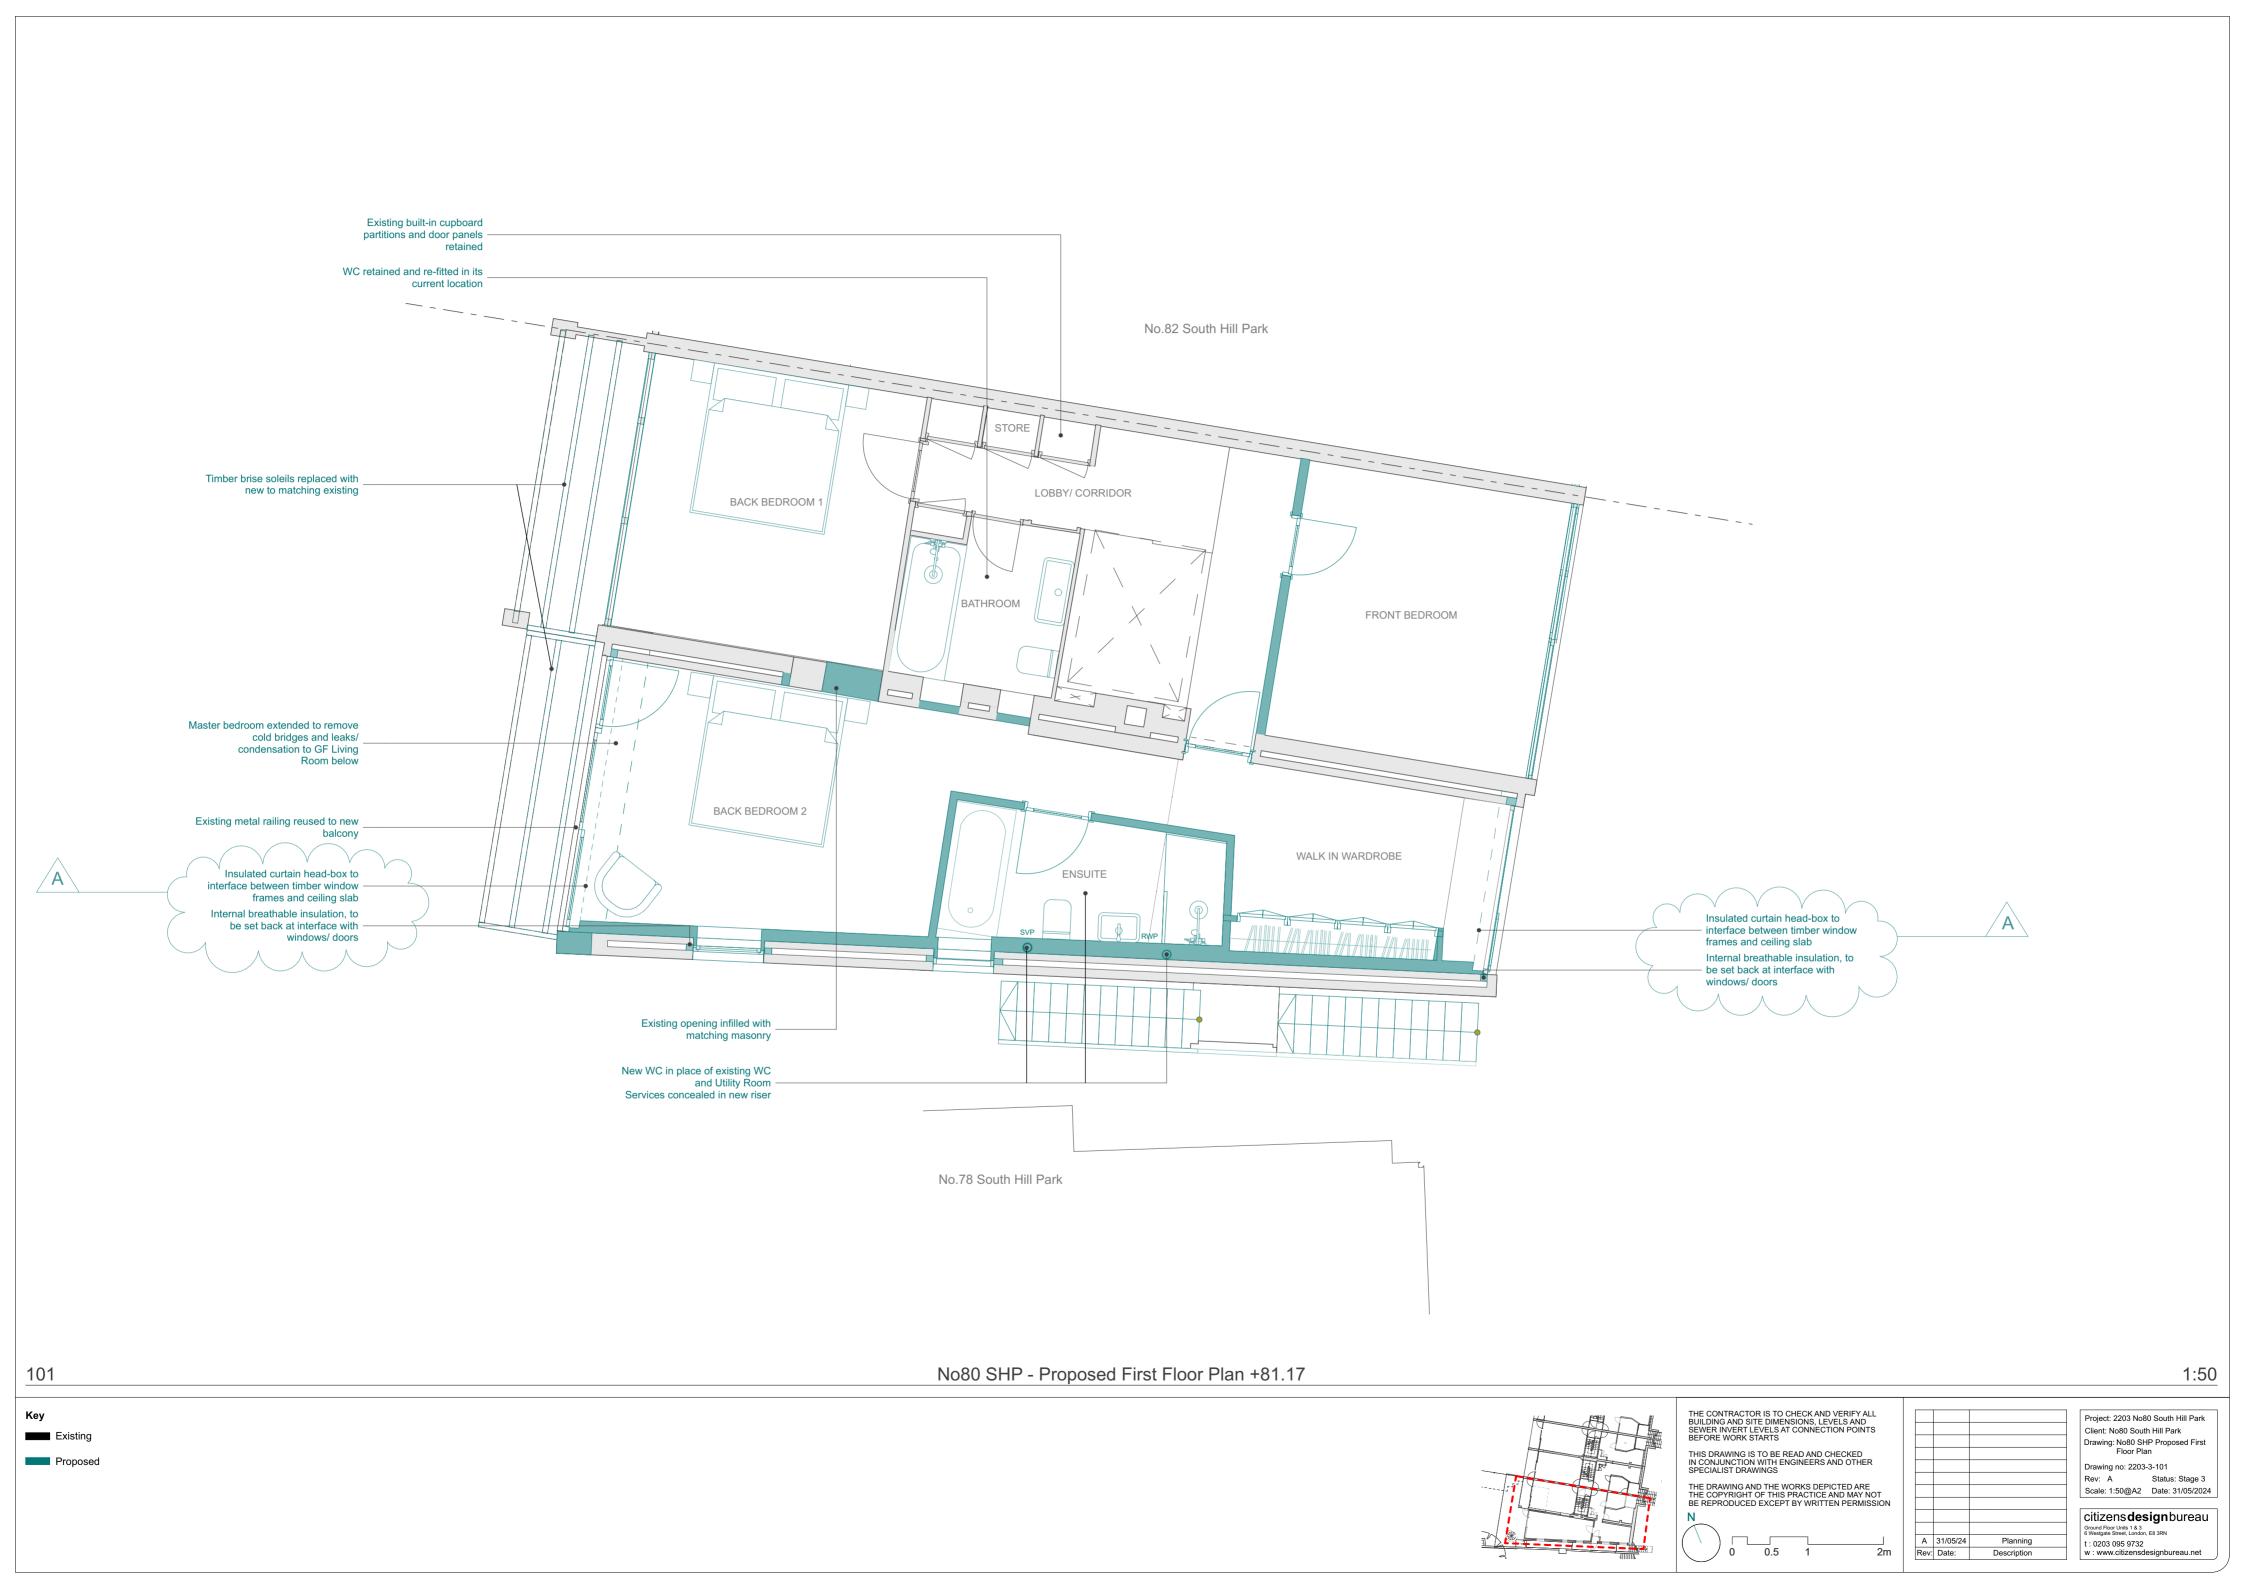
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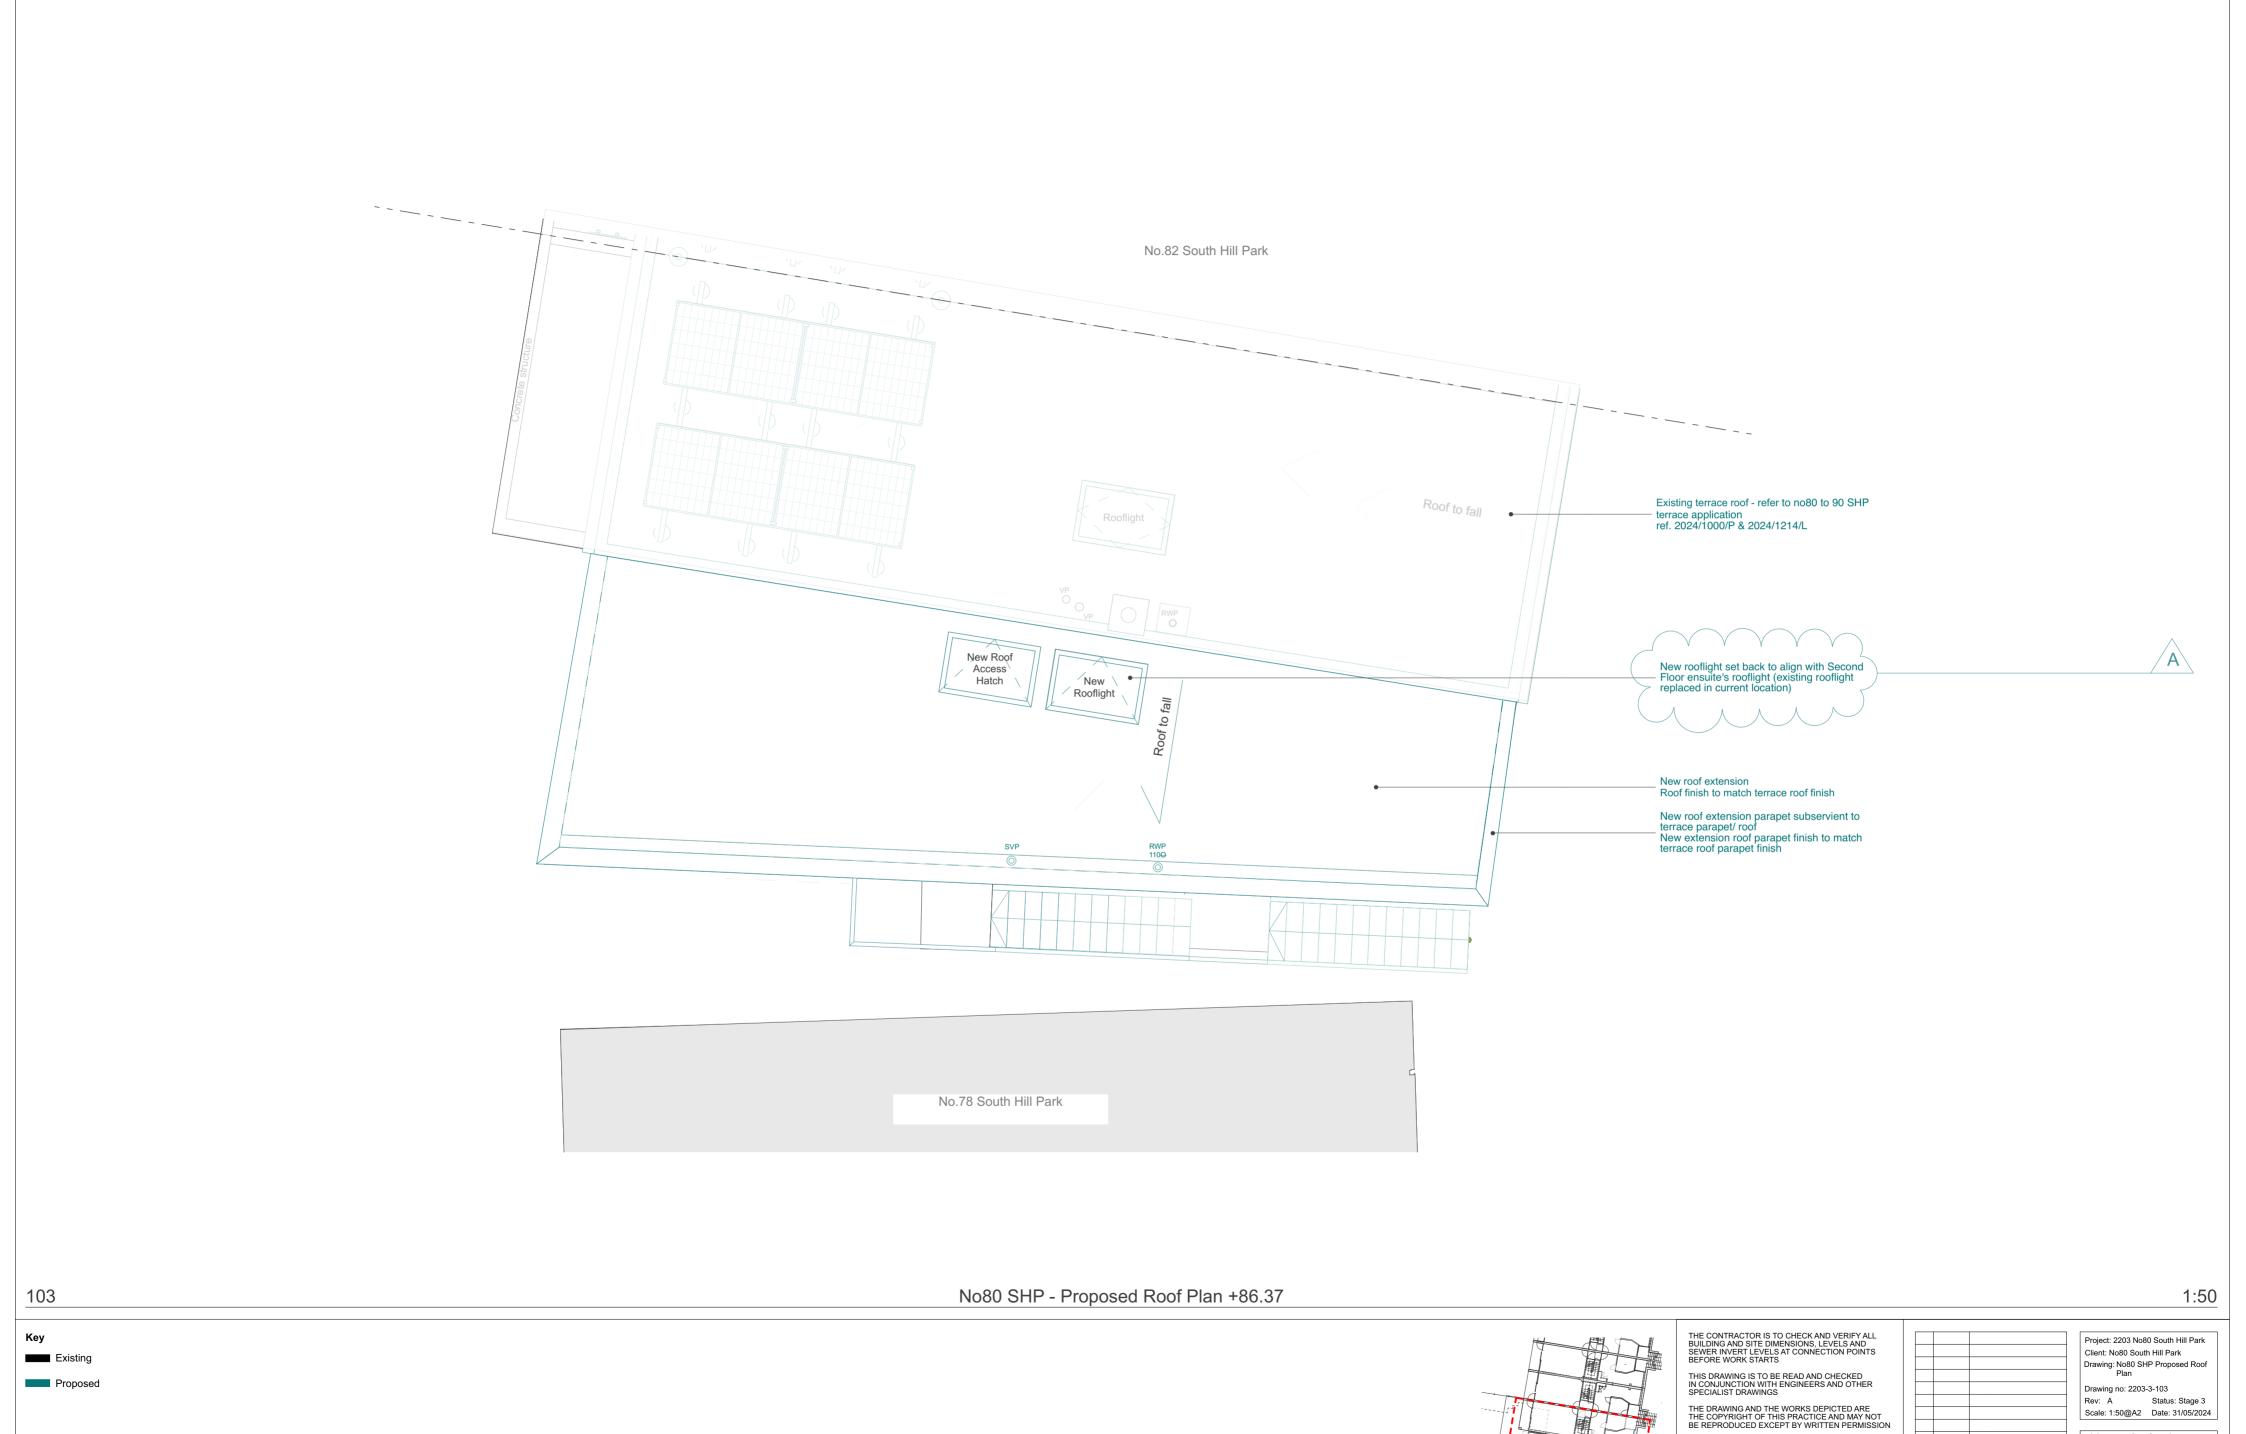


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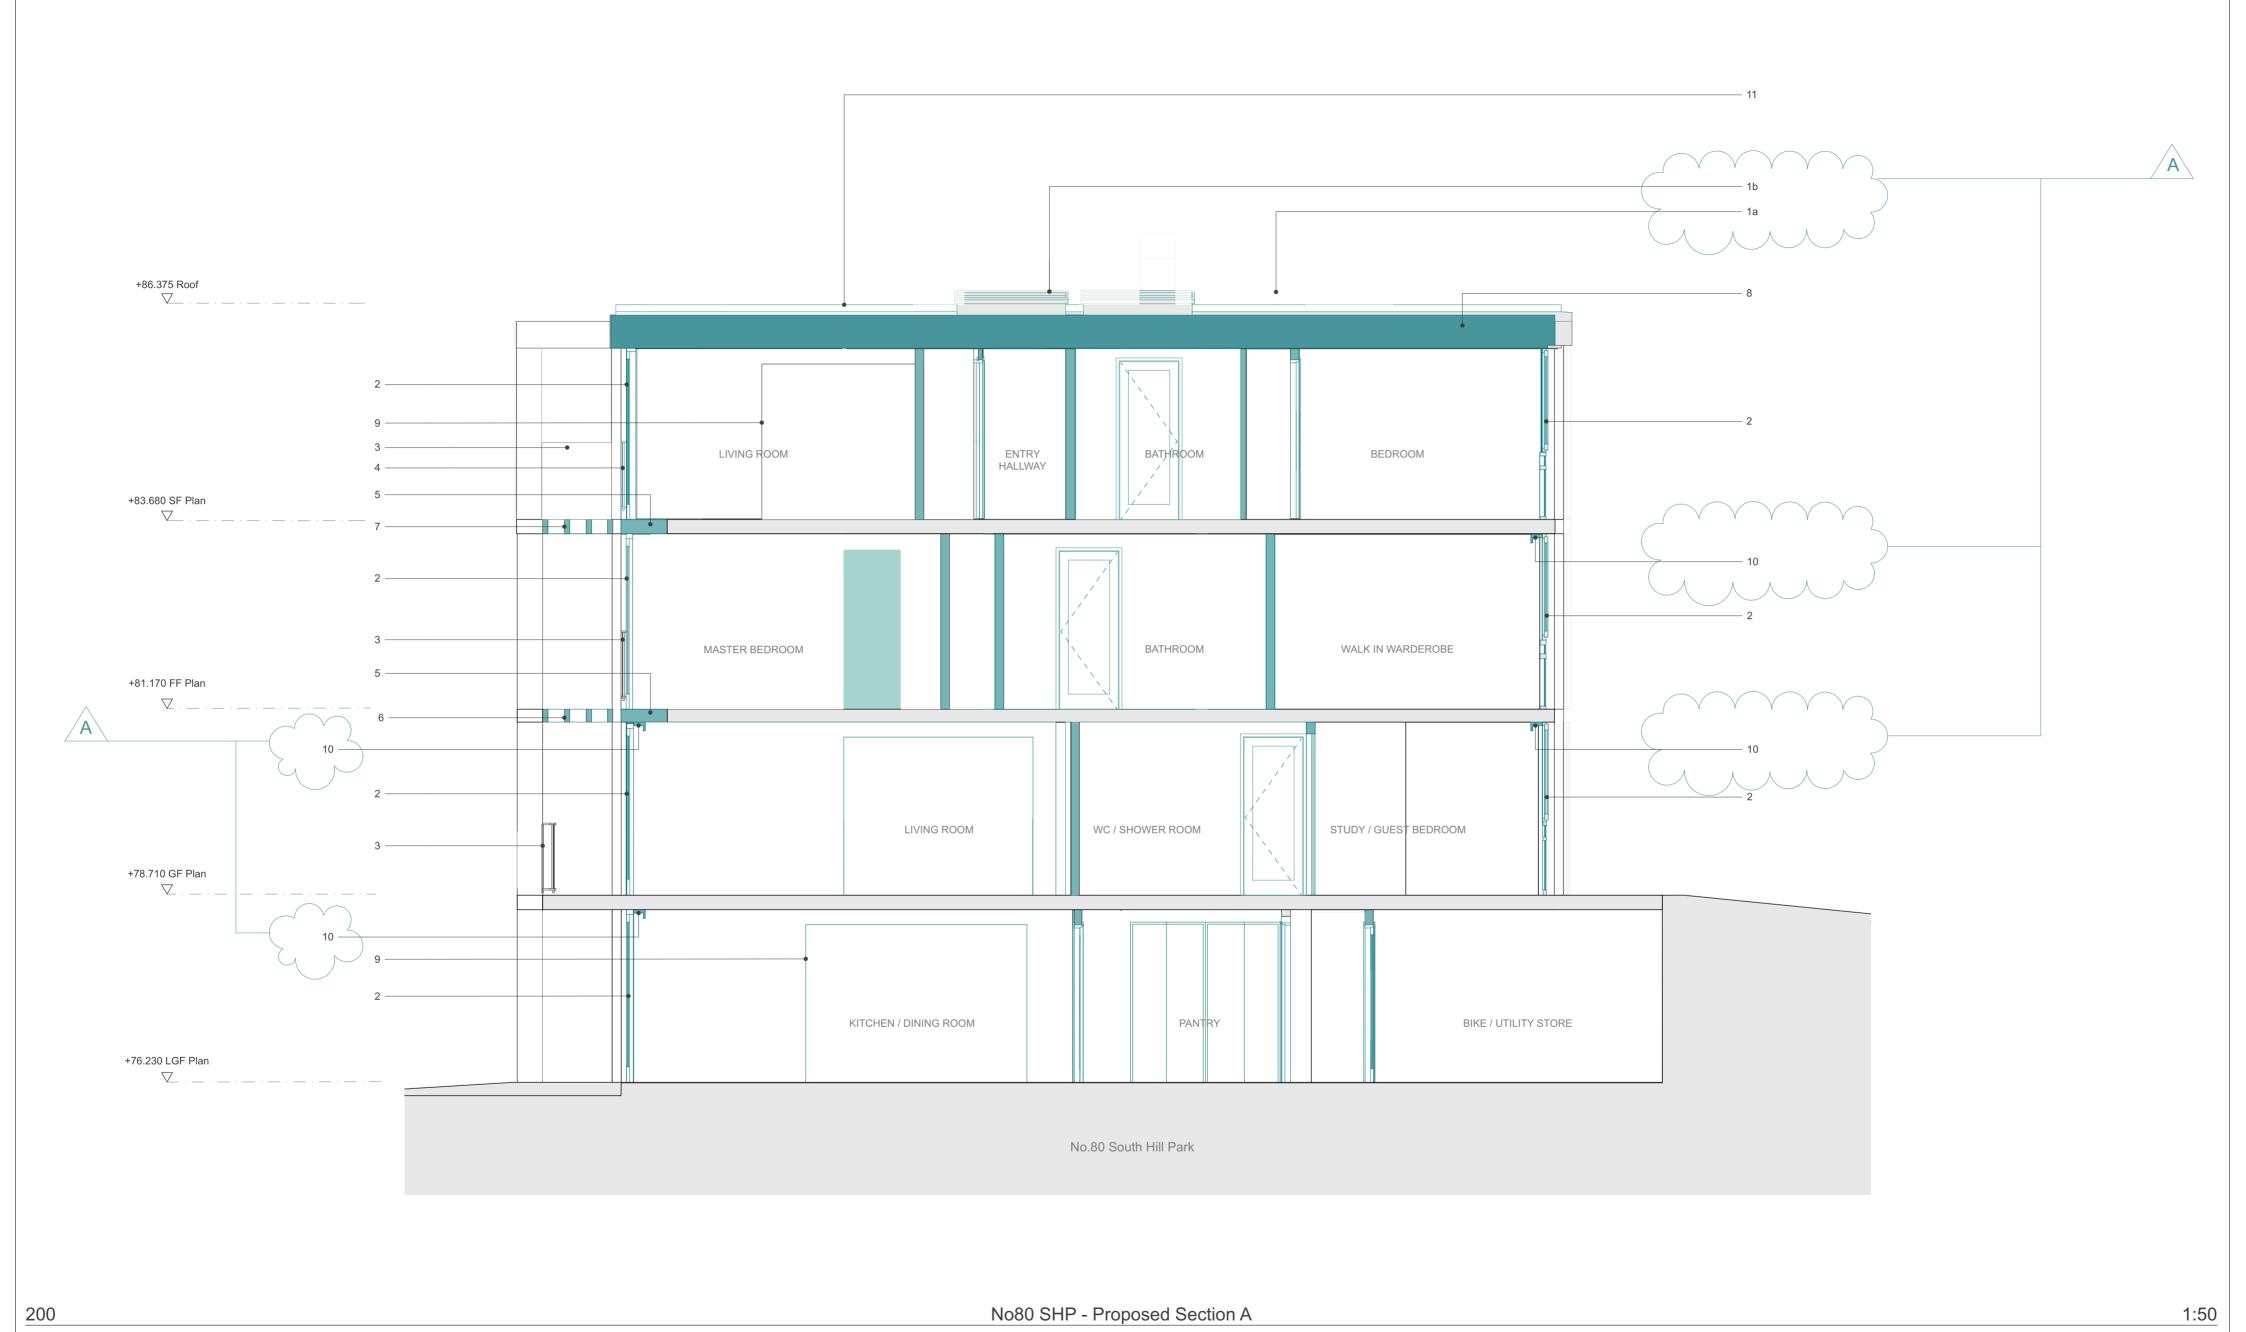


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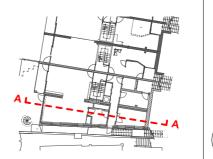


Key

Proposed

- across terrace
 3. Existing metal balustrade retained and refurbished
 4. New metal balustrade to match existing
 5. Floor infill to remove cold bridges and condensation/ leaks to Ground Floor
- 1a. Rooflight at front in new roof extension set back to align with existing rooflight location over Second Floor ensuite (existing rooflight replaced in existing location with new rooflight)
 1b. Roof access hatch in new roof extension
 2. New hardwood double glazed timber windows/ doors. Timber finish to match across terrace
- Living Room below

- Existing rotten brise soleis and timber post reinstated
 New brise soleis and timber post to match existing on floor below
 New flat roof extension subservient to terrace roof. Finish to match terrace roof
 New opening in masonry wall
 Insulated curtain head-box detail to align with the proposed insulation set back in plan, to help mitigating cold bridging at high level at the interface between the new timber window frames and the existing concrete slabs
 Terrace roof refer to terrace application ref. 2024/1000/P & 2024/1214/L

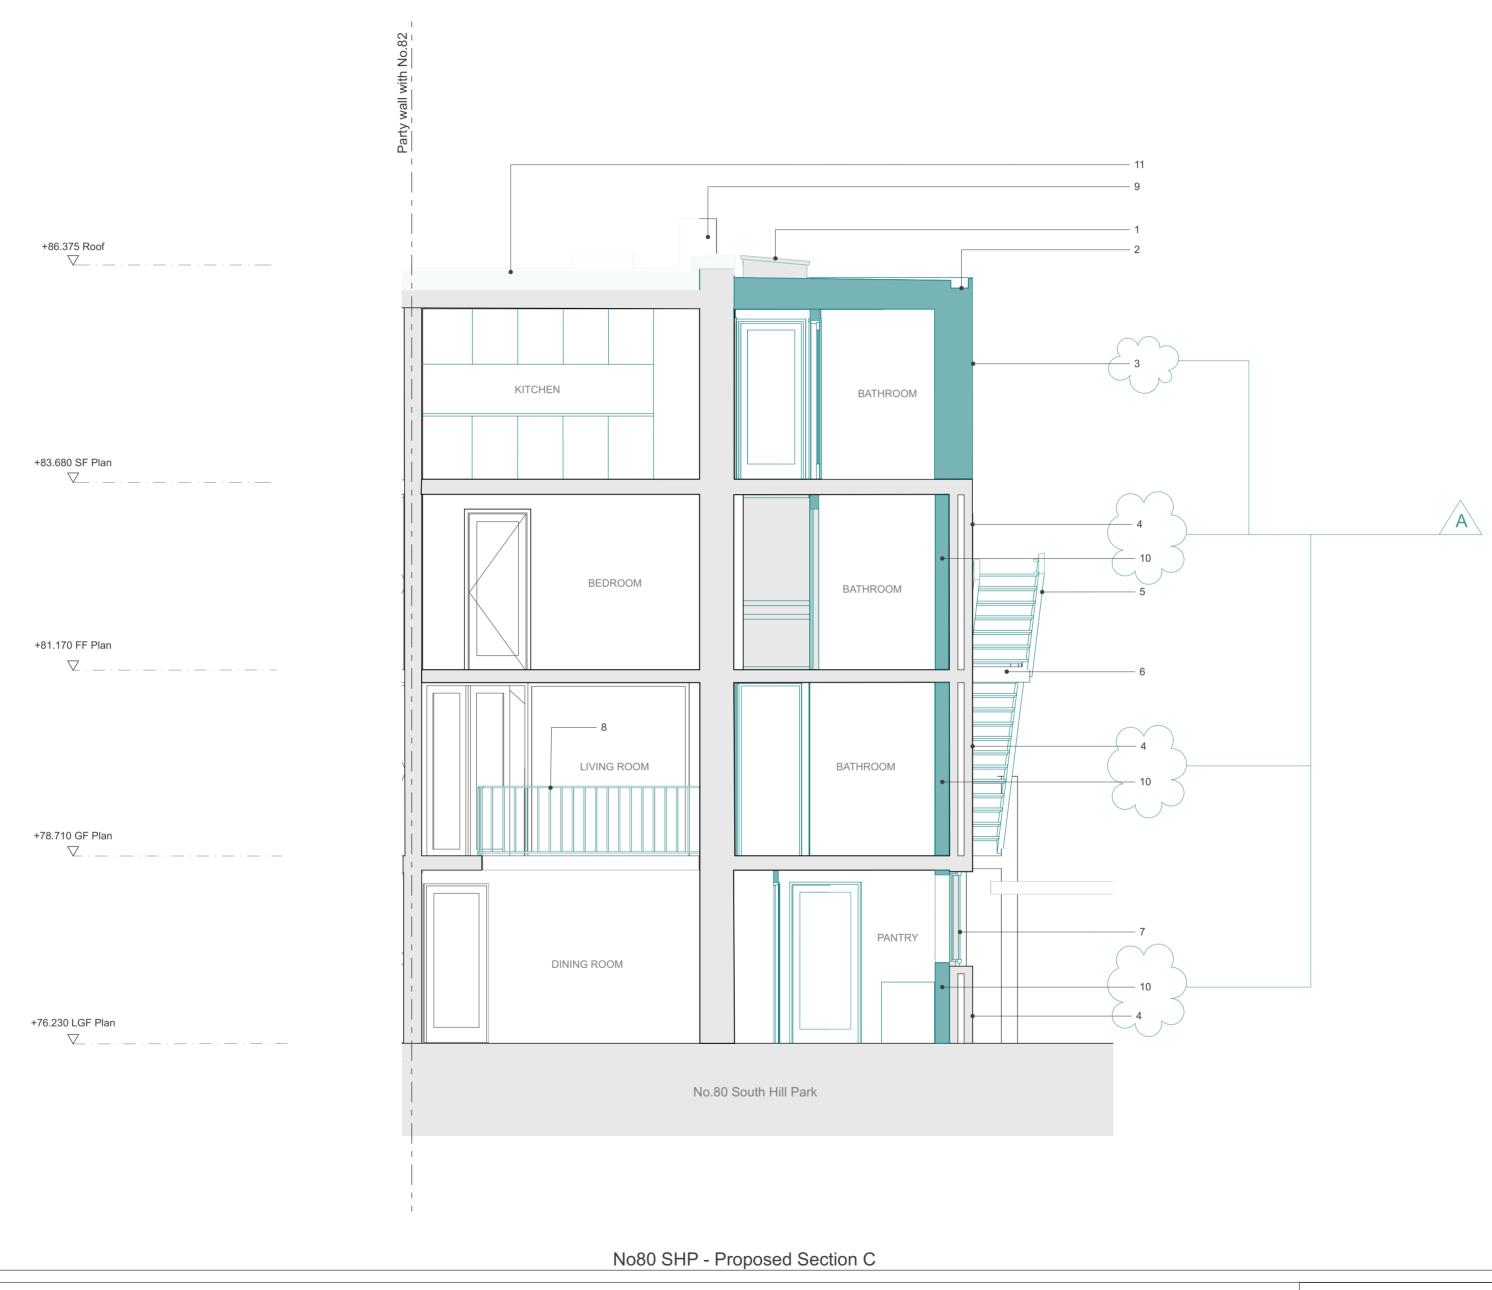


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Rev: Date:

Project: 2203 No80 South Hill Park Client: No80 South Hill Park Drawing: No80 SHP Proposed Section Drawing no: 2203-3-200 Rev: A Status: Stage 3 Scale: 1:50@A2 Date: 31/05/2024

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Key

202

Proposed

6. Existing concrete landing retained and strengthened

 Rooflight and roof access hatch in new roof extension
 Perimeter gutter to serve new flat roof extension. New RWP and SVP to drop in new vertical riser against flank wall and to connect at Lower Ground Floor to

existing drain system
3. New flank wall of roof extension to align with floors below. External wall finish

to match existing brickwork

4. Existing brickwork and exposed concrete slabs repaired

5. New steel stair flights and strengthening structure to retained concrete landings to side of no.80

7. New hardwood double glazed timber windows/ doors. Timber finish to match

8. Internal timber balustrade and double height reinstated in its original location

Existing chimney refurbished
 New internal permeable insulation to un-insulated flank cavity wall to improve

the existing thermal building performances, with permeable internal plaster finish
11. Terrace roof - refer to terrace application ref. 2024/1000/P & 2024/1214/L

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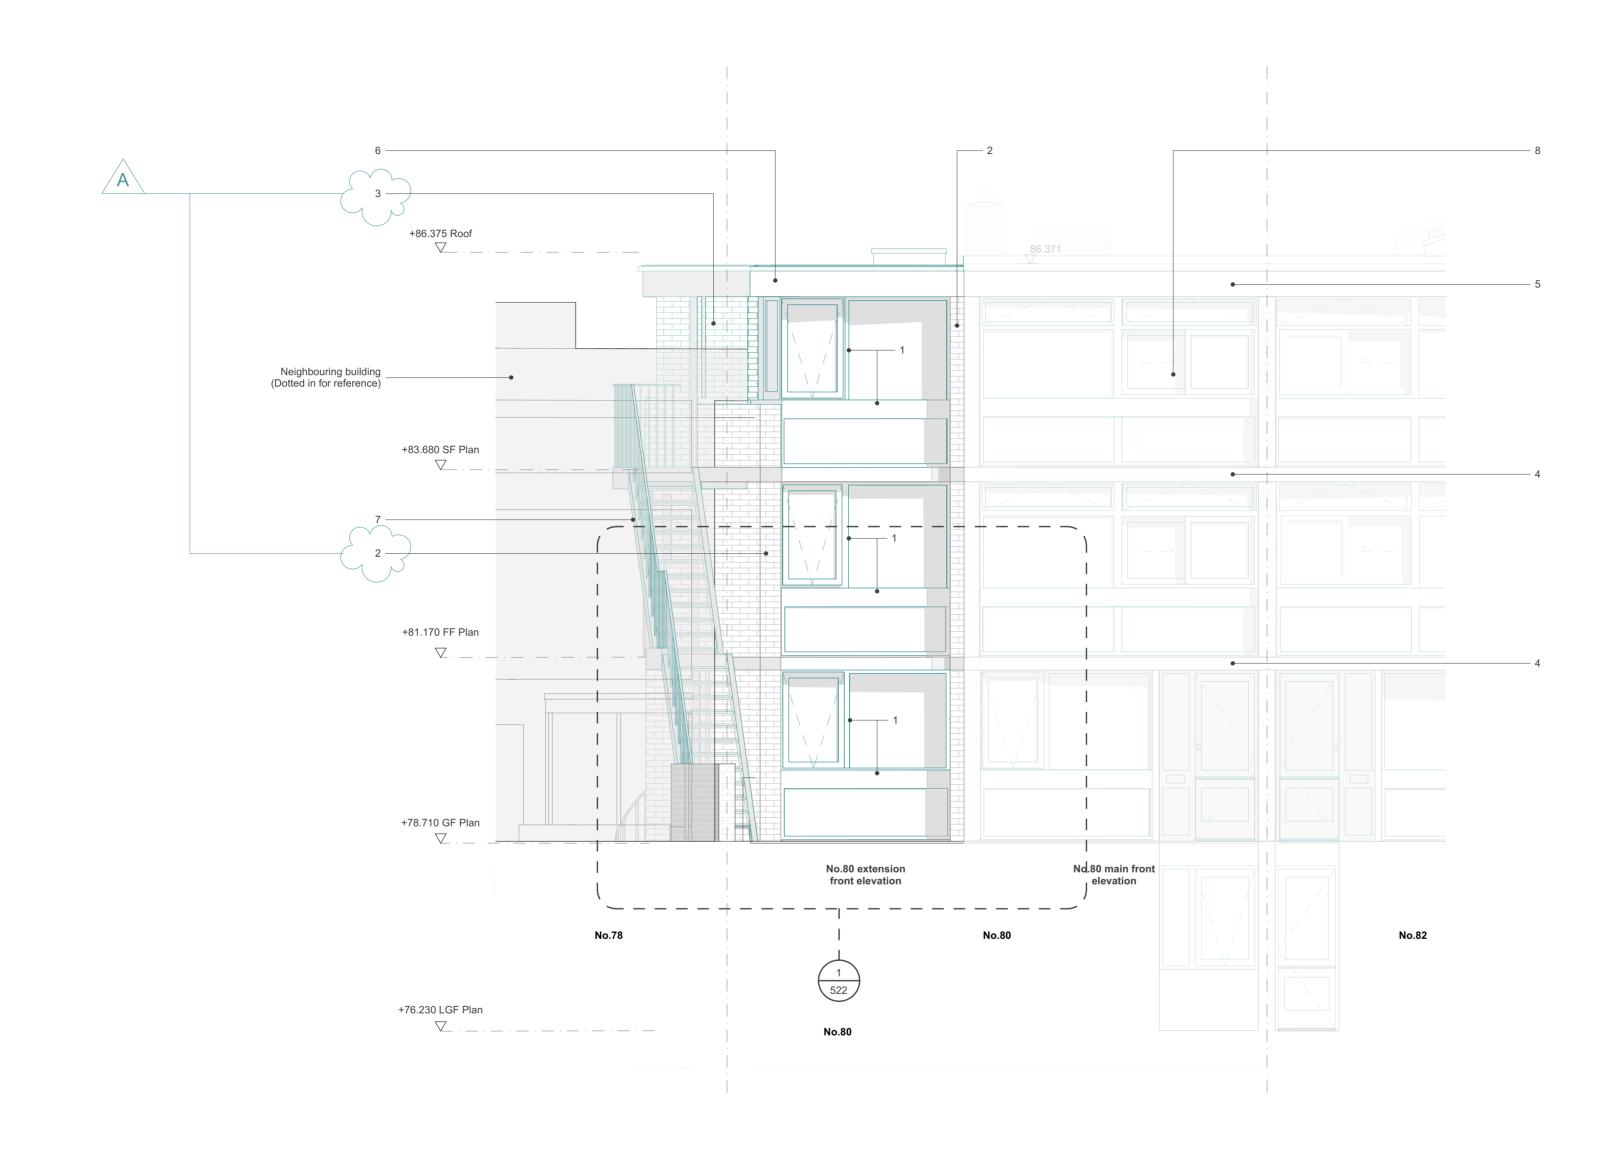
Project: 2203 No80 South Hill Park

Rev: Date:

Client: No80 South Hill Park Drawing: No80 SHP Proposed Section Drawing no: 2203-3-202 Rev: A Status: Stage 3 Scale: 1:50@A2 Date: 31/05/2024

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No80 SHP - Proposed Elevation

Key

301

Proposed

New hardwood timber framed windows to match original design from 1950s.
 Double glazing to improve the existing thermal building performances
 Existing brickwork and exposed concrete slabs repaired
 External wall finish to new second floor extension flank wall to match existing

brickwork from floors below Existing concrete slab

Existing concrete siab
 Existing concrete edge beam
 New concrete edge beam to no80 extension to match existing terrace edge beam
Roof extension to be subservient to main terrace roof
 New steel staircase and strengthening structure to retained concrete landings to side
of no.80
 Terrace elevation and terrace roof - refer to terrace application ref. 2024/1000/P &
2024/1214/L

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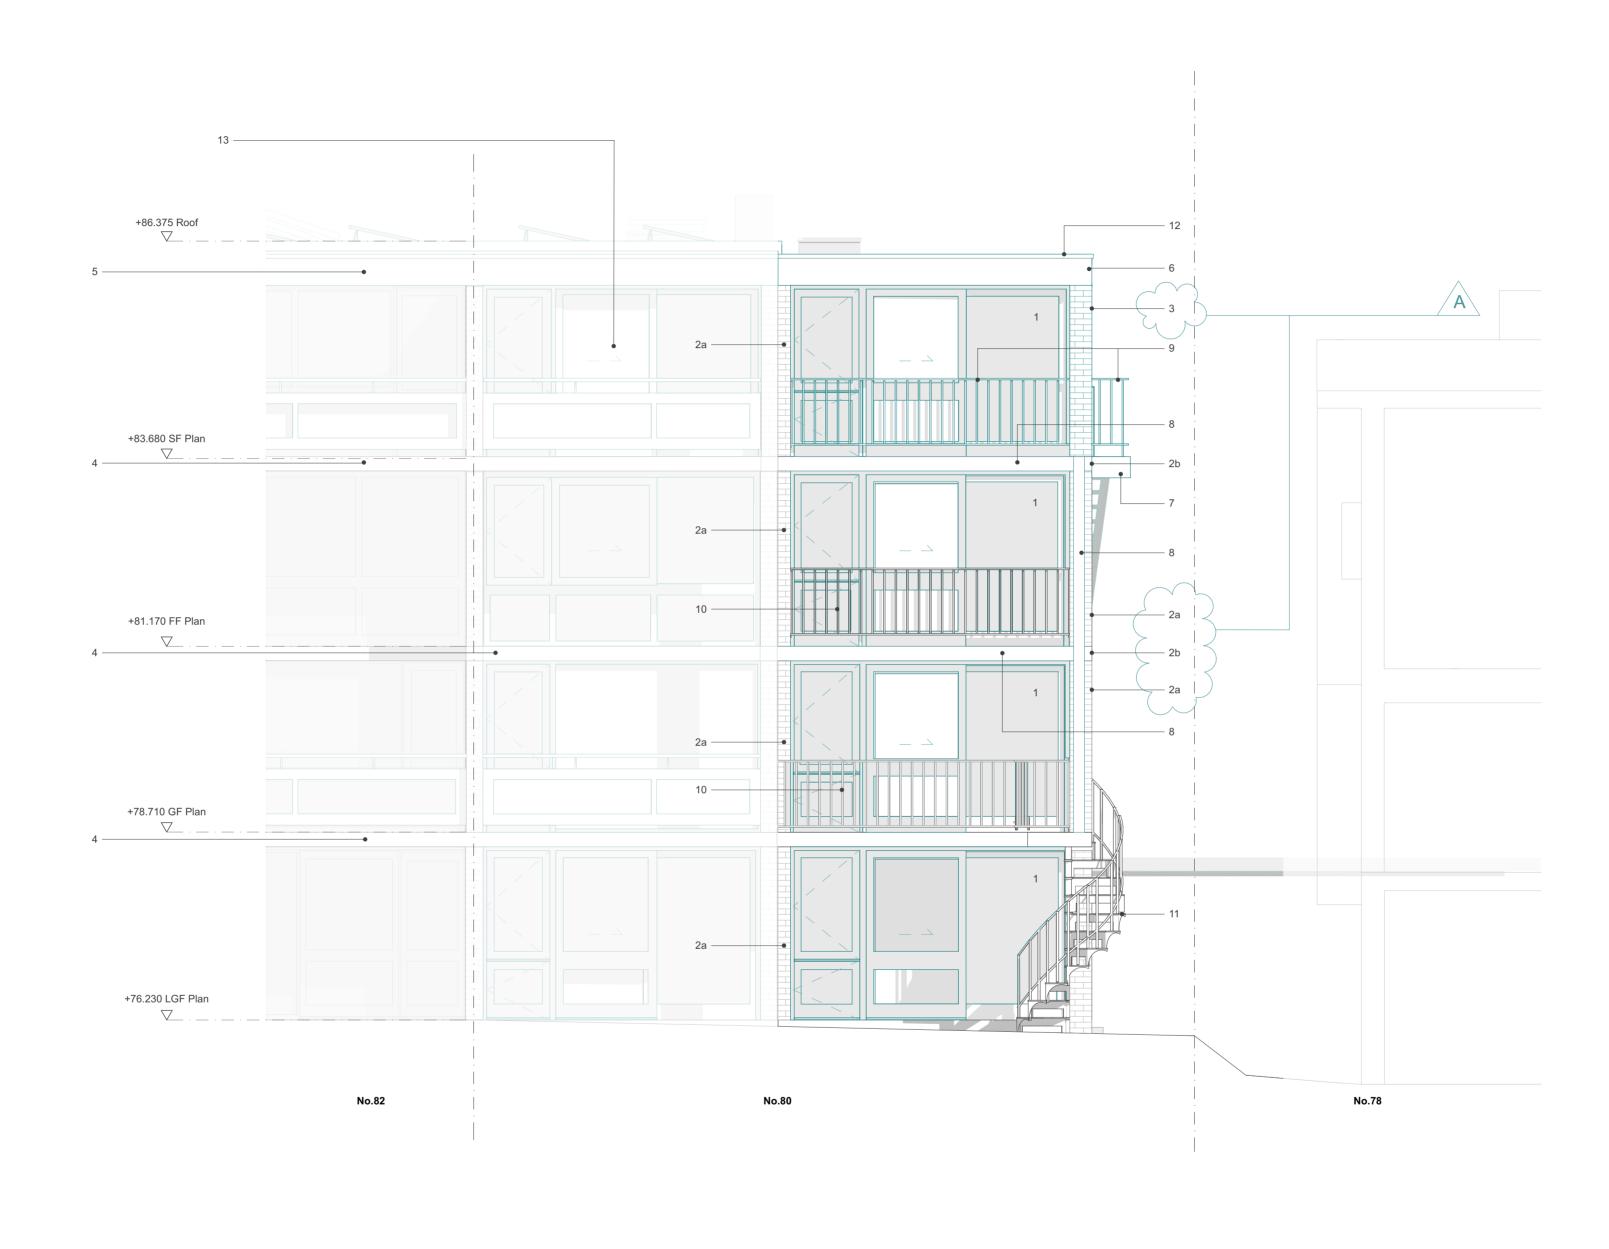
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Project: 2203 No80 South Hill Park Client: No80 South Hill Park
Drawing: No80 SHP Proposed Front
Elevation Drawing no: 2203-3-301 Rev: A Status: Stage 3 Scale: 1:50@A2 Date: 31/05/2024

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302

No80 SHP - Proposed Rear Elevation

Project: 2203 No80 South Hill Park Client: No80 South Hill Park Drawing: No80 SHP Proposed Rear Elevation

1:50 - A -28/05/24

Key

Proposed

1. New hardwood timber framed windows to match original design from 1950s.

Double glazing to improve the existing thermal building performances

2a. Existing brickwork repaired

Existing exposed concrete slab repaired
 External wall finish to new second floor extension flank wall to match existing

brickwork from floors below

Existing concrete slab

5. Existing concrete slab
5. Existing concrete edge beam
6. New concrete edge beam to no80 extension to match existing terrace edge beam
7. New steel staircase flights to replace dilapidated timber stairs and strengthening structure to retained concrete landings to side of no.80

- 8. Existing rotten brise soleis and timber post reinstated
- 9. New metal railing to match existing
- 10. Existing metal railing retained and refurbished
 11. Existing cast iron spiral stairs and metal railings refurbished
 12. Roof edge flashing to new no80 extension to match terrace roof flashing
 13. Terrace elevation and terrace roof refer to terrace application ref. 2024/1000/P &



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Α	28/05/24	Planning
Rev.	Date:	Description

Drawing no: 2203-3-302 Rev: A Status: Stage 3 Scale: 1:50@A2 Date: 31/05/2024 citizens **design** bureau

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303

No80 SHP - Proposed Side Elevation

Project: 2203 No80 South Hill Park Client: No80 South Hill Park

1:50

Key

Proposed

New hardwood timber framed windows to match original design from 1950s.
 Double glazing to improve the existing thermal building performances
 Existing brickwork repaired
 Existing exposed concrete slab repaired
 External wall finish to new second floor extension flank wall to match existing brickwork from floors below.

brickwork from floors below 4. New steel staircase flights to replace dilapidated timber stairs and strengthening structure to retained concrete landings to side of no.80SHP 5. External stand alone MVHRs to wet areas
6. Metal flashing to window cill to match roof edge flashing 7. Existing rotten brise soleis and timber post reinstated 8. Existing metal railing retained

9. New metal railing to match existing
10. Existing cast iron spiral stairs and metal railings refurbished
11. Existing concrete edge beam
12. New concrete edge beam to no80 extension to match existing terrace concrete edge beam, with metal flashing to match terrace edge flashing detail



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Drawing: No80 SHP Proposed Side Elevation Drawing no: 2203-3-303 Rev: Date:

Rev: A Status: Stage 3 Scale: 1:50@A2 Date: 31/05/2024 citizens **design** bureau t: 0203 095 9732 w: www.citizensdesignb

