

PROPOSED

BASEMENT VOID

Revisions		
No.	Description	Dat
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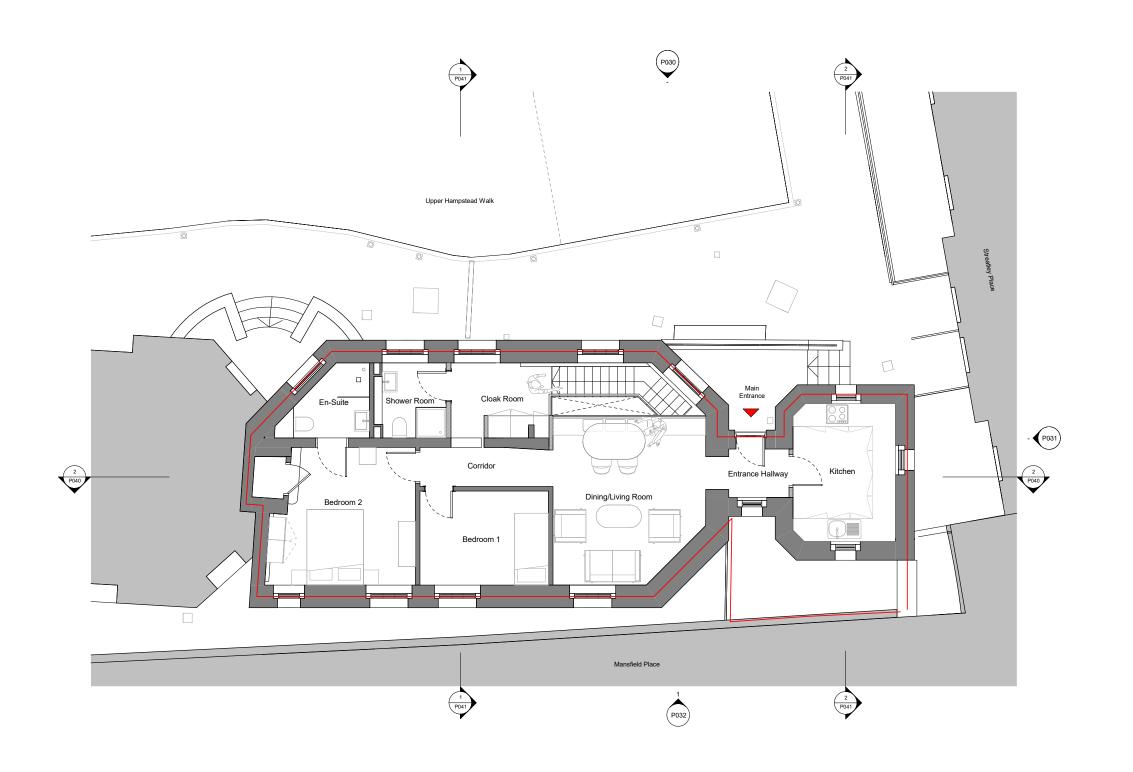
PROPOSED

5 m

T 020 3287 0086 E info@hatchandmason.com Job: Giles Building Job No: HM203

Drawing: Proposed Basement Plan Scale:1:50 @ A1, 1:100 @ A3 Drawing No: P009 Revision:

1:50 @ A1, 1:100 @ A3



PROPOSED

BASEMENT VOID

SITE BOUNDARY

Revisions		
No.	Description	Dat
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_		

PROPOSED

5 m

T 020 3287 0086 E info@hatchandmason.com Job: Giles Building Job No: HM203

JOD NO: HMZU3 Drawing: Proposed Ground Floor Plan Scale:1:50 @ A1, 1:100 @ A3 Drawing No: P010 Revision:

1:50 @ A1, 1:100 @ A3



PROPOSED

BASEMENT VOID

SITE BOUNDARY


PROPOSED

5 m

T 1020 3287 0066 E info@hatchandmason.com Job: Giles Building Job No: HM203

Drawing: Proposed Front Elevation

Scale:1:50 @ A1, 1:100 @ A3 Drawing No: P030 Revision:

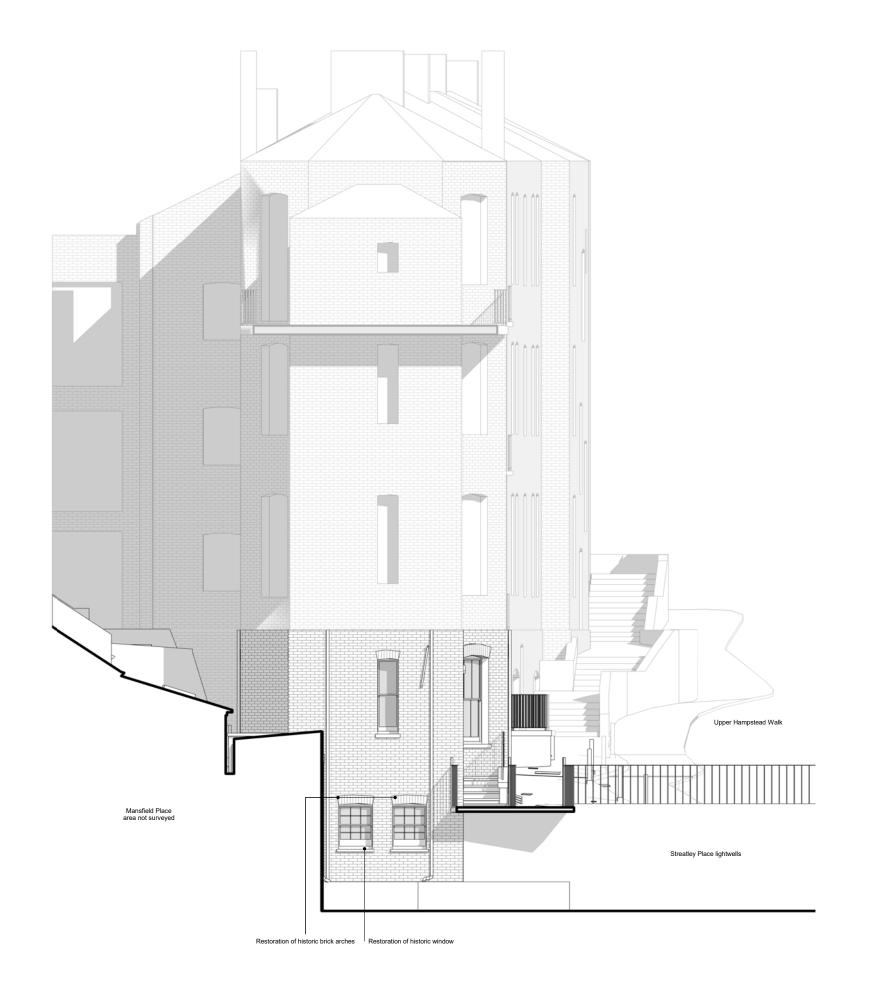

PROPOSED

BASEMENT VOID

SITE BOUNDARY

PROPOSED

Job: Giles Building Job No: HM203

Drawing: Proposed Side Elevation Scale:1:50 @ A1, 1:100 @ A3 Drawing No: P031 Revision:

P031 Proposed Side Elevation 1:50 @ A1, 1:100 @ A3

5 m



PROPOSED

BASEMENT VOID

SITE BOUNDARY

PROPOSED

5 m

Job: Giles Building Job No: HM203 Drawing: Proposed Rear Elevation

Scale:1:50 @ A1, 1:100 @ A3 Drawing No: P032 Revision:



NOT

Architectural Information - the level of detail shown or the drawings is relative to the submission of a PLANNING APPLICATION. The drawings should therefore not be used for any other purpose without both the prior the agreement of

the architect, and subsequent checking / developme by others Dimensions and setting out - should be checked on

Structure & Construction – these drawings, unless expressly noted otherwise, have not been fully coordir with a Structural Engineer's input and show indicative construction build-up only

Building Control - the client / the contractor will liaise directly with Local Authority to ensure the project is

Planning - the client/ the contractor will ensure that the project is completed in accordance with the approved Planning drawings and take responsibility for the dischaof any planning conditions

Party Walls & Rights to Light – the client/ the contractor v ensure that any notices and consents required are obtain

reeholder / Leaseholder / Restricted covenants / Easeme

consents required are obtained before work commences

Archaeological & Ecological – the client/ the contractor will

NOTE:

ng Allowances will need to to ol as per Approved Docume lower

KEY

EXISTING

PROPOSED

BASEMENT VOID

SITE BOUNDARY

Revisions

No. Description Date

PROPOSED

Note: Do not scale from this drawing. A site by the contractor and to be his resp Hatch + Mason 203 Westminster Bridge Road London

London SE1 7FR T 020 3287 0066

Job: Giles Building
Job No: HM203
Drawing: Proposed Long Section

Scale:1:50 @ A1, 1:100 @ A3 Drawing No: P040 Revision:

