

Architectural Information - the level of detail shown on the drawings is relative to the submission of a PLANNING APPLICATION. The drawings should therefore not be used for any the architect, and subsequent checking / development by others. Dimensions and setting out - should be checked on site; see above

Structure & Construction – these drawings, unless expressly noted otherwise, have not been fully coordir with a Structural Engineer's input and show indicative construction build-up only

Building Control - the client / the contractor will liaise directly with Local Authority to ensure the project is completed in accordance with the Building Regulation

Planning - the client/ the contractor will ensure that the project is completed in accordance with the approved Planning drawings and take responsibility for the discharge of any planning conditions

Party Walls & Rights to Light – the client/ the contractor will ensure that any notices and consents required are obtained before work commences

Freeholder / Leaseholder / Restricted covenants / Easemen approvals - the client will ensure that any notices and consents required are obtained before work commences

Archaeological & Ecological – the client/ the contractor will ensure that any notices and consents required are obtained before work commences

NOTE: Glazing Allowances will need to be negotiated with Building Control as per Approved Document L1B Conservation of Fuel and Power

KEY

	EXISTING
$\square$	PROPOSED
	BASEMENT VOID
—	SITE BOUNDARY





Revisions Description Date No.


## EXISTING

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Hatch + Mason 203 Westminster Bridge Road London SE1 7FR

T 020 3287 0066 E info@hatchandmason.com Job: Giles Building Job No: HM203 Drawing: Existing Basement Plan

Scale:1:50 @ A1, 1:100 @ A3 Drawing No: E009 Revision:

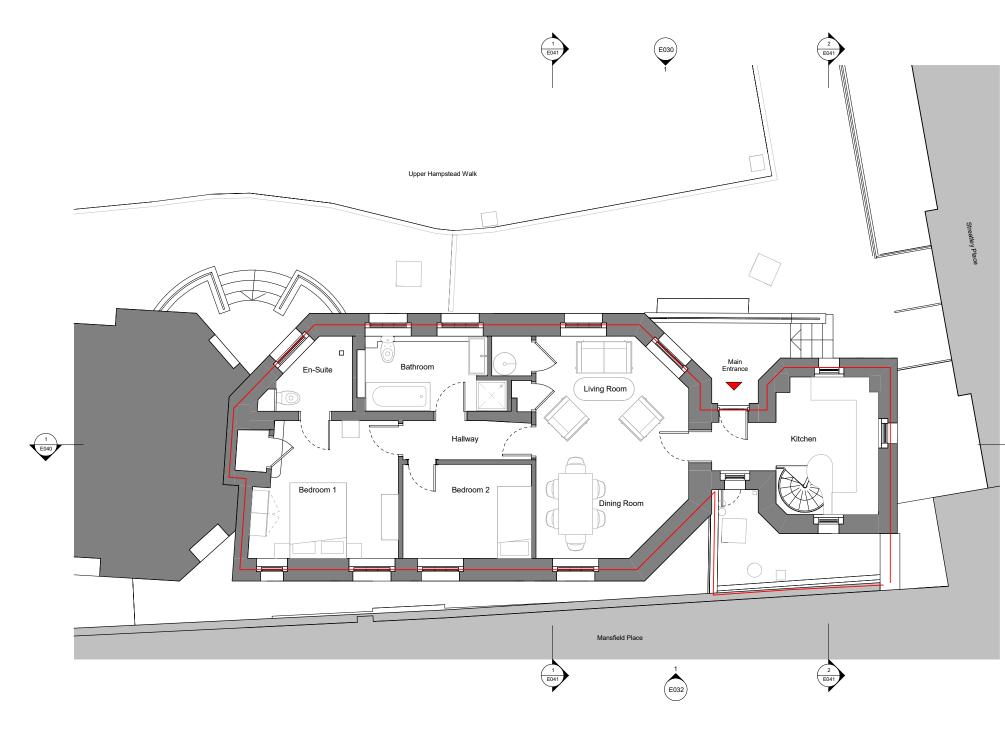

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Hatch + Mason 203 Westminster Bridge Road London SE1 7FR T 020 3287 0066 E info@hatchandmason.com Job: Giles Building Job No: HM203

Job No: HM2U3 Drawing: Existing Ground Floor Plan Scale:1:50 @ A1, 1:100 @ A3 Drawing No: E010 Revision:



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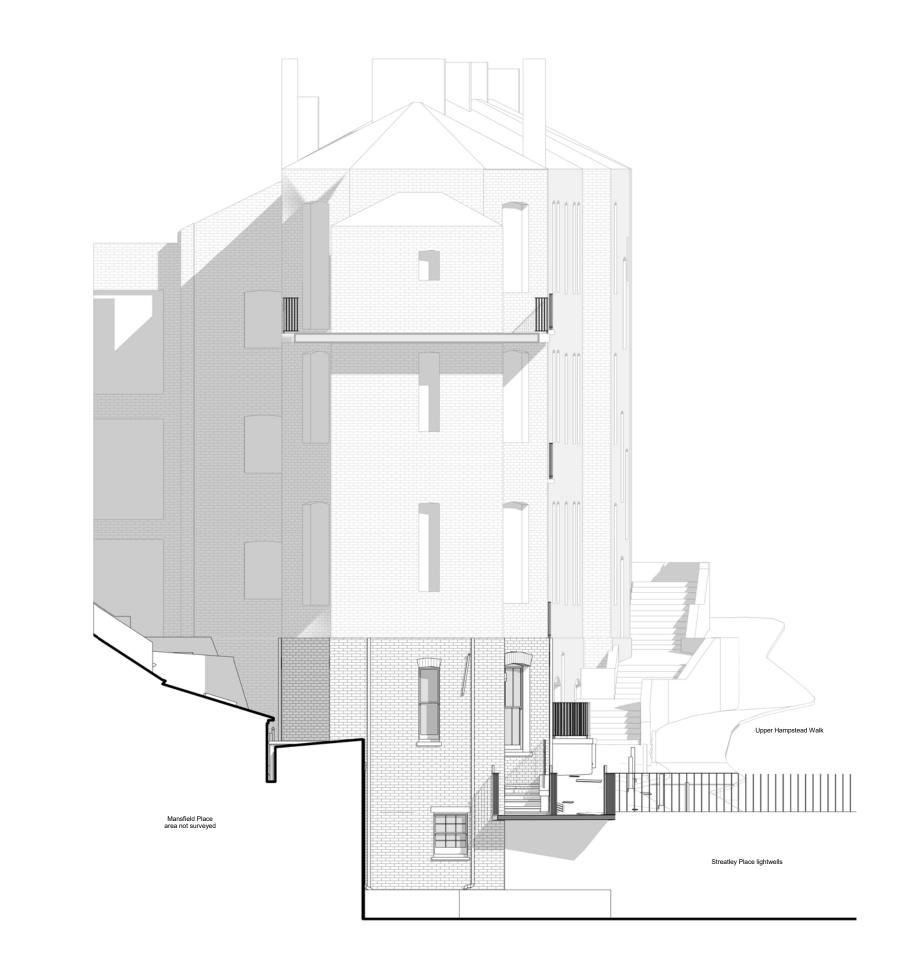
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T 020 3287 0066 E info@hatchandmason.com Job: Giles Building Job No: HM203

Drawing: Existing Front Elevation

Scale:1:50 @ A1, 1:100 @ A3 Drawing No: E030 Revision:



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T 020 3287 0066 E info@hatchandmason.com Job: Giles Building Job No: HM203

Drawing: Existing Side Elevation

Scale:1:50 @ A1, 1:100 @ A3 Drawing No: E031 Revision:



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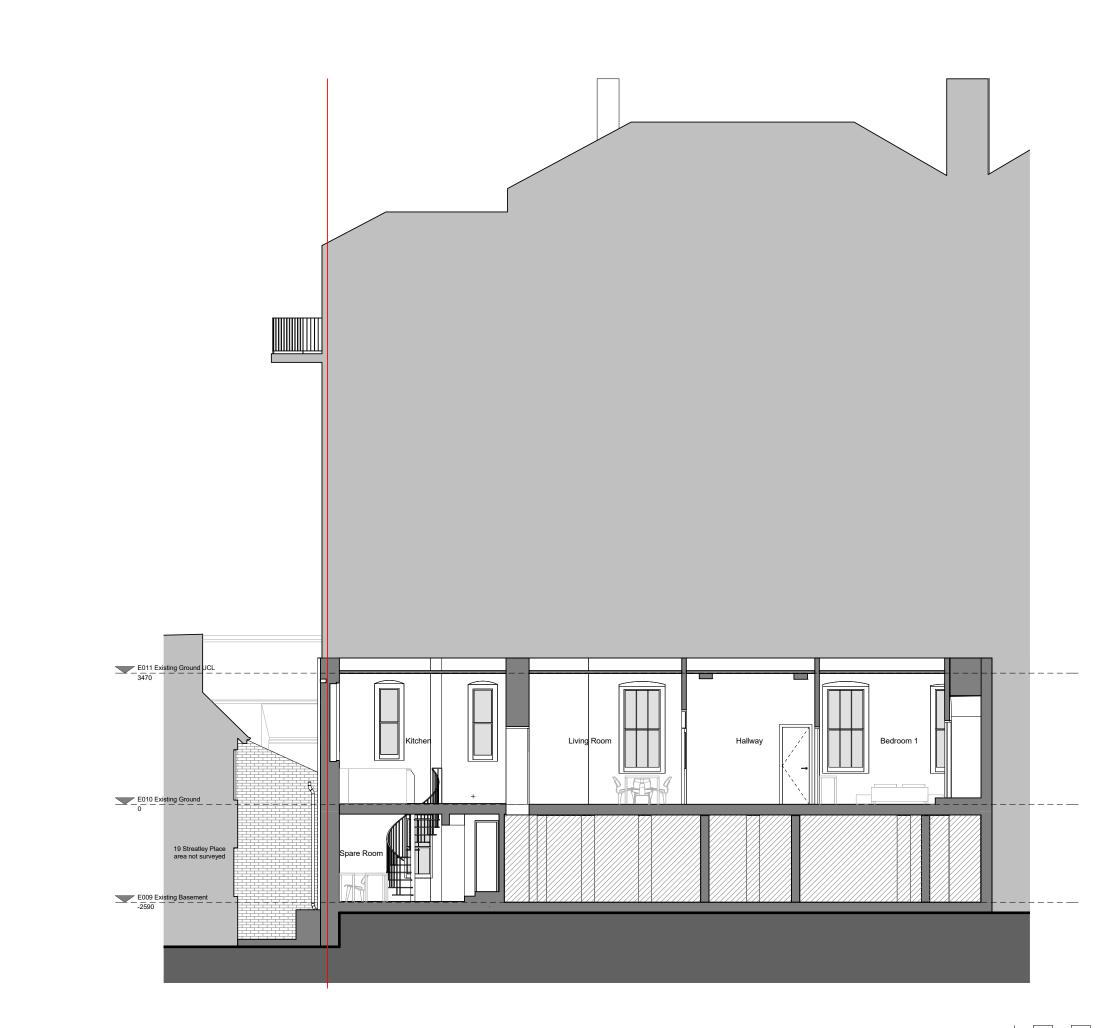
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T 020 3287 0066 E info@hatchandmason.com Job: Giles Building Job No: HM203

Drawing: Existing Rear Elevation

Scale:1:50 @ A1, 1:100 @ A3 Drawing No: E032 Revision:



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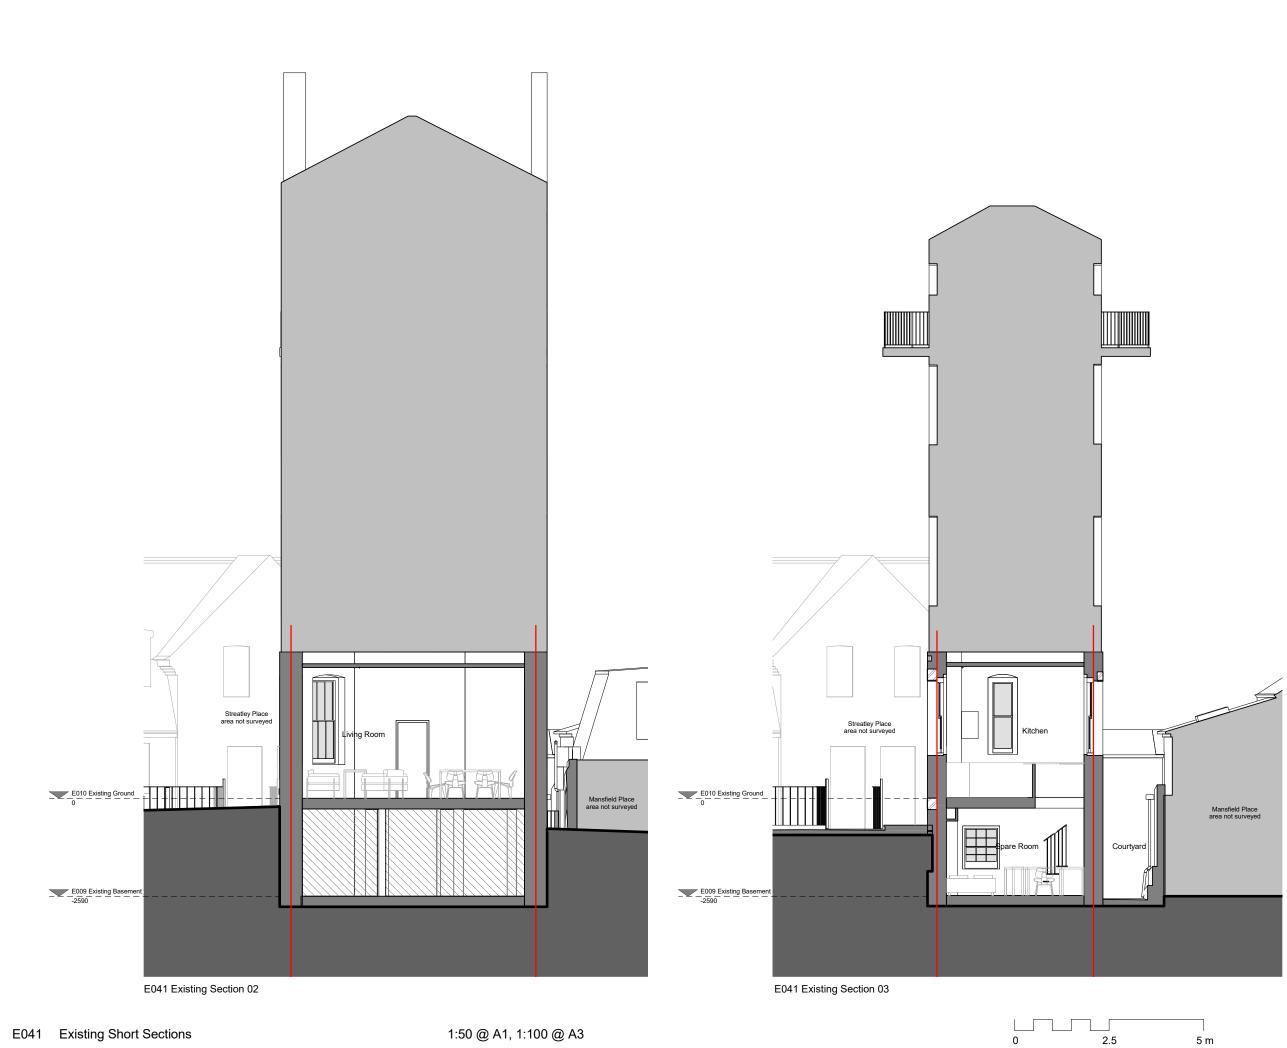
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E info@hatchandmason.com Job: Giles Building Job No: HM203

Drawing: Existing Long Section

Scale:1:50 @ A1, 1:100 @ A3 Drawing No: E040 Revision:



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Einfo@hatchandmason.com Job: Giles Building Job No: HM203

Drawing: Existing Short Sections

Scale:1:50 @ A1, 1:100 @ A3 Drawing No: E041 Revision: