



Note: Windows to North West Elevation brickwork are part of window type 'W2'. Please see schedule for full window detail.

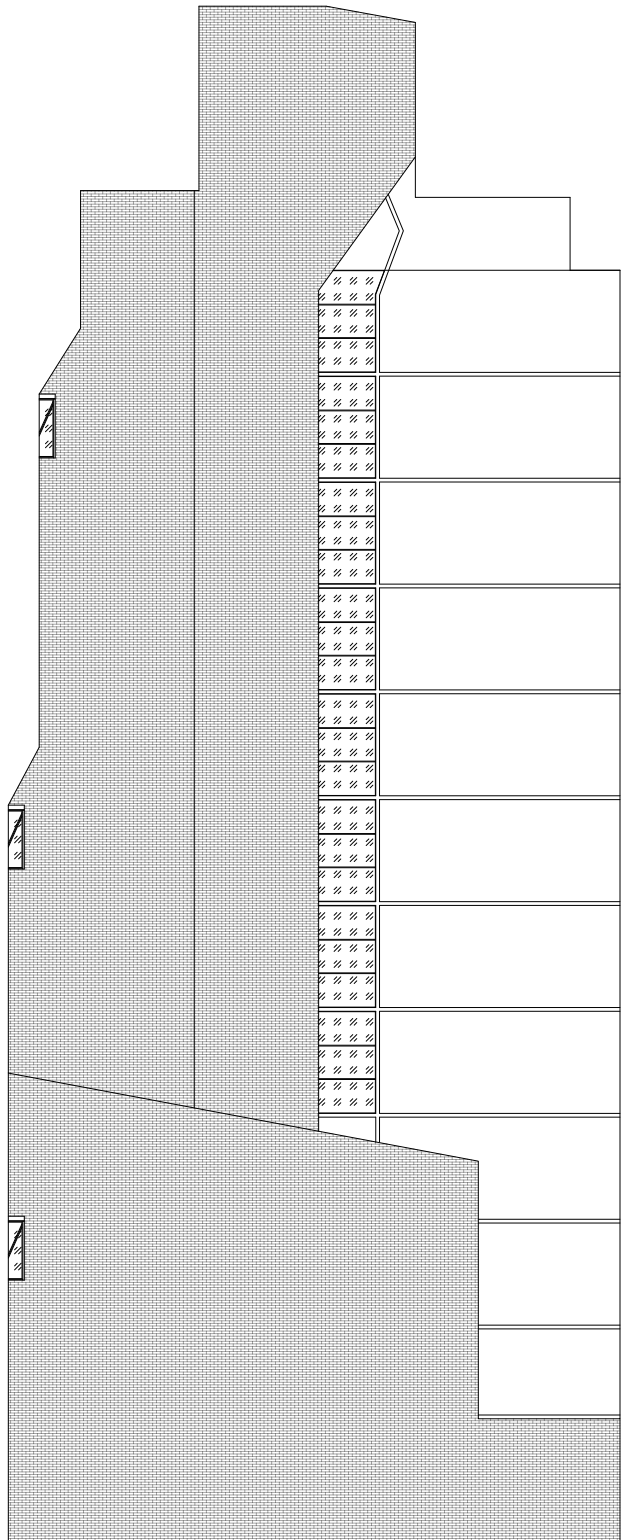

Street Level

PROPOSED NORTH-WEST ELEVATION:
1:200

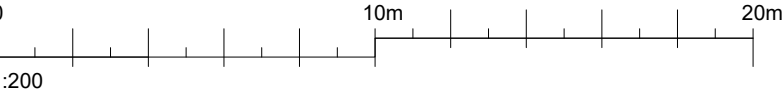

KEY:

-  Timber Framed
-  Aluminum Composite

The contractor is responsible to ensure that no products are to be utilised that do not comply with relevant British and/or European Standards and/or Codes of Practice, COSHH Regulations, Construction Regulations, or which are known or suspected at the time of product selection and/or construction to be deleterious to health and safety or to the durability of the work or not in accordance with good building practices.

The contractor is responsible for checking dimensions, tolerances, levels and references. This drawing is to be read in conjunction with all relevant consultants or specialists drawings. Any discrepancy is to be notified to Baily Garner LLP and rectified before proceeding with the works on site or shop drawings.

Where an item is covered by drawings to different scales, the larger scale drawing is to be worked to.

Do not scale drawings. Figured dimensions to be worked to in all cases.

This drawing and the copyrights and patents therein are the property of Baily Garner LLP and may not be used or reproduced without consent or attribution.

A3

CLIENT: London Borough of Camden		PROJECT: Roof and Window Replacement Works	
ADDRESS: Ellerton, Mill Lane London NW6 1LX		TITLE: Proposed North-West Elevation	
		PURPOSE OF ISSUE: Planning	
SCALE: 1:200	D CV	C MW	DATE 06/2024
JOB NO. 34656	DRAWING No. P 05		REVISION Rev A

**BAILY
GARNER**

146-148 ELTHAM HILL
LONDON SE9 5DY
t. 020 8294 1000
f. 020 8294 1320
e. general@bailygarner.co.uk