





123007-WGI-ZZ-ZZ-M3-0002 - Architects Model - P03

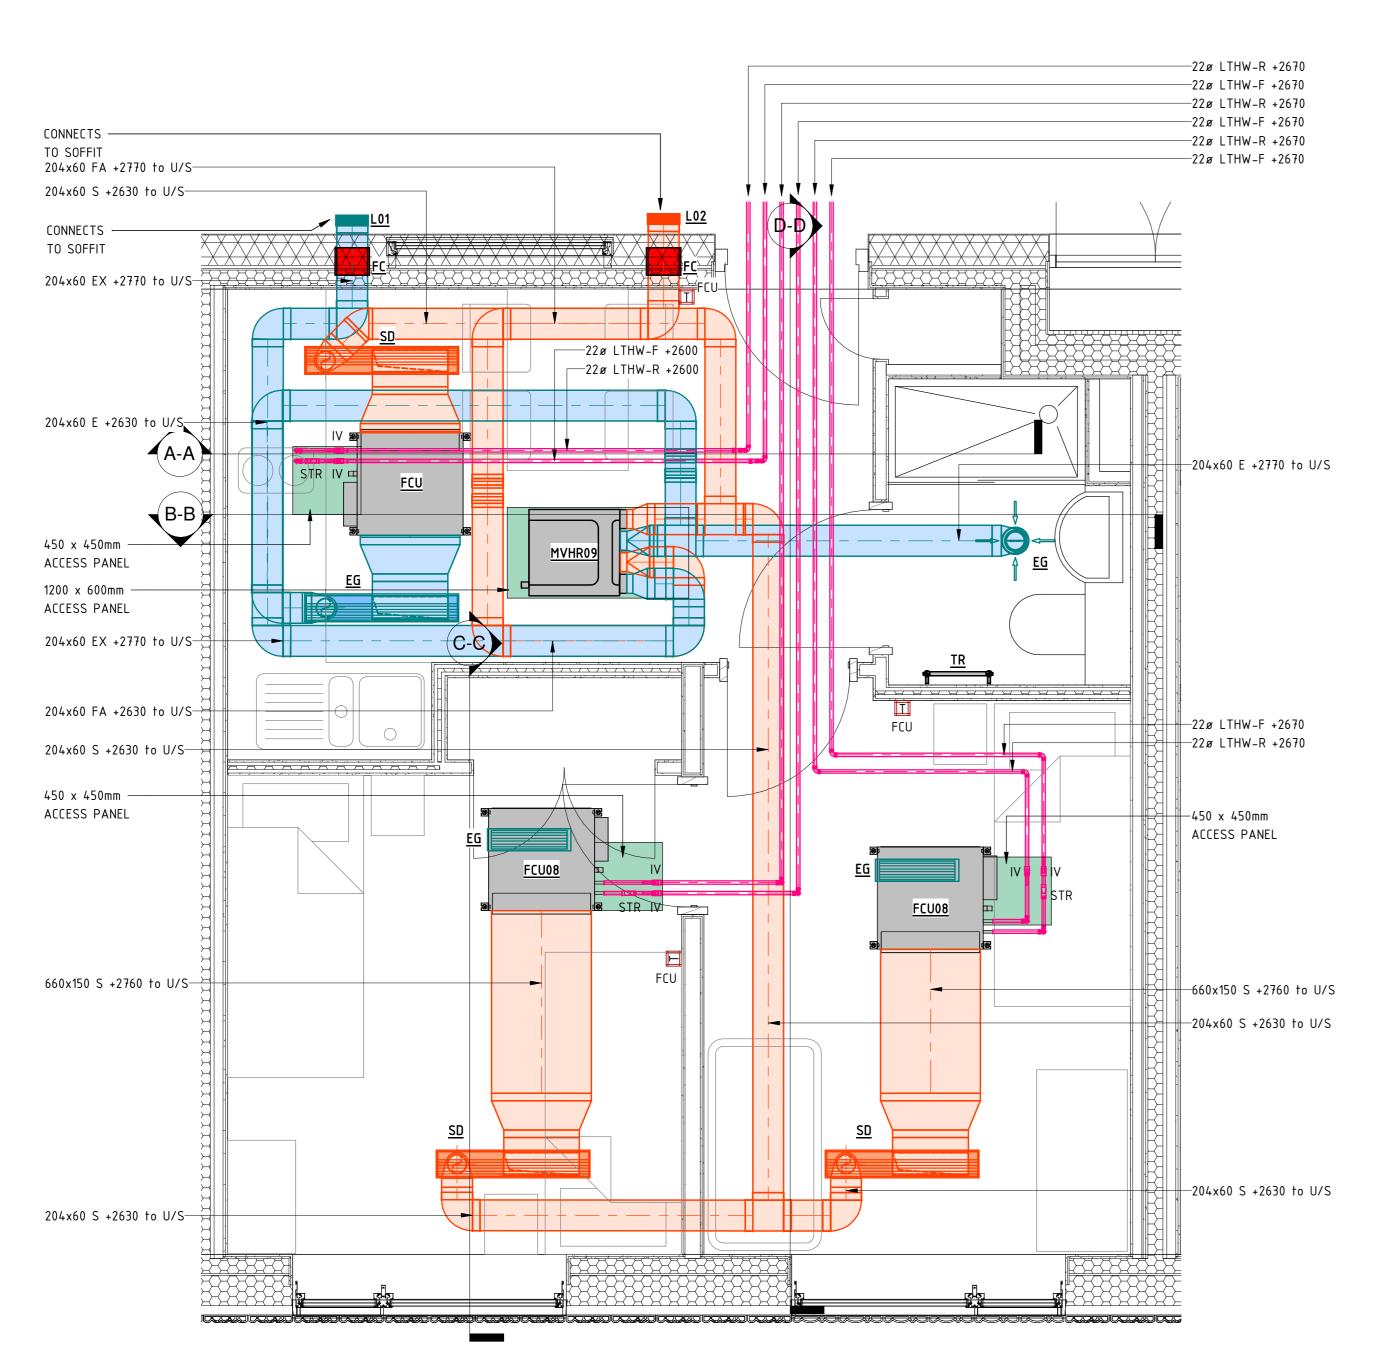


<u>01 First Floor – Typical 1 Bed Unit – Ventilation & Heating</u> SCALE 1:25

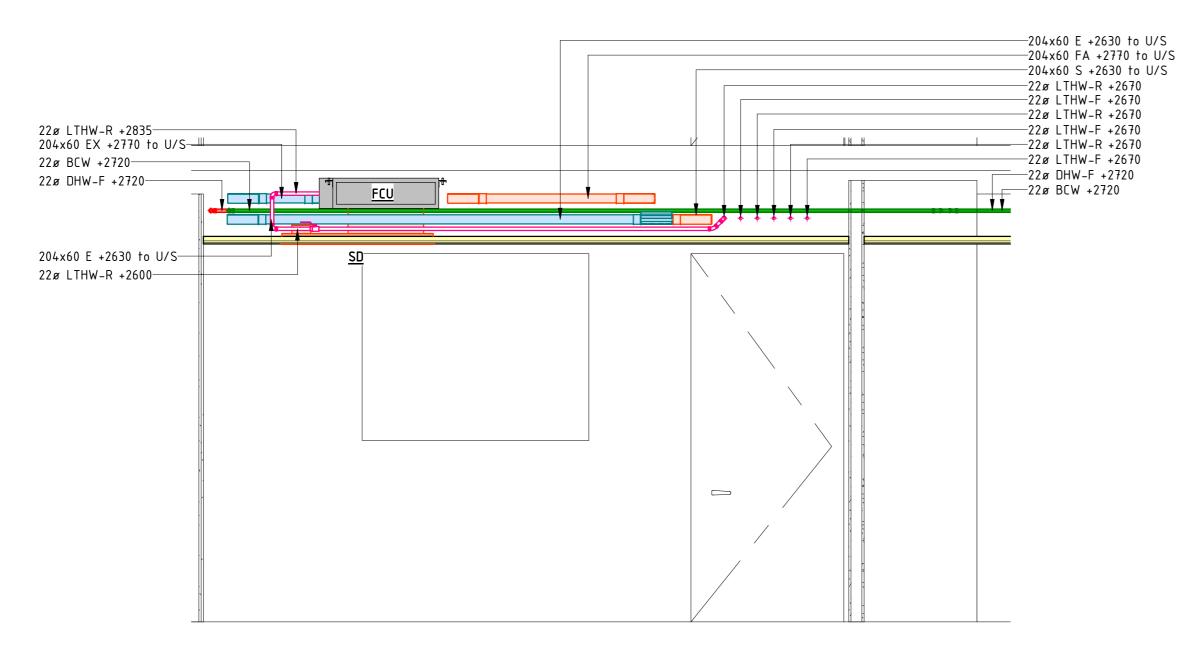


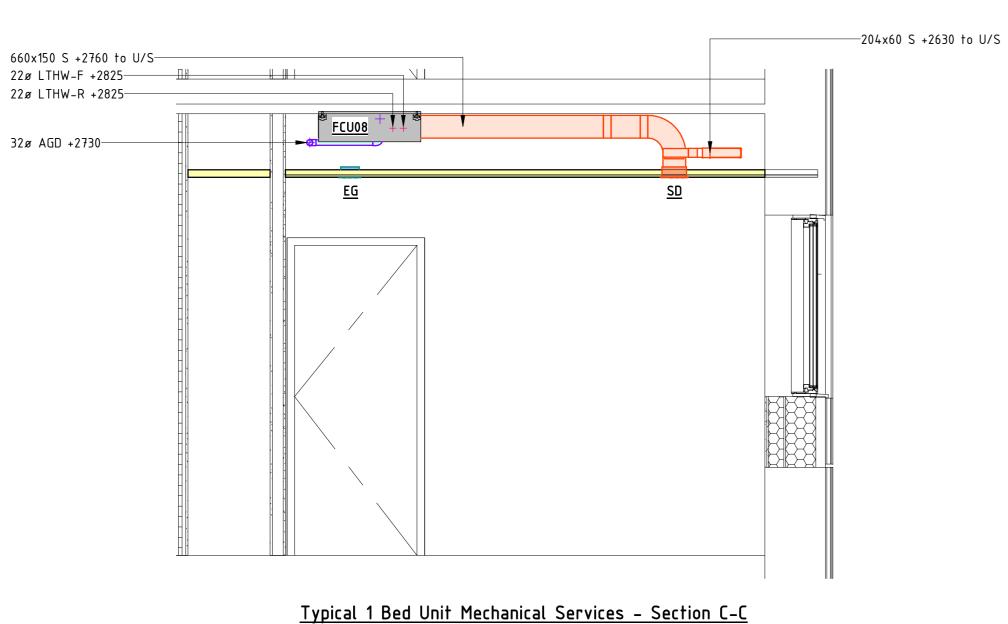

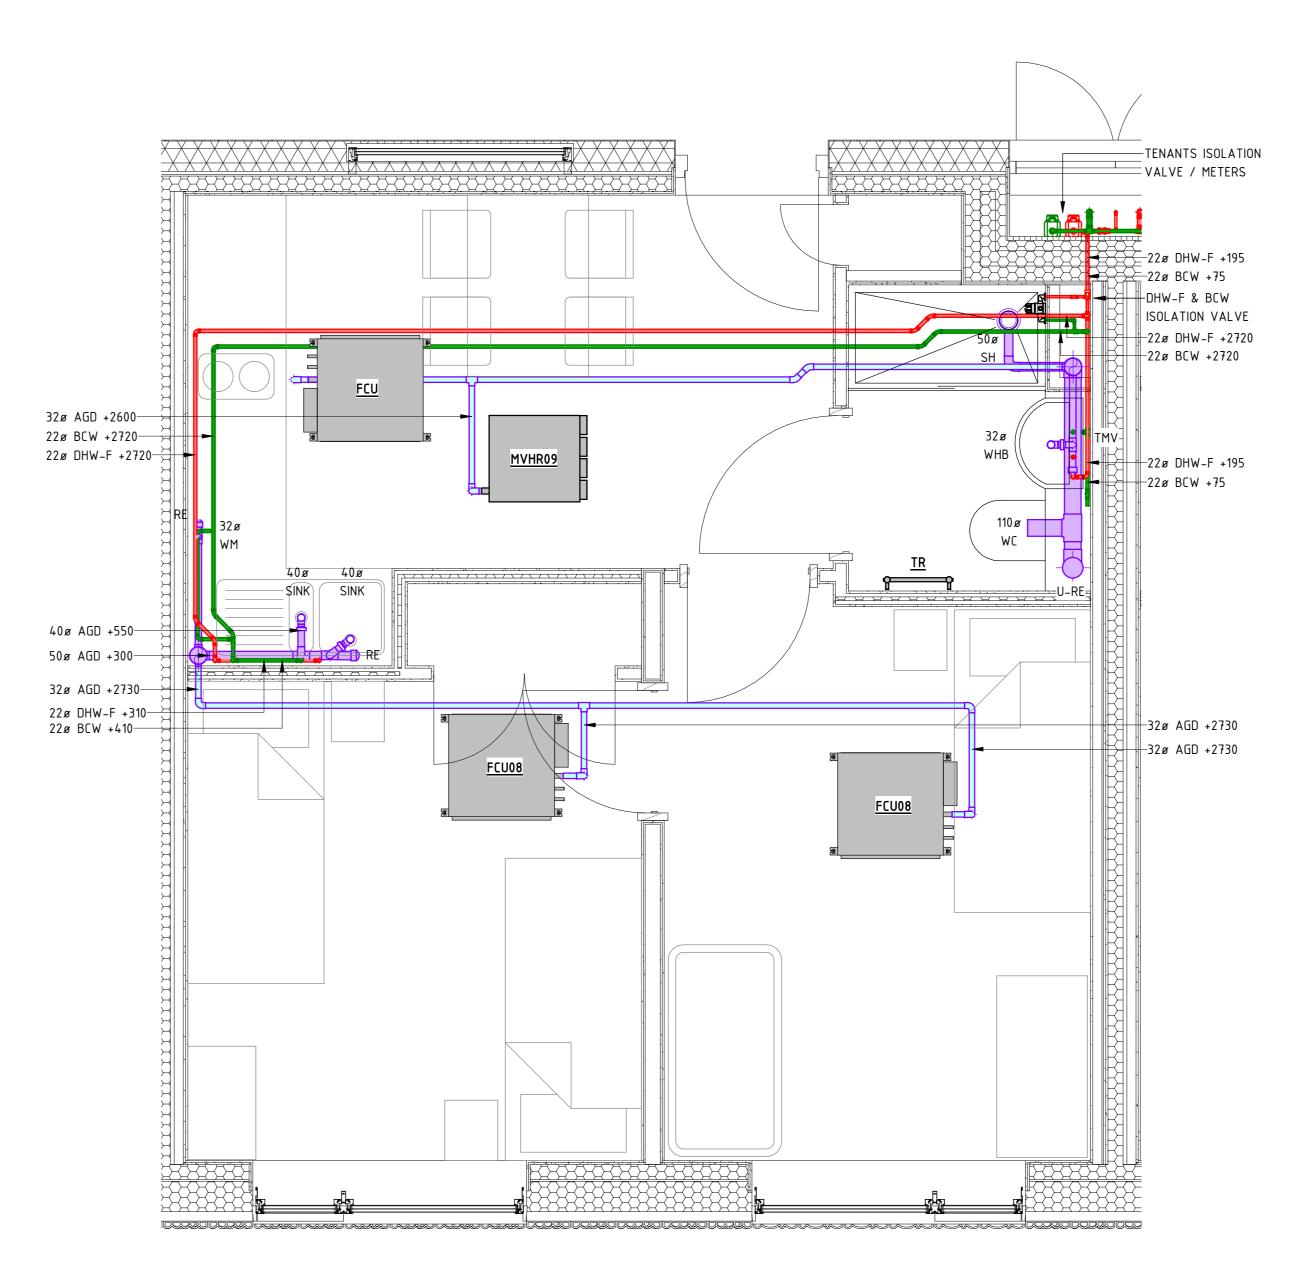

<u>Typical 1 Bed Unit Mechanical Services – Section A-A</u> SCALE 1:25

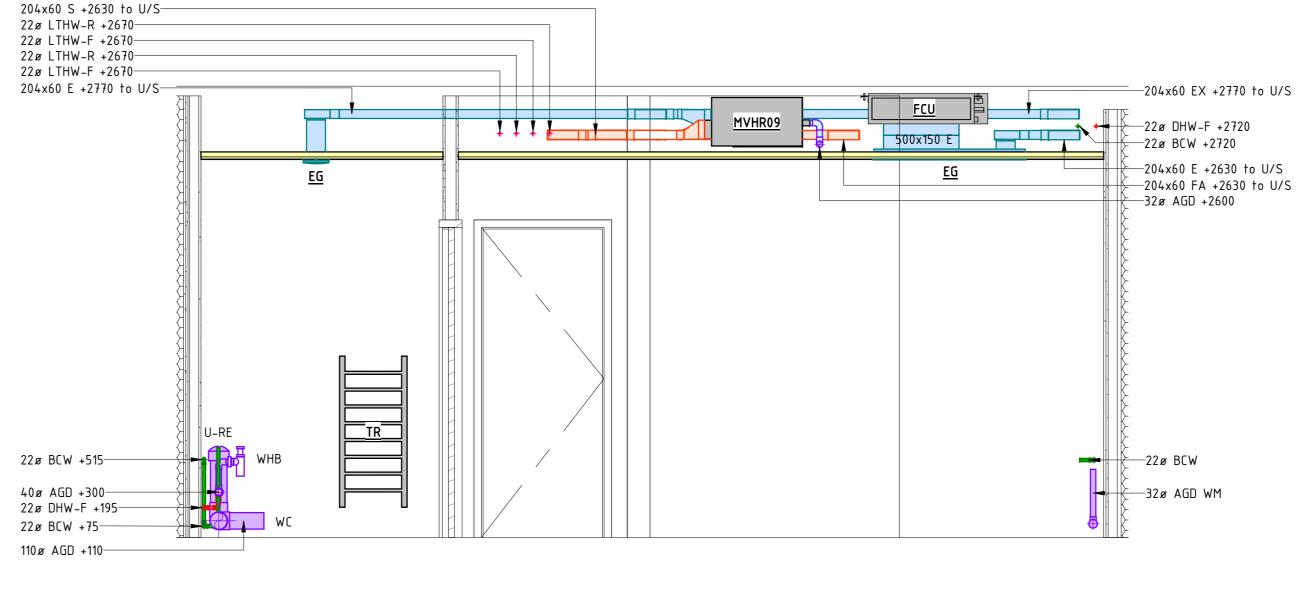

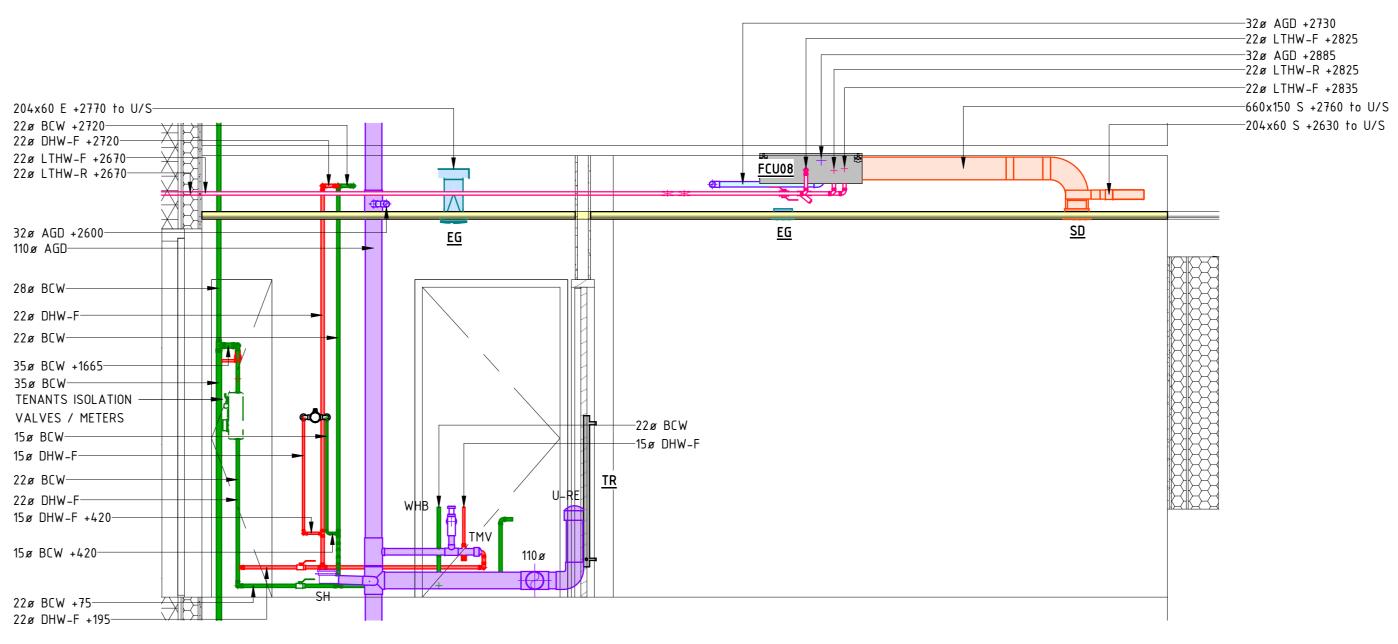

<u>01 First Floor – Typical 1 Bed Unit – Domestics & Drainage</u> SCALE 1:25


<u> Typical 1 Bed Unit Mechanical Services – Section B-B</u> SCALE 1:25


<u>Typical 1 Bed Unit Mechanical Services – Section D-D</u> SCALE 1:25


MECHANICAL APARTMENT LEGEND						
SYMBOL	DESCRIPTION					
<u> </u>	SUPPLY DUCTWORK					
<u> </u>	EXTRACT DUCTWORK					
$\begin{array}{c} \\ \\ \\ \\ \\ \\ \\ \\ \\ \\ \\ \\ \\ \\ \\ \\ \\ \\ \\$	TRANSFER GRILLE					
	DOMESTIC HOT WATER PIPEWORK					
	BOOSTED COLD WATER PIPEWORK					
	LOW TEMPERATURE HOT WATER					
	FOUL WATER PIPEWORK					
	CONDENSATE PIPEWORK					
G	SHOWER FLOOR GULLY					
*****	ELECTRIC HEATER					
Ī	WALL MOUNTED THERMOSTAT					
	ELECTRIC UNDER FLOOR HEATING					
	FIRE COLLAR					
MECHANICAL APARTMENT ABBREVIATIONS						

MECHANICAL APARTMENT ABBREVIATIONS


- AGD ABOVE GROUND DRAINAGE
- BCW BOOSTED CALLED WATER DHW – DOMESTIC HOT WATER
- FC FIRE COLLAR
- FCU FAN COIL UNIT
- LTHW LOW TEMPERTURE HOT WATER MVHR - MECHANICAL VENTILATION HEAT RECOVERY
- TR TOWEL RAIL
- UFH UNDERFLOOR HEATING WC – WATER CLOSET
- WD WASHER DRYER WHB – WASH HAND BASIN

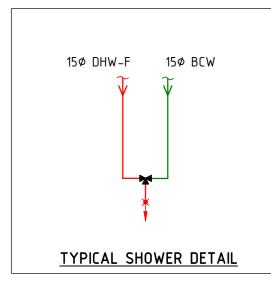

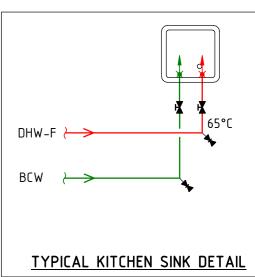


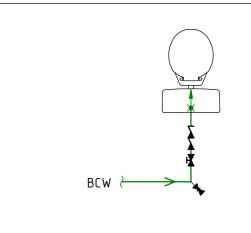

TYPICAL WATER CLOSET DETAIL

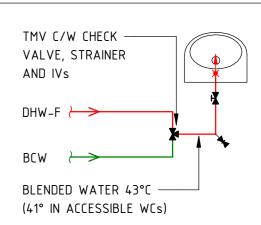

TYPICAL WASH HAND BASIN DETAIL

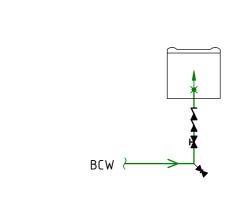

TYPICAL WASHING MACHINE DETAIL

0 0.25 0.5 0.75 1 1.25

GENERAL NOTES

- 1. FOR BUILDING SERVICES INFORMATION ONLY.
- 2. THIS DRAWING SHALL BE READ IN COLOUR. 3. THIS DRAWING SHALL BE READ IN CONJUNCTION

WITH THE MECHANICAL SCHEDULES & ANY

- ASSOCIATED SPECIFICATION. 4. ALL BUILDING FABRIC PENETRATIONS SHALL BE SEALED IN ACCORDANCE TO THE BUILDING FABRIC MANUFACTURERS SPECIFICATION AND REQUIREMENTS TO ENSURE THE FIRE RESISTANCE AND/OR FIRE-RETARDANT CHARACTERISTICS AND WEATHER RESISTANCE CHARACTERISTIC OF SUCH MATERIALS ARE NOT COMPROMISED. EXACT FIRE AND WEATHER SEALING DETAILS ARE A CONTRACTOR DESIGN
- 5. FOR FINAL VALVE ARRANGEMENT REFER TO RELEVANT SERVICE SCHEMATIC.

VENTILATION NOTES

ELEMENT.

- 1. ALL DUCTWORK SHALL CONFORM TO DW 144.
- 2. ACCESS DOORS SHALL BE PROVIDED IN ACCORDANCE WITH DW 144. POSITIONS TO BE DETERMINED & AGREED ON SITE.
- 3. ALL GRILLES & DIFFUSERS TO BE LOCATED CENTRALLY WITHIN CEILING TILES UNLESS OTHERWISE STATED.
- 4. A MAXIMUM OF 500mm OF FLEXIBLE DUCTWORK TO BE USED FOR FINAL CONNECTIONS INTO GRILLES.
- 5. ALL GRILLES & DIFFUSERS ARE TO HAVE SUITABLY SIZED PLENUM BOX TO SUIT SPIGOT DIMENSIONS ..

HEATING NOTES

- 1. THE CONTRACTOR SHALL MAKE ADEQUATE PROVISION FOR EXPANSION BELLOWS & LOOPS WITH ALL ASSOCIATED BRACKETRY, GUIDES & ANCHORS. EXPANSION BELLOWS TO BE CONFIRMED BY SPECIALIST.
- 2. ALL PIPEWORK PASSING THROUGH WALLS & FLOORS TO BE SLEEVED & FIRE STOPPED TO BS EN 1366-3, NON-NORMATIVE CONSTRUCTION TYPES SHOULD BE TO BS:476 AND SUBJECT TO BUILDING CONTROL APPROVAL. WHERE PASSING THROUGH FIRE WALLS/CAVITY BARRIERS/FLOORS. SLEEVES TO BE FLUSH WITH SERVICES WHERE PIPEWORK IS EXPOSED.
- 3. ALTHOUGH NOT SHOWN, INCLUDE FOR AAVS AT ALL HIGH POINTS & DRAIN COCKS AT ALL LOW POINTS ON THE SYSTEM.
- 4. ALL PIPEWORK TO BE PRESSURE TESTED PRIOR TO THE APPLICATION OF INSULATION.

DOMESTICS NOTES

- 1. ALL DEADLEGS ARE TO BE KEPT TO AN ABSOLUTE MINIMUM.
- 2. ALTHOUGH NOT SHOWN, INCLUDE FOR AUTOMATIC AIR VENTS AT ALL HIGH POINTS AND DRAIN COCKS AT ALL LOW POINTS ON THE SYSTEM.
- 3. THE INSTALLATION SHALL COMPLY WITH THE WATER SUPPLY (WATER FITTINGS) REGULATIONS 1999 IN EVERY RESPECT.
- 4. ALL DHW FLOW & RETURN PIPEWORK SHALL BE EQUIPPED WITH ALL VALVES REQUIRED TO BALANCE THE SYSTEM.
- 5. CHROME PLATED SCREW DRIVER OPERATED SERVICE VALVES TO BE INSTALLED TO ALL SANITARY APPLIANCES. NO VALVES TO BE INSTALLED IN BOXING.

DRAINAGE NOTES

- 1. ALL ABOVE GROUND DRAINAGE TO BE INSTALLED IN ACCORDANCE WITH BUILDING REGULATIONS APPROVED DOCUMENT H & BS EN 12056-PARTS 1- 5 2000.
- 2. ACCESS PANEL TO BE INSTALLED IN ACCORDANCE WITH THE REQUIREMENTS OF BS EN 12056-PARTS 1-5 2000.
- 3. ALL DRAIN POINT CONNECTIONS INCLUDING CONNECTORS ARE TO BE LEFT BY THE UNDERGROUND DRAINAGE INSTALLER.
- 4. ALL SOIL FLOATS ARE TO BE INSTALLED USING A PROPRIETARY WC MANIFOLD SYSTEM & LAID TO A FALL OF 1 DEGREE (17mm DROP PER METRE RUN).
- 5. ALL SEALED TRAPS TO BE A MINIMUM OF 75mm DEEP.
- 6. CONDENSATE FROM AC UNITS & HRU DRAINS TO BE RUN TO NEAREST SUITABLE FOUL DRAIN LOCATION TO BE C/W SELF SEALING TRAP.
- EXPANSION COLLARS ARE TO BE INSTALLED AS REQUIRED BY PIPEWORK MANUFACTURER.

P01	STAGE 4 - ISSUED FOR COMMENT				0.11.2023		
Rev.	ev. Description			D	ate		
Client: Anderson Green building services consultants www.andersongreen.co.uk Client: MORGAN SINDALL							
Stage: STAGE 4							
Project: CAMDEN HOSTELS CHESTER ROAD							
TYPICAL 1 BED UNIT MECHANICAL SERVICES							
Eng:		QA Eng:					
E.Th	ornton	A.Moss	A.Moss				
BIM Tech	:	QA BIM:	QA BIM:				
A.Hir	A.Hirst M.Burkinshaw						
Security (Classification:	Drawing Start Da	ate:	Size:	Scale:		
UNC	LASSIFIED	20.11.20	23	A0	1:25		

Project No. - Originator - Function - Level - Form - Discipline - Drawing No. Status: Revision: 123007-AGL-CH-ZZ-DR-M-4102 S3 P01