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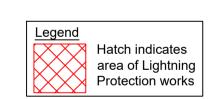
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- Graphical representations of equipment on this drawing have been co-ordinated, but are approximations only. Please refer to specifications and / or details for actual sizes and or specific
- 11. All builders work associated with the mechanical and electrical
- services installation must be included for. 12. Contractor to review site Asbestos register prior to commencing
- The position of all equipment shown is indicative only. Final positions to be determined & indicated on working drawings.





P01	11 Information Issue			11.05.23	NH	PK
Rev	Rev Description			Date	Chk	Apr
Project No: 502705		Scale @ A1: 1:500		Drawn By: KS		
Ingleton		Property and Construction Consultants				
	VALOR	<b>5</b>	Issuing office:	Colcheste		

Vision, form and function

HSLI Stone Building
Lightning Protection System
Stone Buildings
London WC2A 3TL

Honourable Society of Lincoln's Inn

Area of Lightning Protection -Site Plan

Drawing Number:
HSLISB-IWD-XX-XX-DR-E-5100


Status: | Purpose of Issue: S2 | Information







Example of HVI Mast

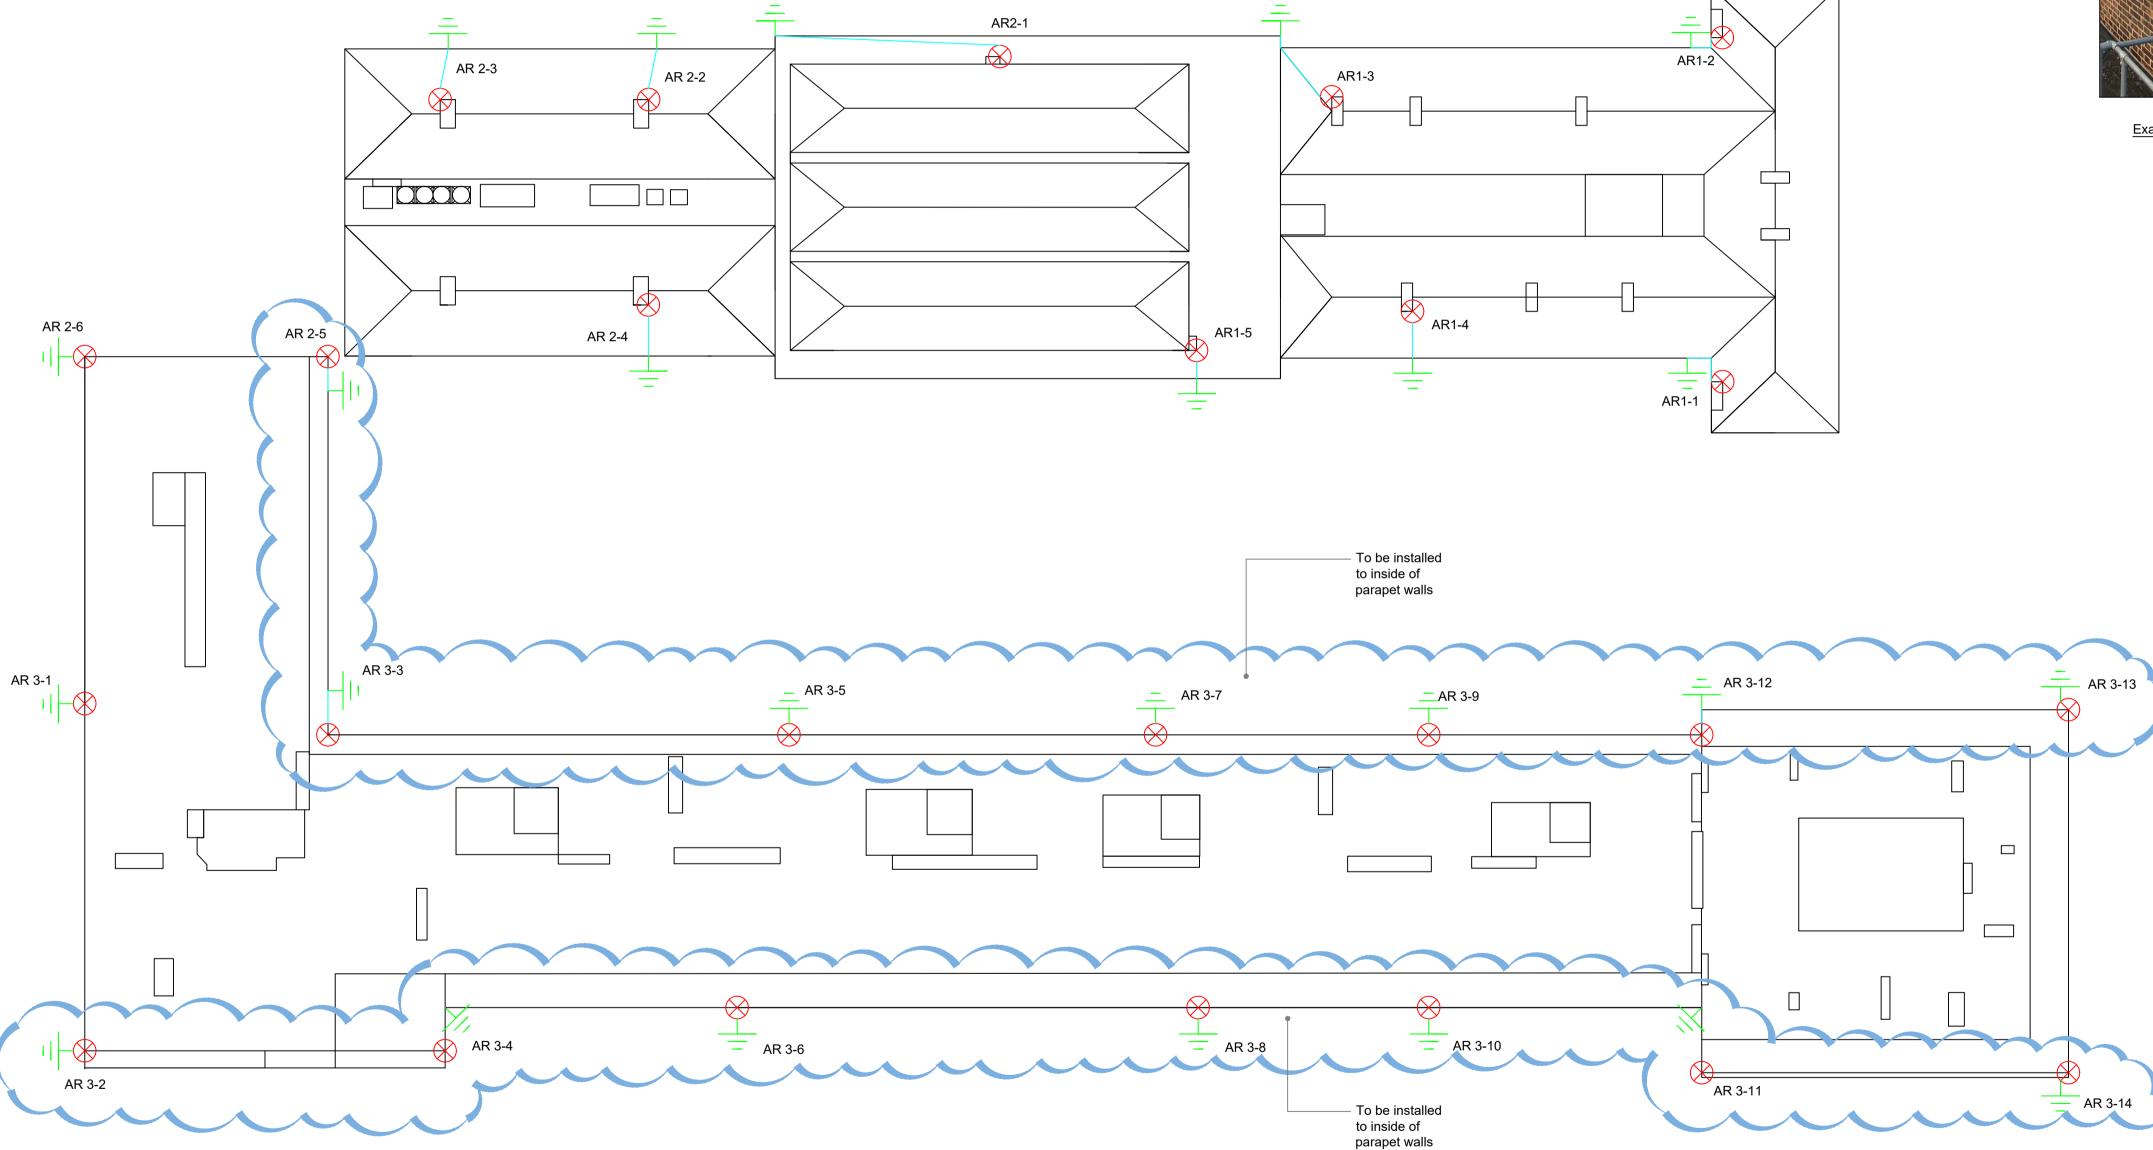

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- 13. The position of all equipment shown is indicative only. Final


### positions to be determined & indicated on working drawings.


- Spacing between the masts will reflect the level of lightning protection, which has been calculated with a result of level 2 and the calculated penetration distance calculation from BS EN
- Touch potential hazards can achieve toleerable levels if the surface layer is not less than 100KΩ. Which is generally achieved with a 50mm thick asphalt layer. Complying with clause 8.2 in BS EN 62305
- 3. To fully complete to BS EN 62305 surge protection is to be
- 4. AR1-1 to AR1-5 are required for Phase 1 works
- 5. AR2-1 to AR2-6 are required for Phase 2 works
- 6. AR3-1 to AR3-14 are required for Phase 3 works


**Drawing Notes:** 



HVI Masts secured to concrete wall via 2No. Brackets with a height of 5m above the top bracket.

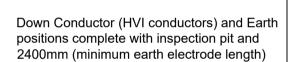

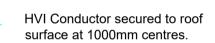

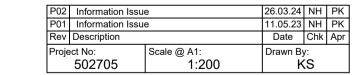



Vision, form and function

Project: HSLI Stone Building Lightning Protection System
Stone Buildings London WC2A 3TL

Honourable Society of Lincoln's Inn

## Lightning Protection


Drawing Number:


HSLISB-IWD- 01 -XX -DR-E-5800


| Revision:


Status: Purpose of Issue: Information

Revision:

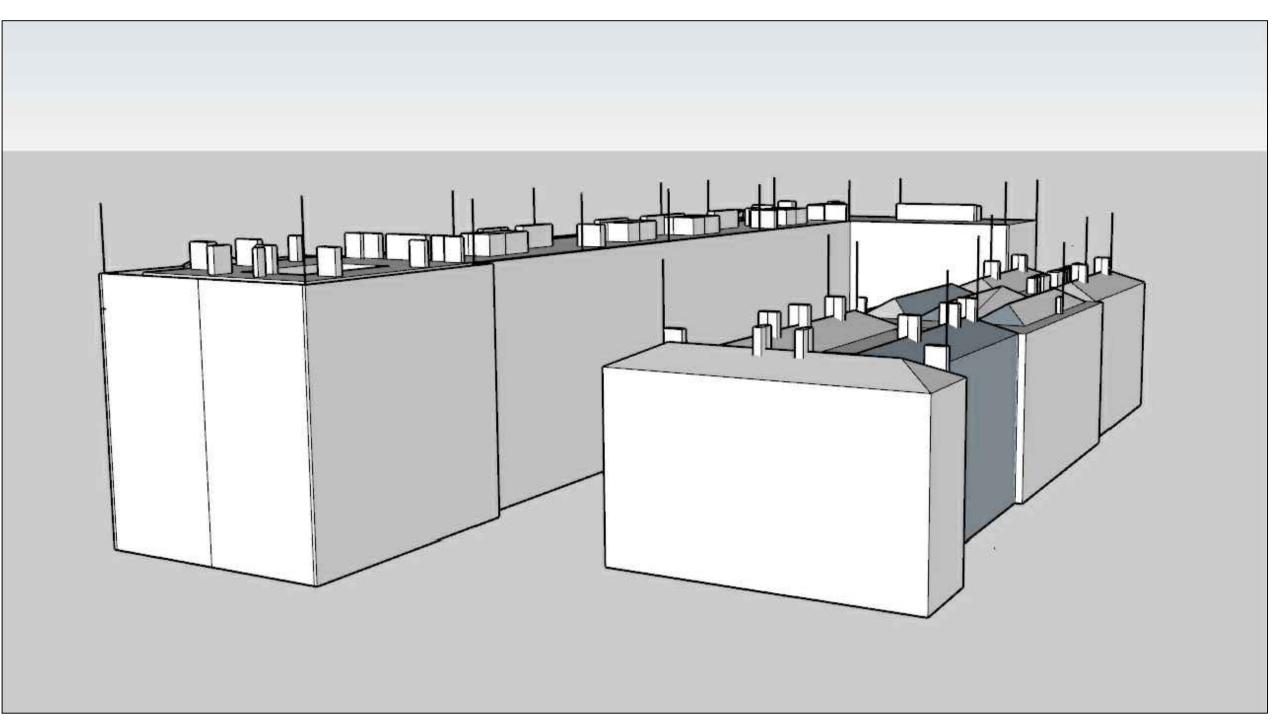

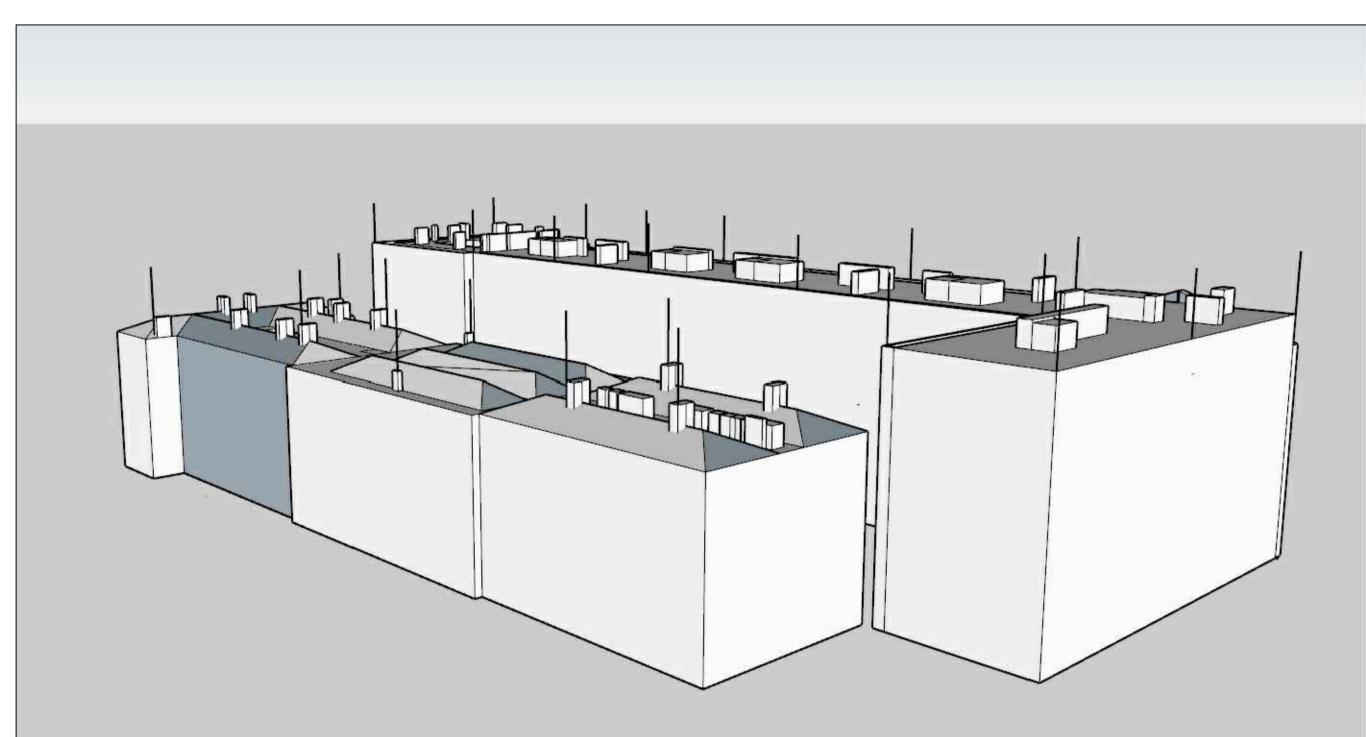

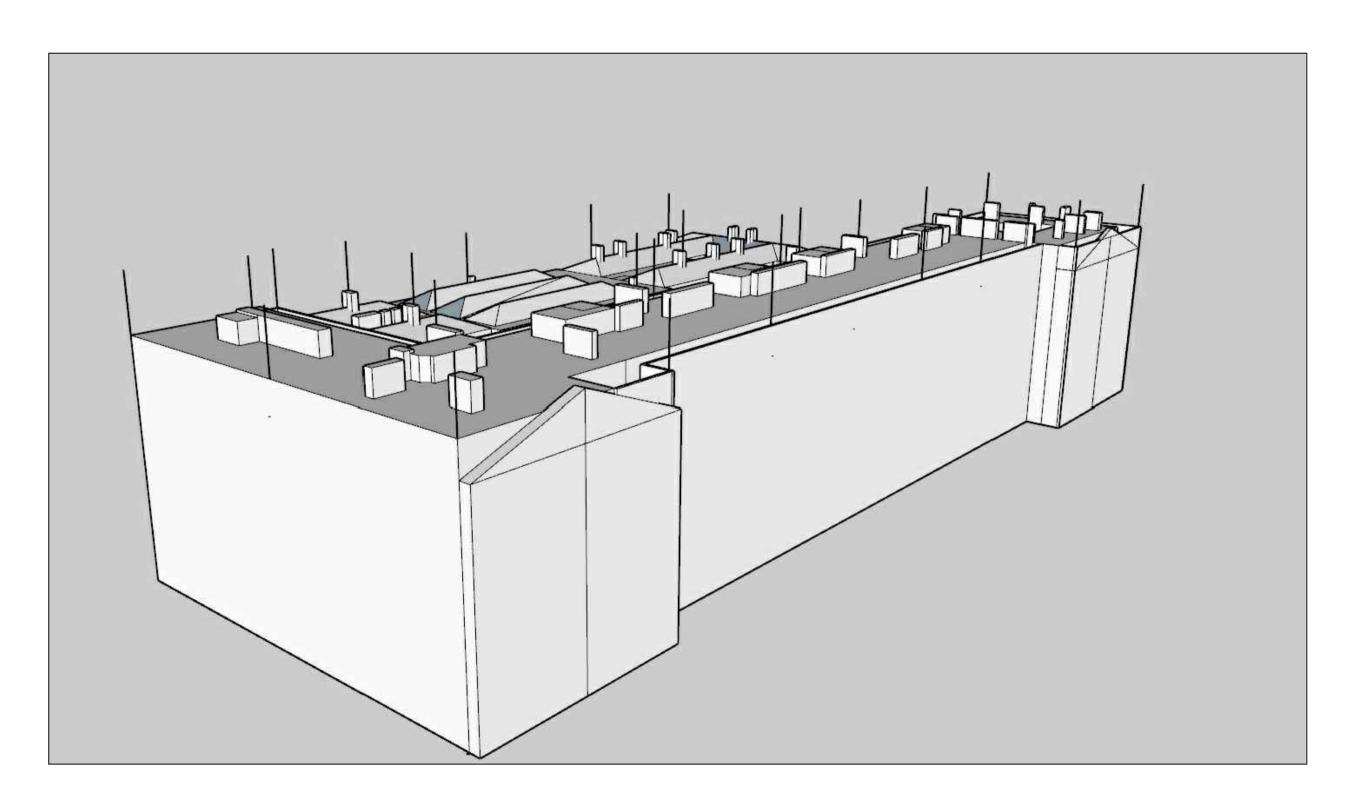

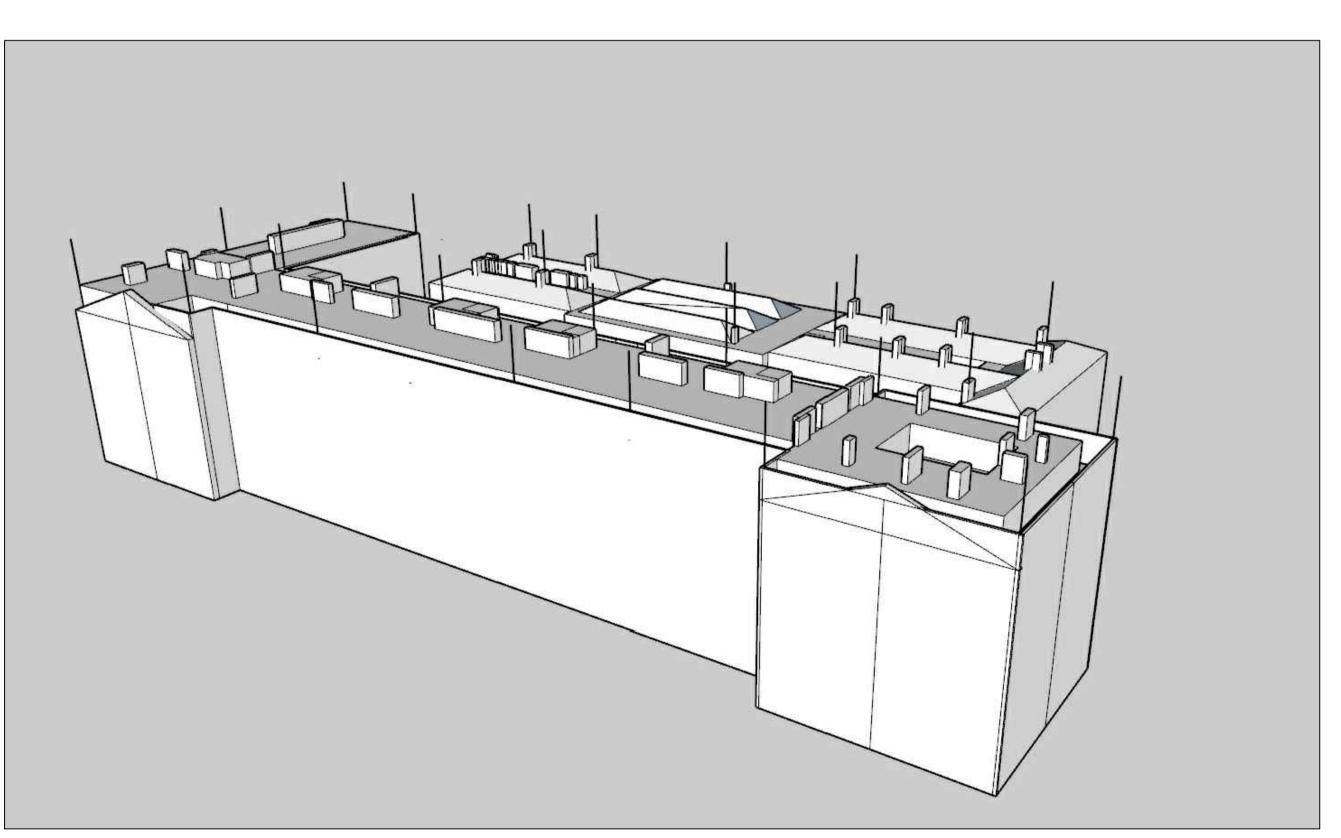

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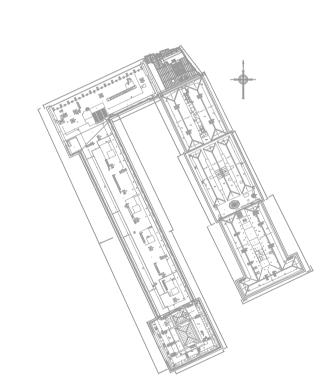
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# **Drawing Notes:**

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   AR2-1 to AR2-6 are required for Phase 2 works
- 6. AR3-1 to AR3-14 are required for Phase 3 works





Vision, form and function


HSLI Stone Building
Lightning Protection System
Stone Buildings
London WC2A 3TL

Client: Honourable Society of Lincoln's Inn

ISO HVI Locations

Drawing Number:
HSLISB-IWD-01-XX-DR-E-5802

Status: | Purpose of Issue: | S2 | Information

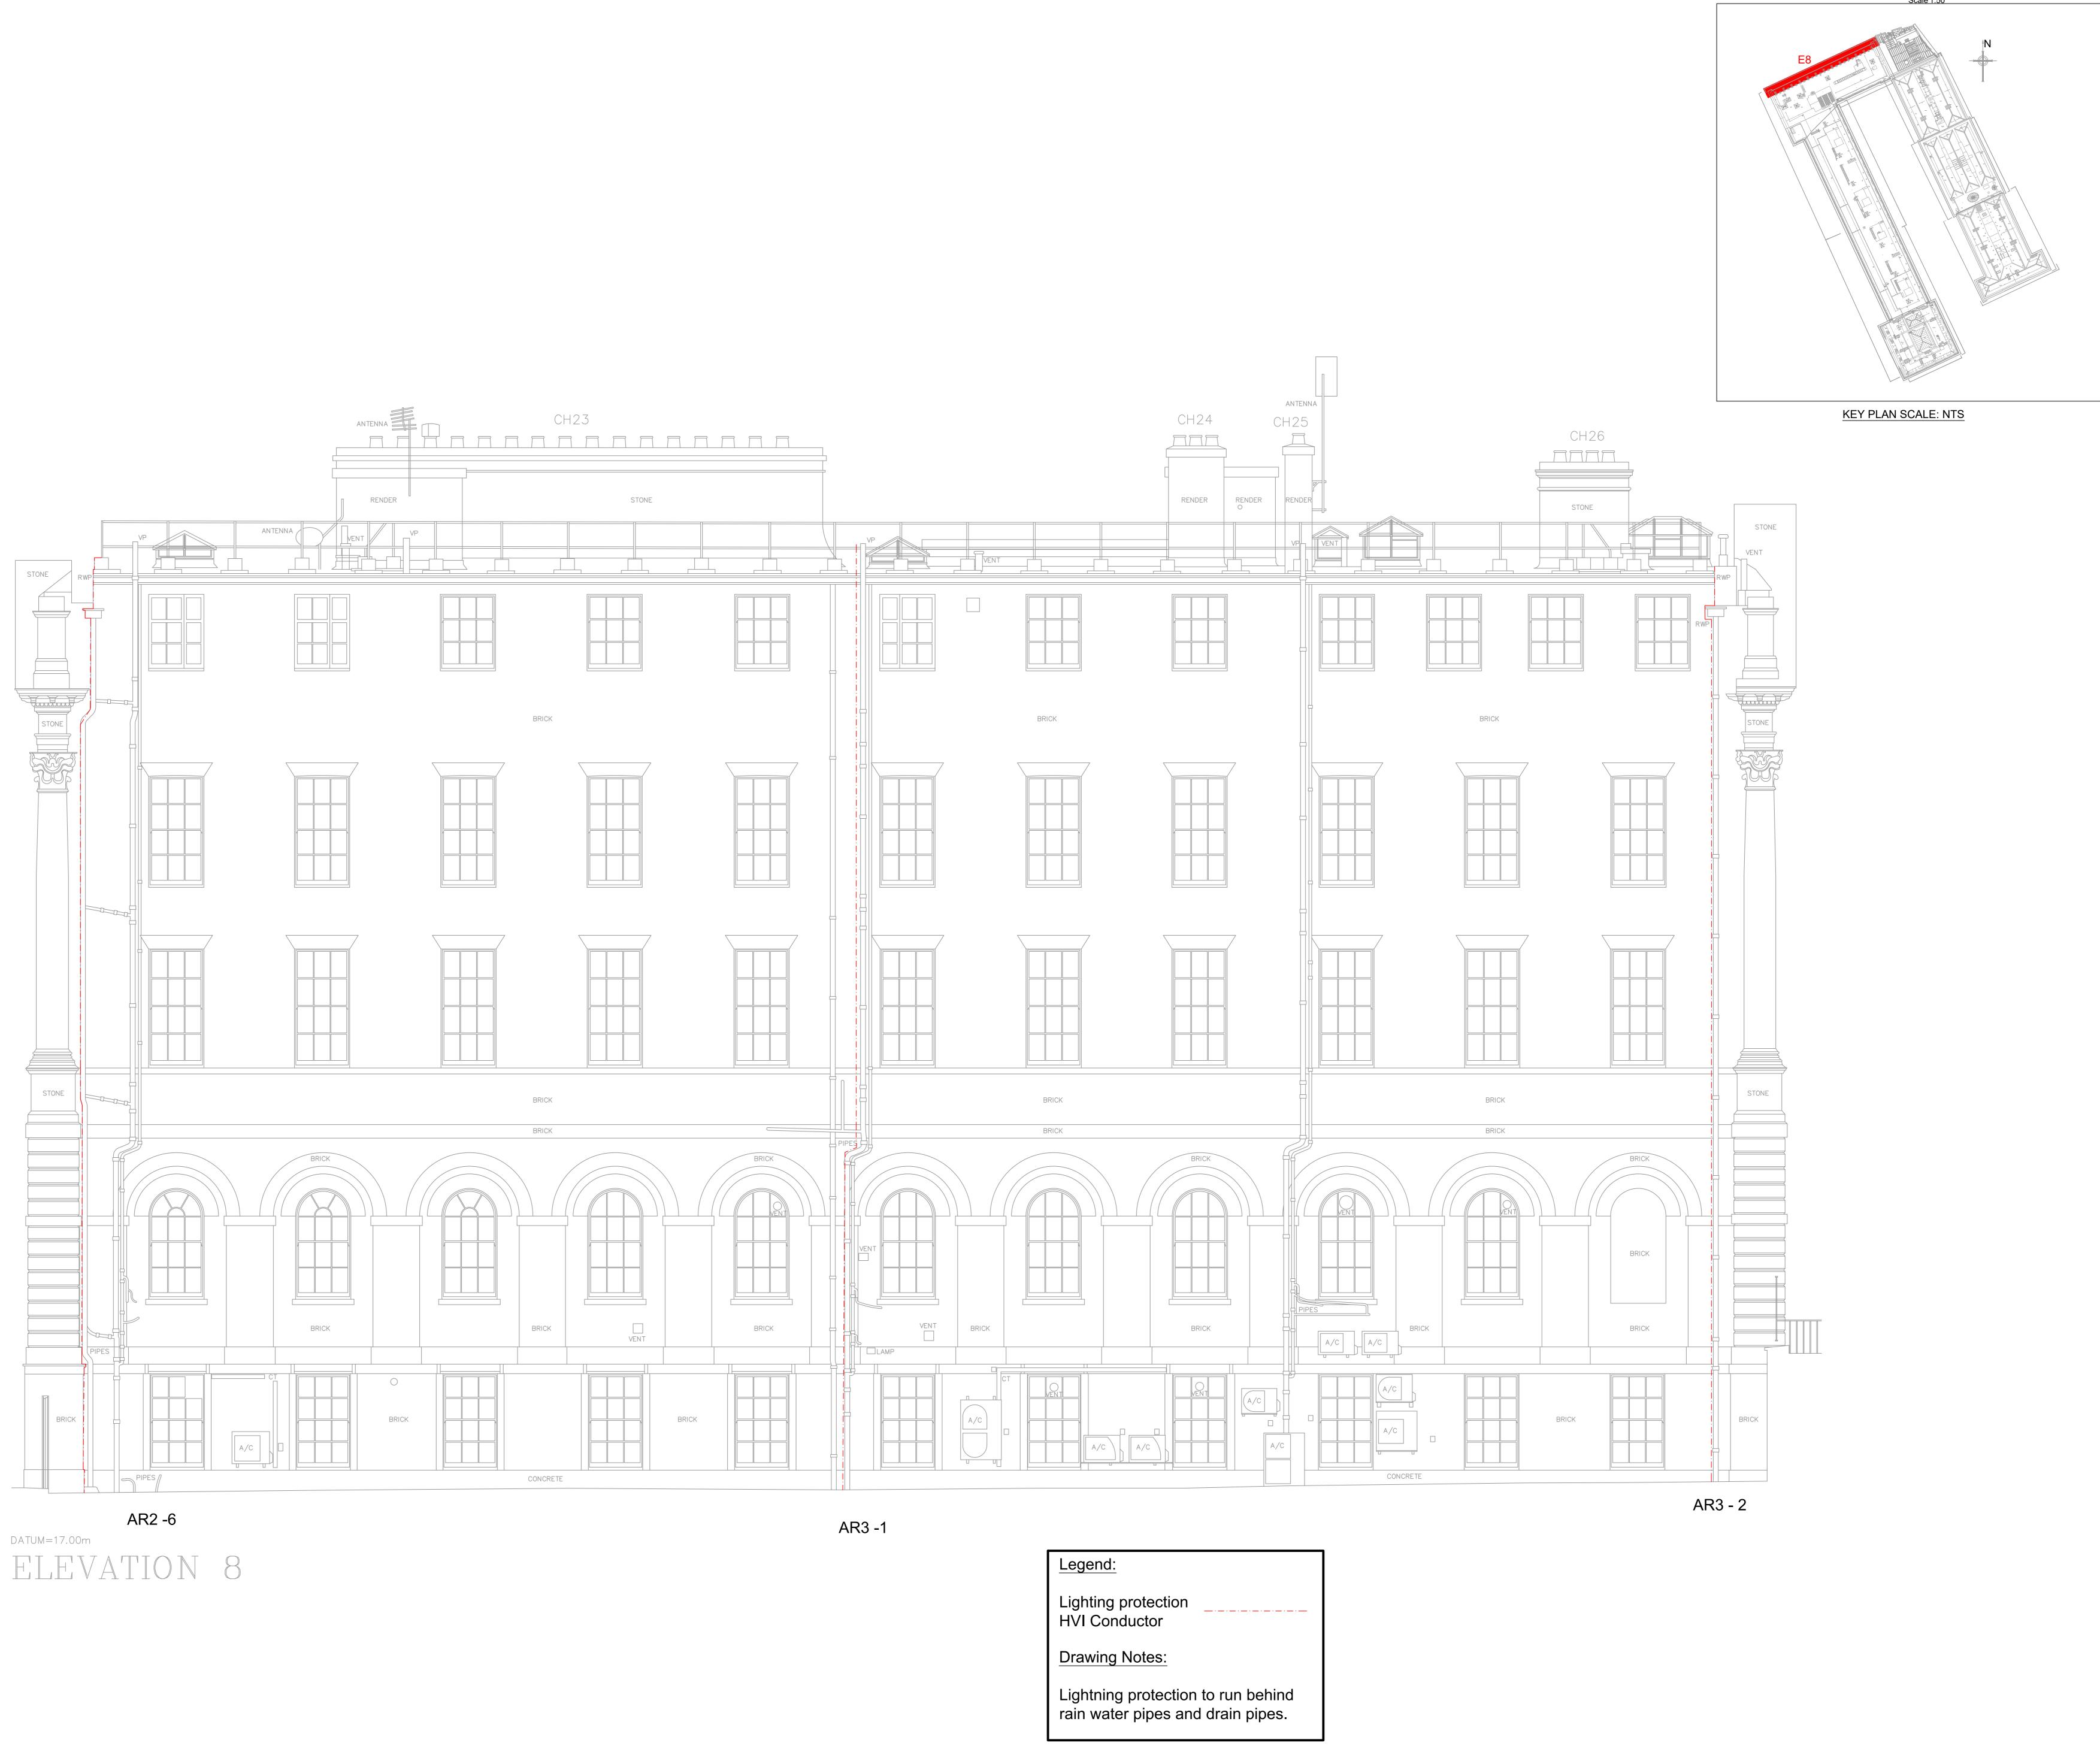

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12. Contractor to review site Asbestos register prior to commencing works.
13. All power and control wiring associated with the mechanical

14. The position of all equipment shown is indicative only. Final

positions to be determined & indicated on working drawings.
15. Refer to presence detector installation instructions for wiring, switch type & final position.
16. Refer to mechanical drawings for extract fan details.

services installation must be included for.

 Refer to mechanical drawings for extract fan details.
 Refer to mechanical layout drawings for positions of outlets to mechanical plant.

Cable containment (if indicated) is shown as indicative only.
 Contractor to determine cable containment routes and sizes to suit the installation.

. . ...

HVI conductor shall be painted to match the existing stonework/paint
 Where HVI conductors are installed behind/adjacent RWP's these shall be coloured

P02 | Scale Bar Added | 01.02.24 | NH |
P01 | Information Issue | 11.05.23 | NH |
Rev | Description | Date | Chk |
Project No: | Scale @ A0: | Drawn By: |
502705 | 1:50 | Drawn By: |
JP |

Property and Constructic Consultants |
Issuing office: Colchester |
T: 01206 224270 |
www.ingletonwood.co.uk |
Vision, form and function |
Project: | HSLI Stone Building |


HSLI Stone Building
Lightning Protection System
Stone Buildings
London WC2A 3TL

Client:
Honourable Society of Lincoln's Inn

Lightning Protection
Elevation E8

Drawing Number:
HSLISB-IWD-XX-XX-DR-E-5815

Status: | Purpose of Issue: S2 | Information

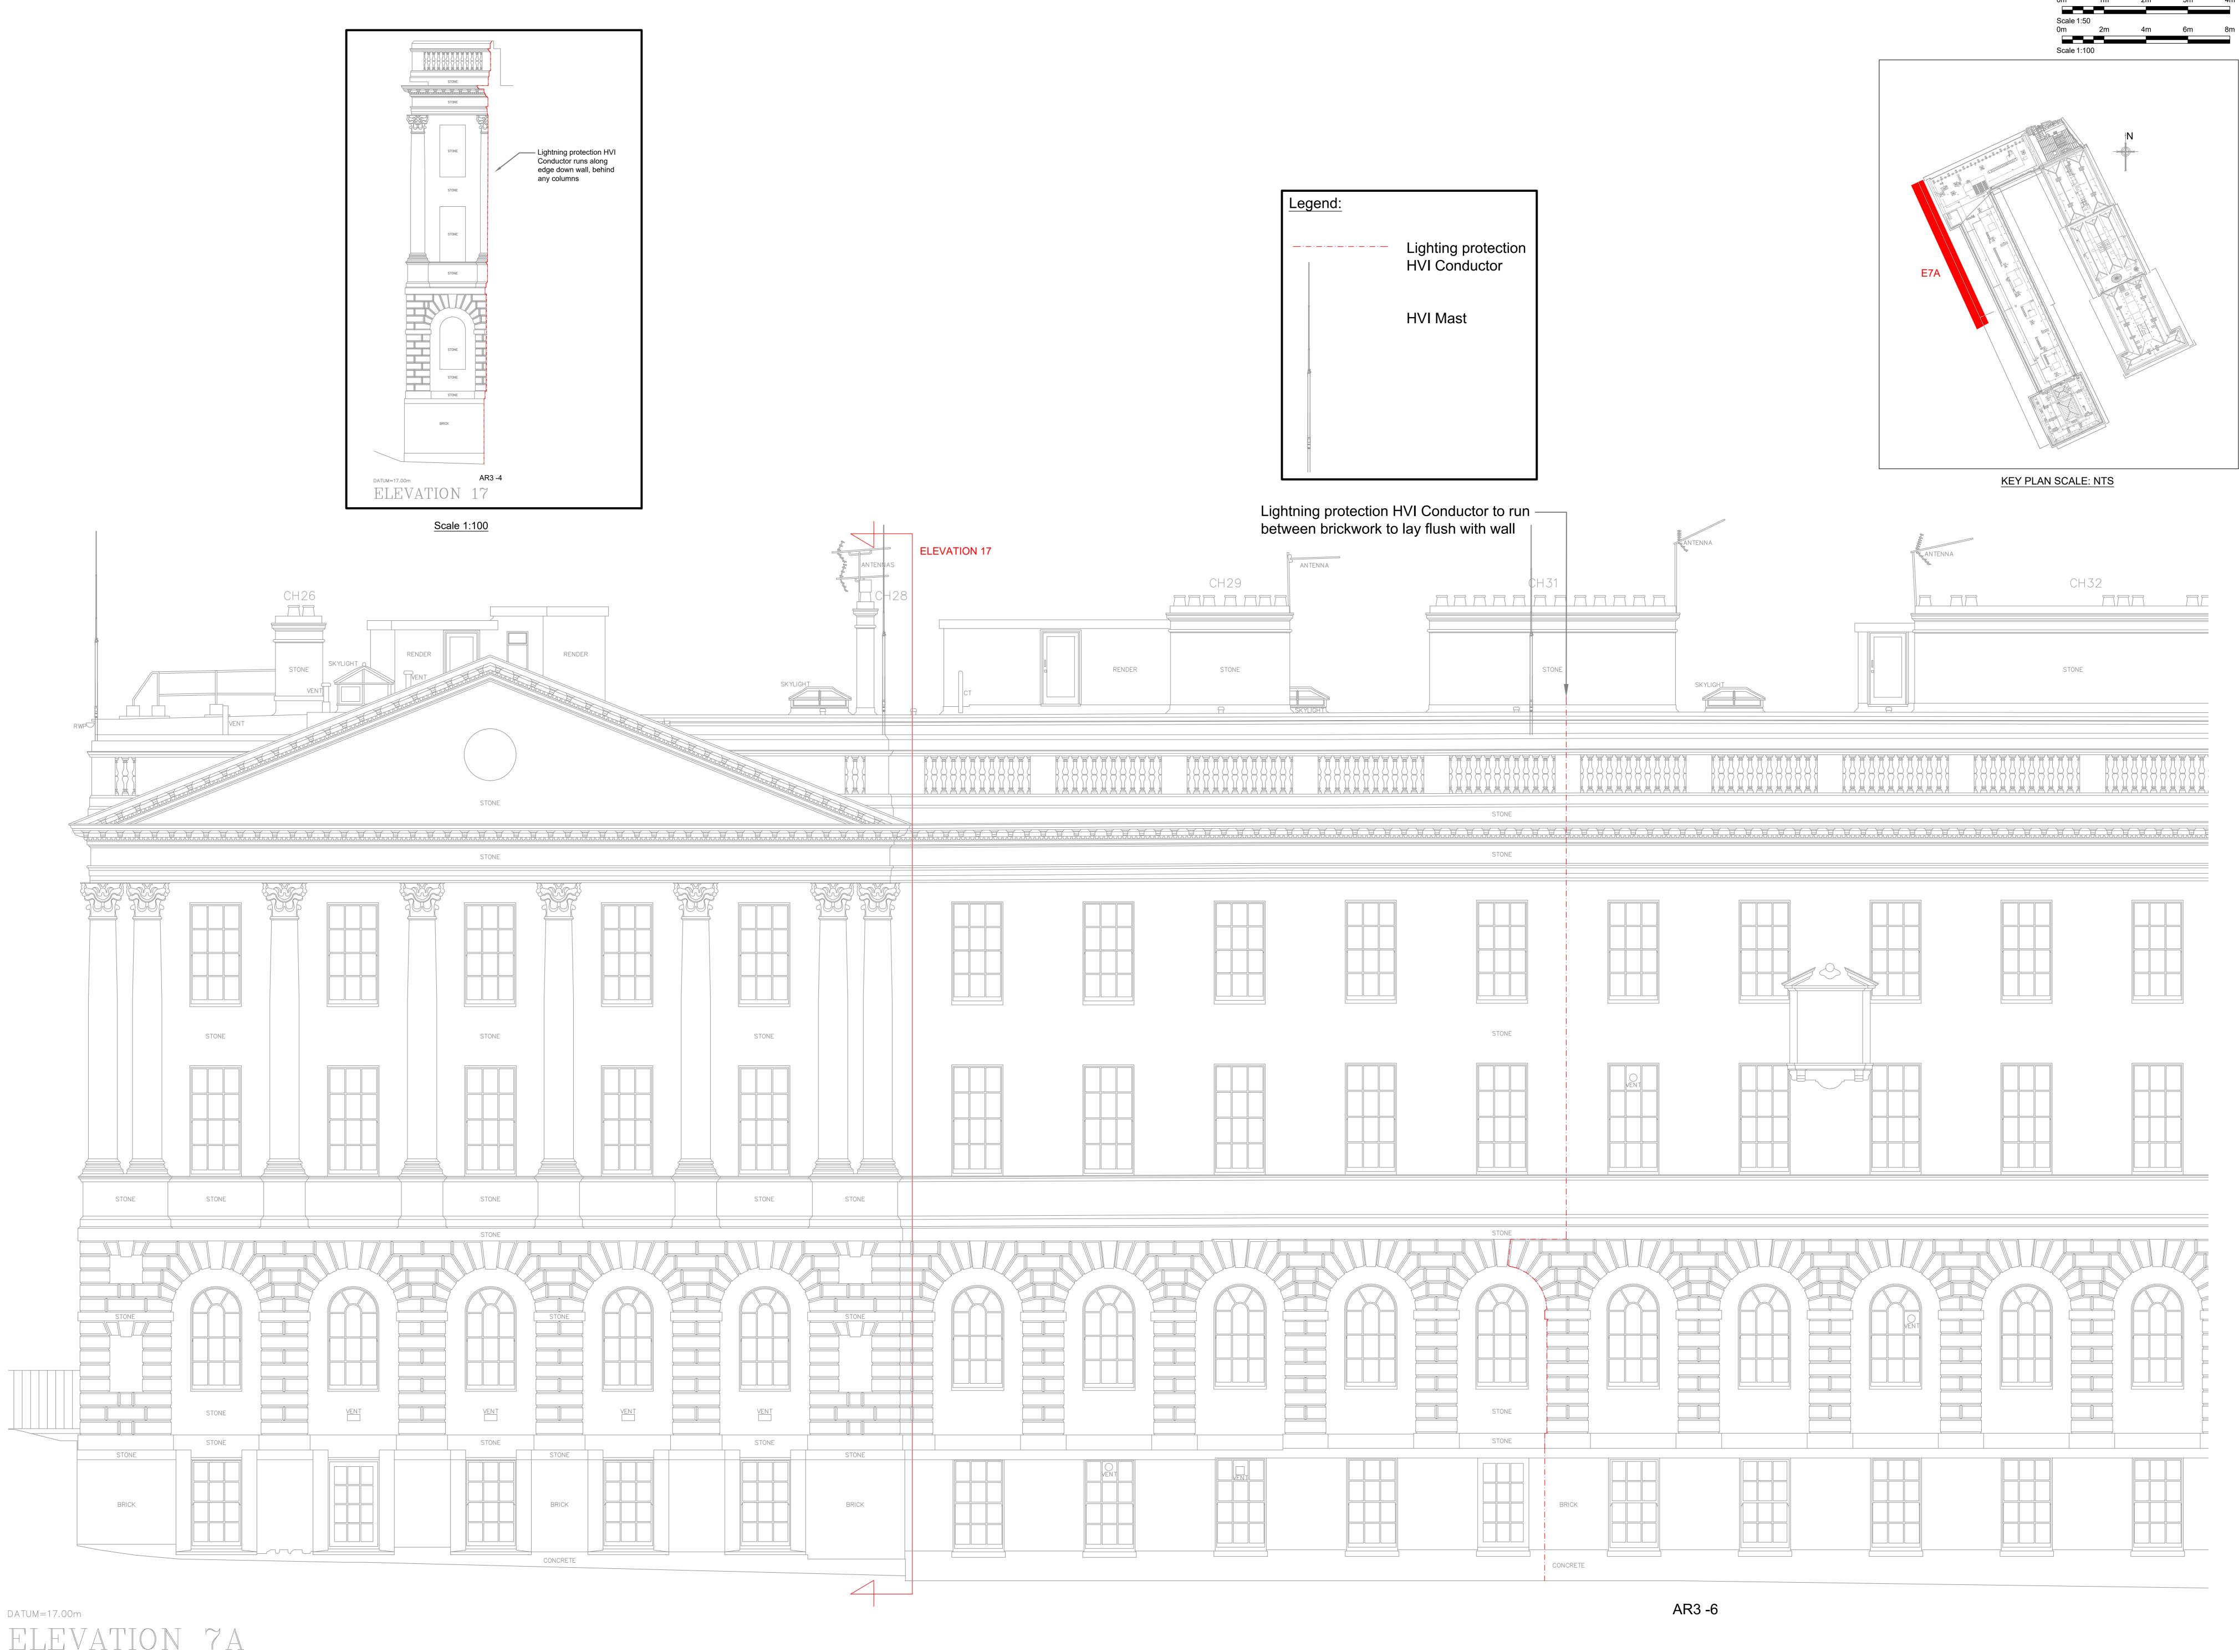

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13. All power and control wiring associated with the mechanical services installation must be included for.

14. The position of all equipment shown is indicative only. Final positions to be determined & indicated on working drawings. 15. Refer to presence detector installation instructions for wiring,

16. Refer to mechanical drawings for extract fan details. 17. Refer to mechanical layout drawings for positions of outlets to mechanical plant. 18. Cable containment (if indicated) is shown as indicative only.

Contractor to determine cable containment routes and sizes to suit the installation.

HVI conductor shall be painted to match the existing stonework/paint Where HVI conductors are installed behind/adjacent RWP's these shall be coloured

switch type & final position.

HVI Masts are shown for illustrative purposes only and do not reflect actual appearance from

ground level

 
 P02
 Scale Bar Added
 01.02.24
 NH
 PK

 P01
 Information Issue
 11.05.23
 NH
 PK

 Rev
 Description
 Date
 Chk
 Apr

 Project No:
 Scale @ A0:
 Drawn By:


 502705
 1:50/1:100
 JP
 Ingleton Wood Vision, form and function


HSLI Stone Building
Lightning Protection System
Stone Buildings
London WC2A 3TL


Status: | Purpose of Issue:
S2 | Information

Honourable Society of Lincoln's Inn

Lightning Protection Elevation E7A Drawing Number:
HSLISB-IWD-XX-XX-DR-E-5816

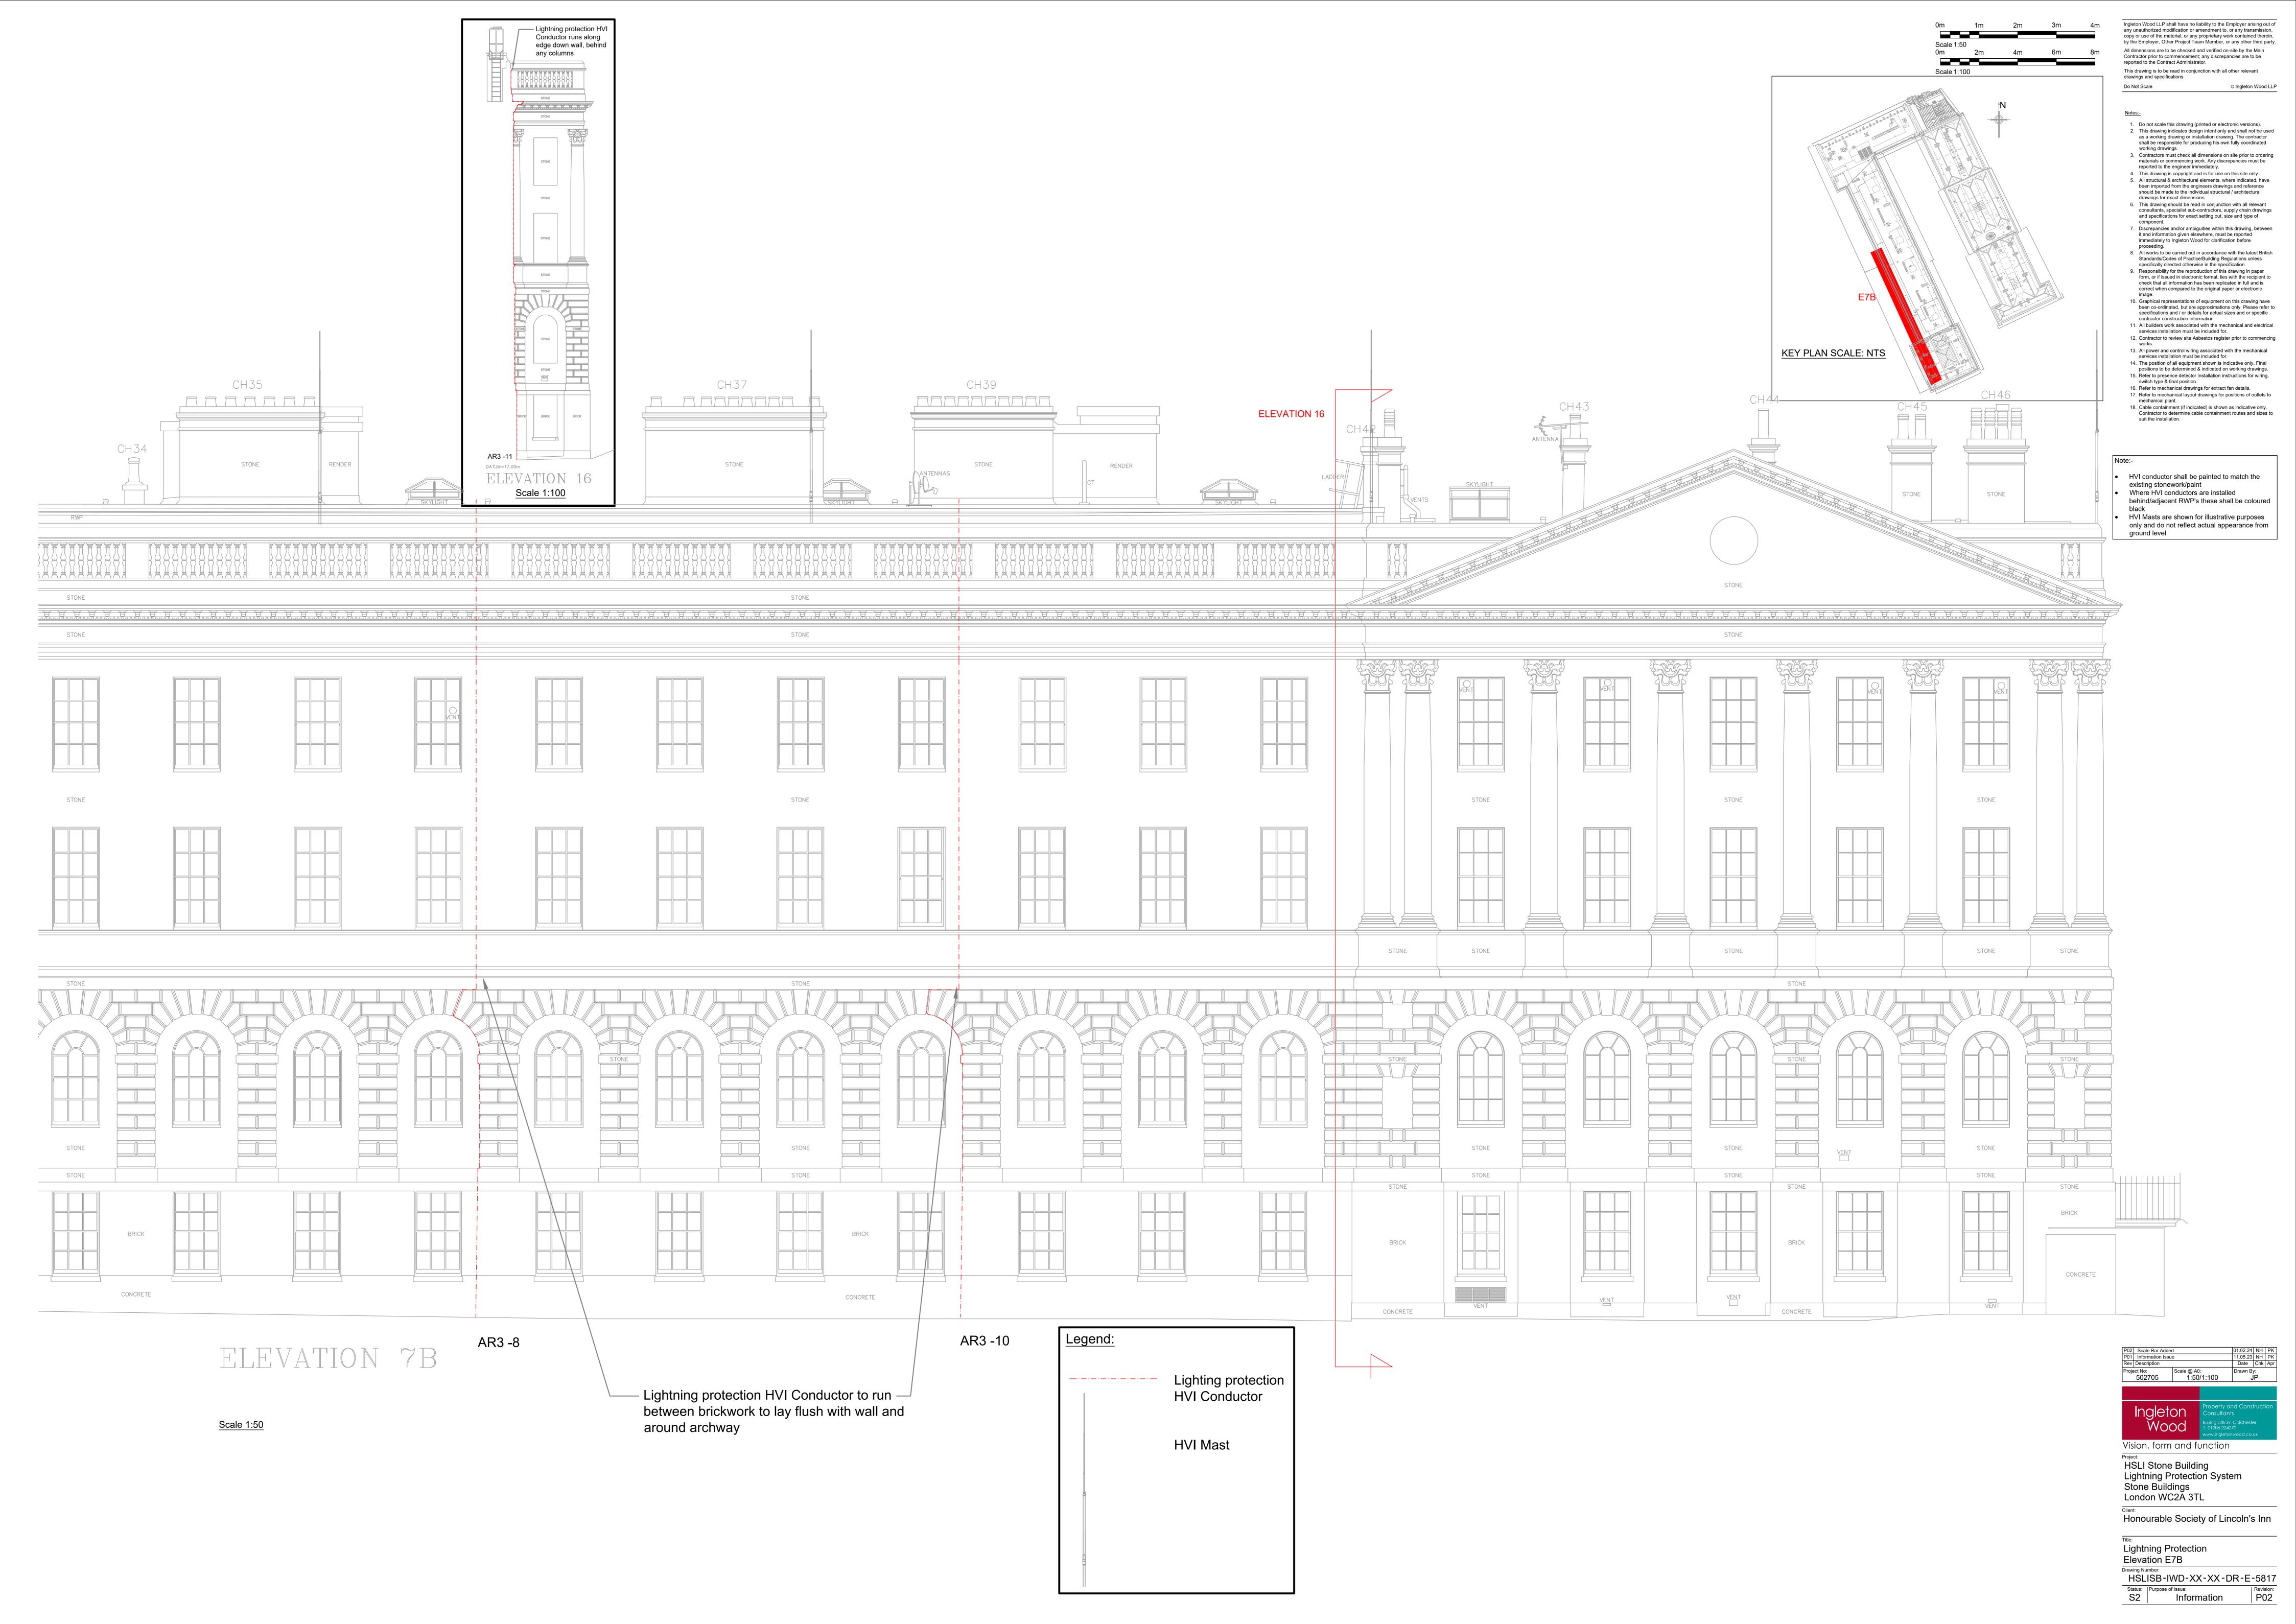

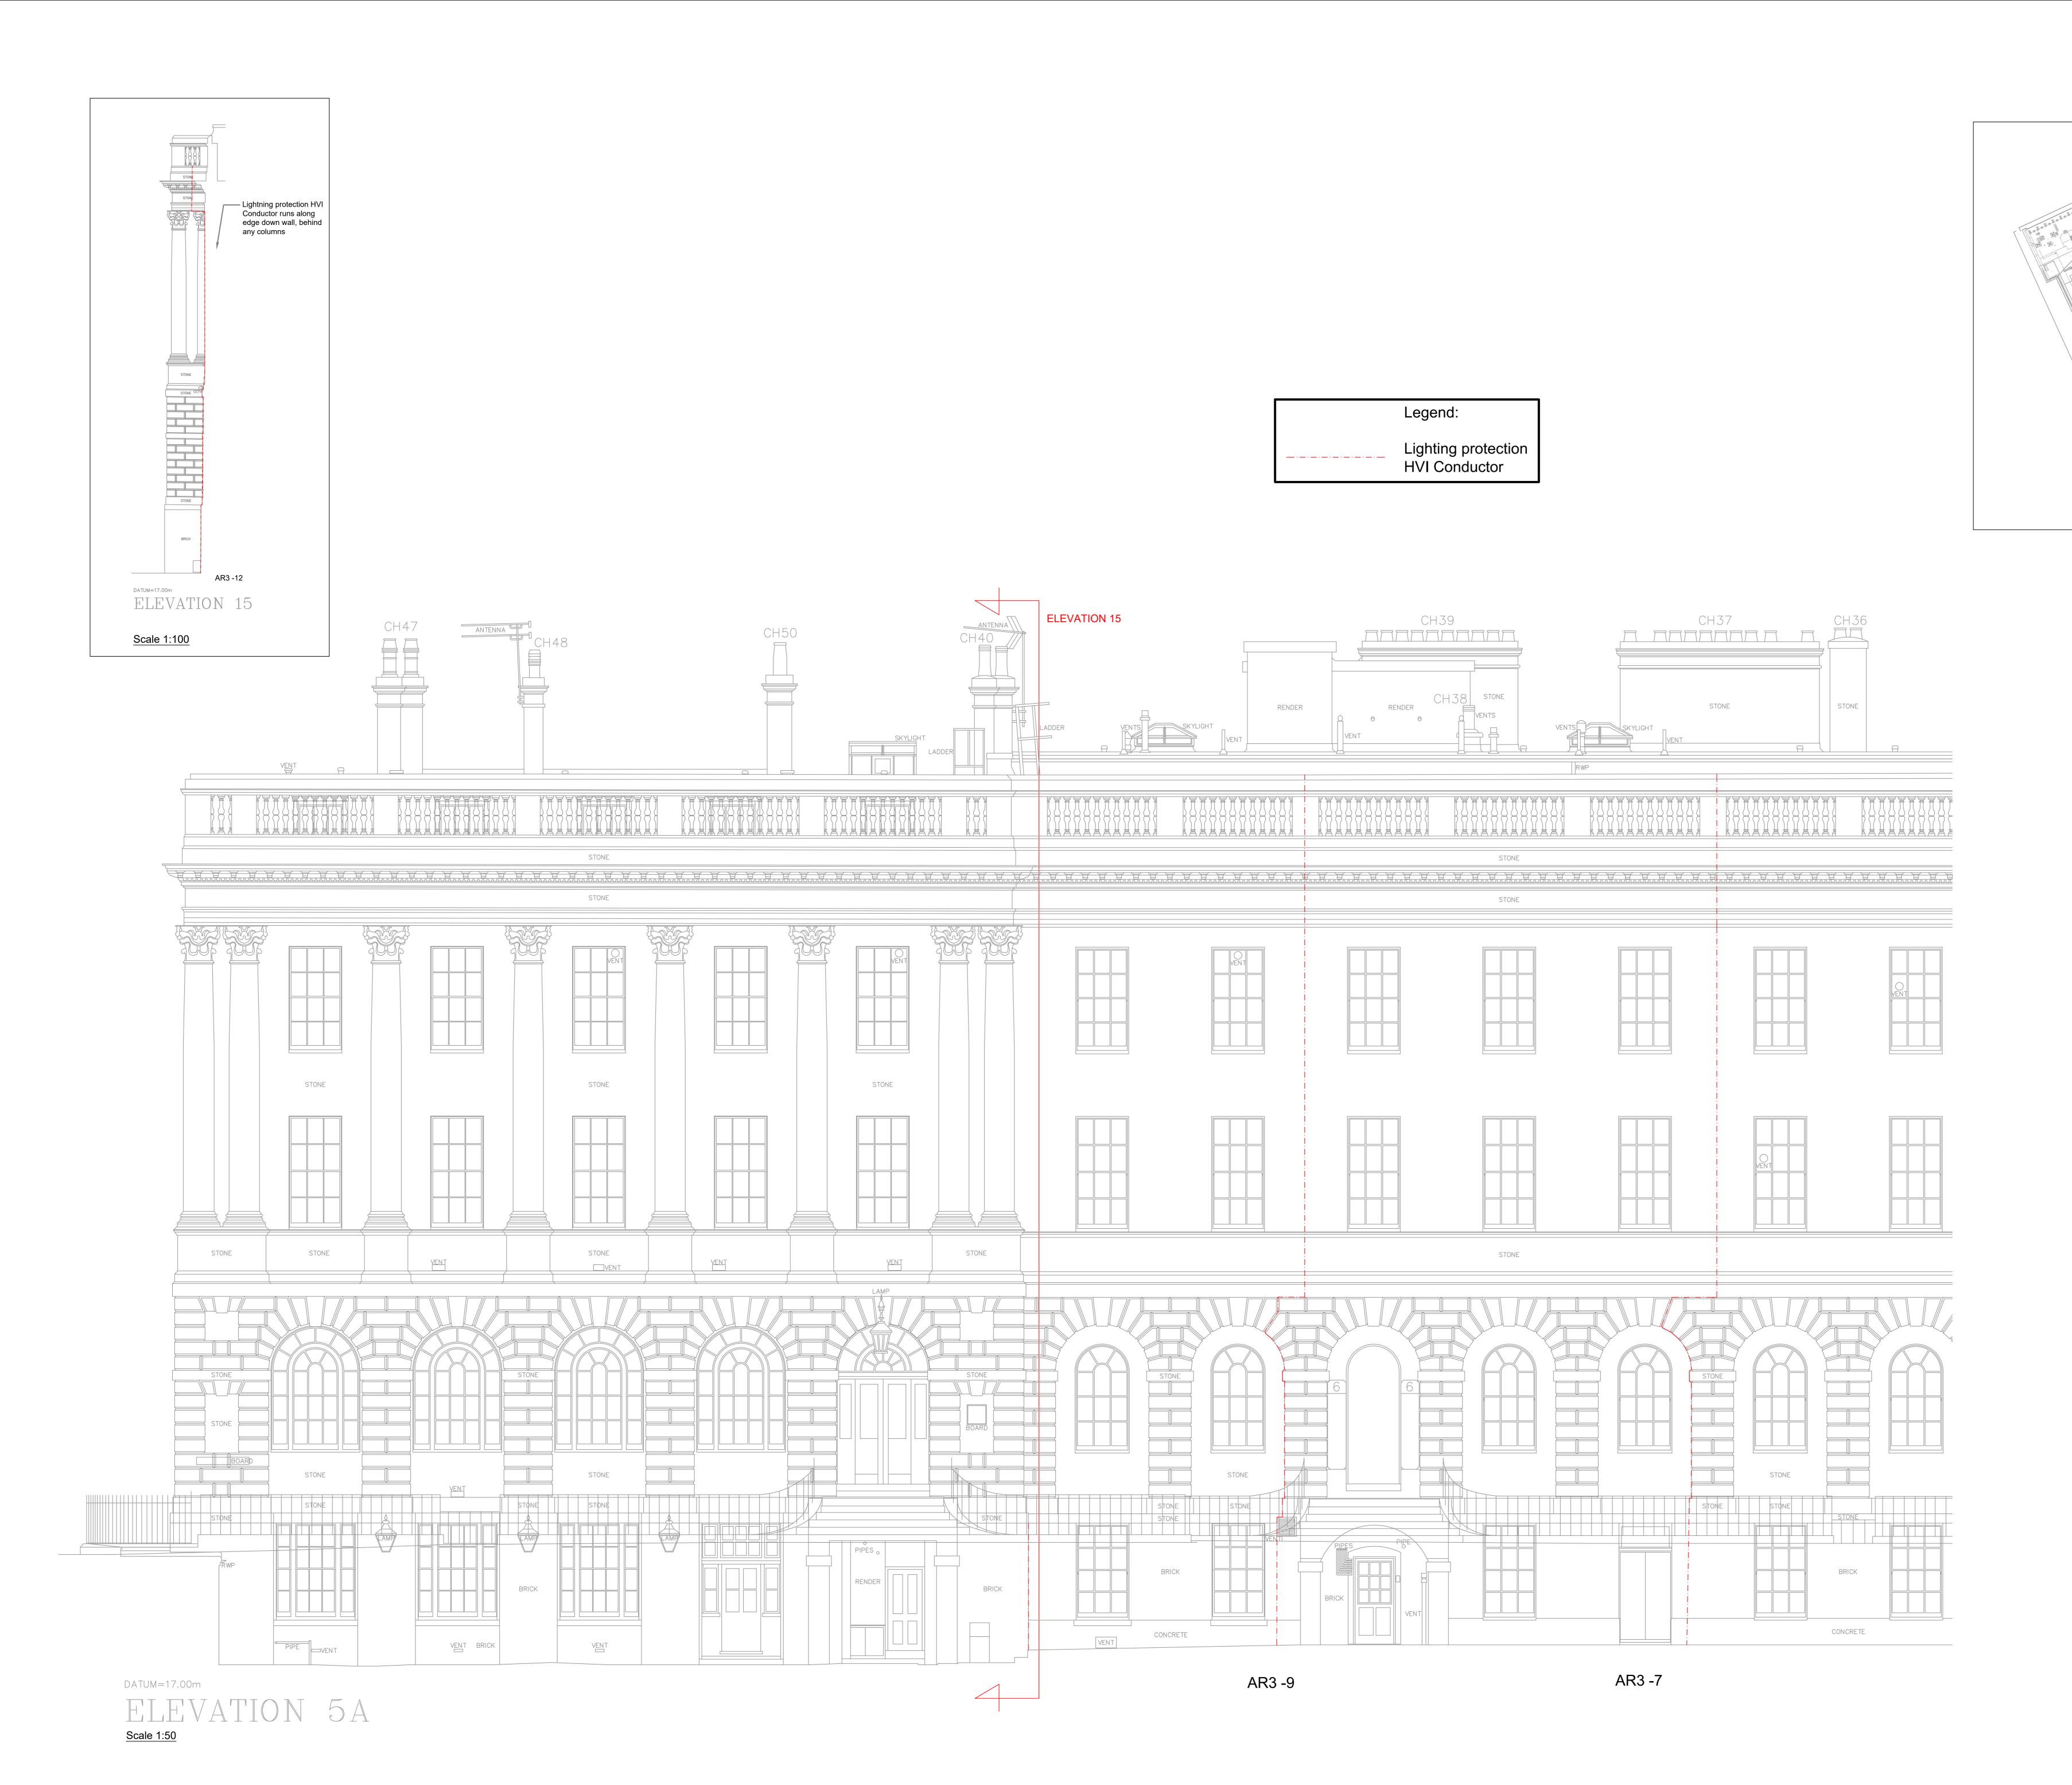

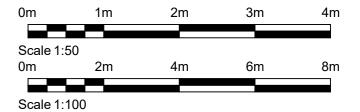

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  Contractor to determine cable containment routes and sizes to suit the installation.

Note:-


HVI conductor shall be painted to match the existing stonework/paint
 Where HVI conductors are installed behind/adjacent RWP's these shall be coloured black

Title:
Lightning Protection
Elevation E5A

Drawing Number:

HSLISB-IWD-XX-XX-DR-E-5818

Status: Purpose of Issue: Revision: P02

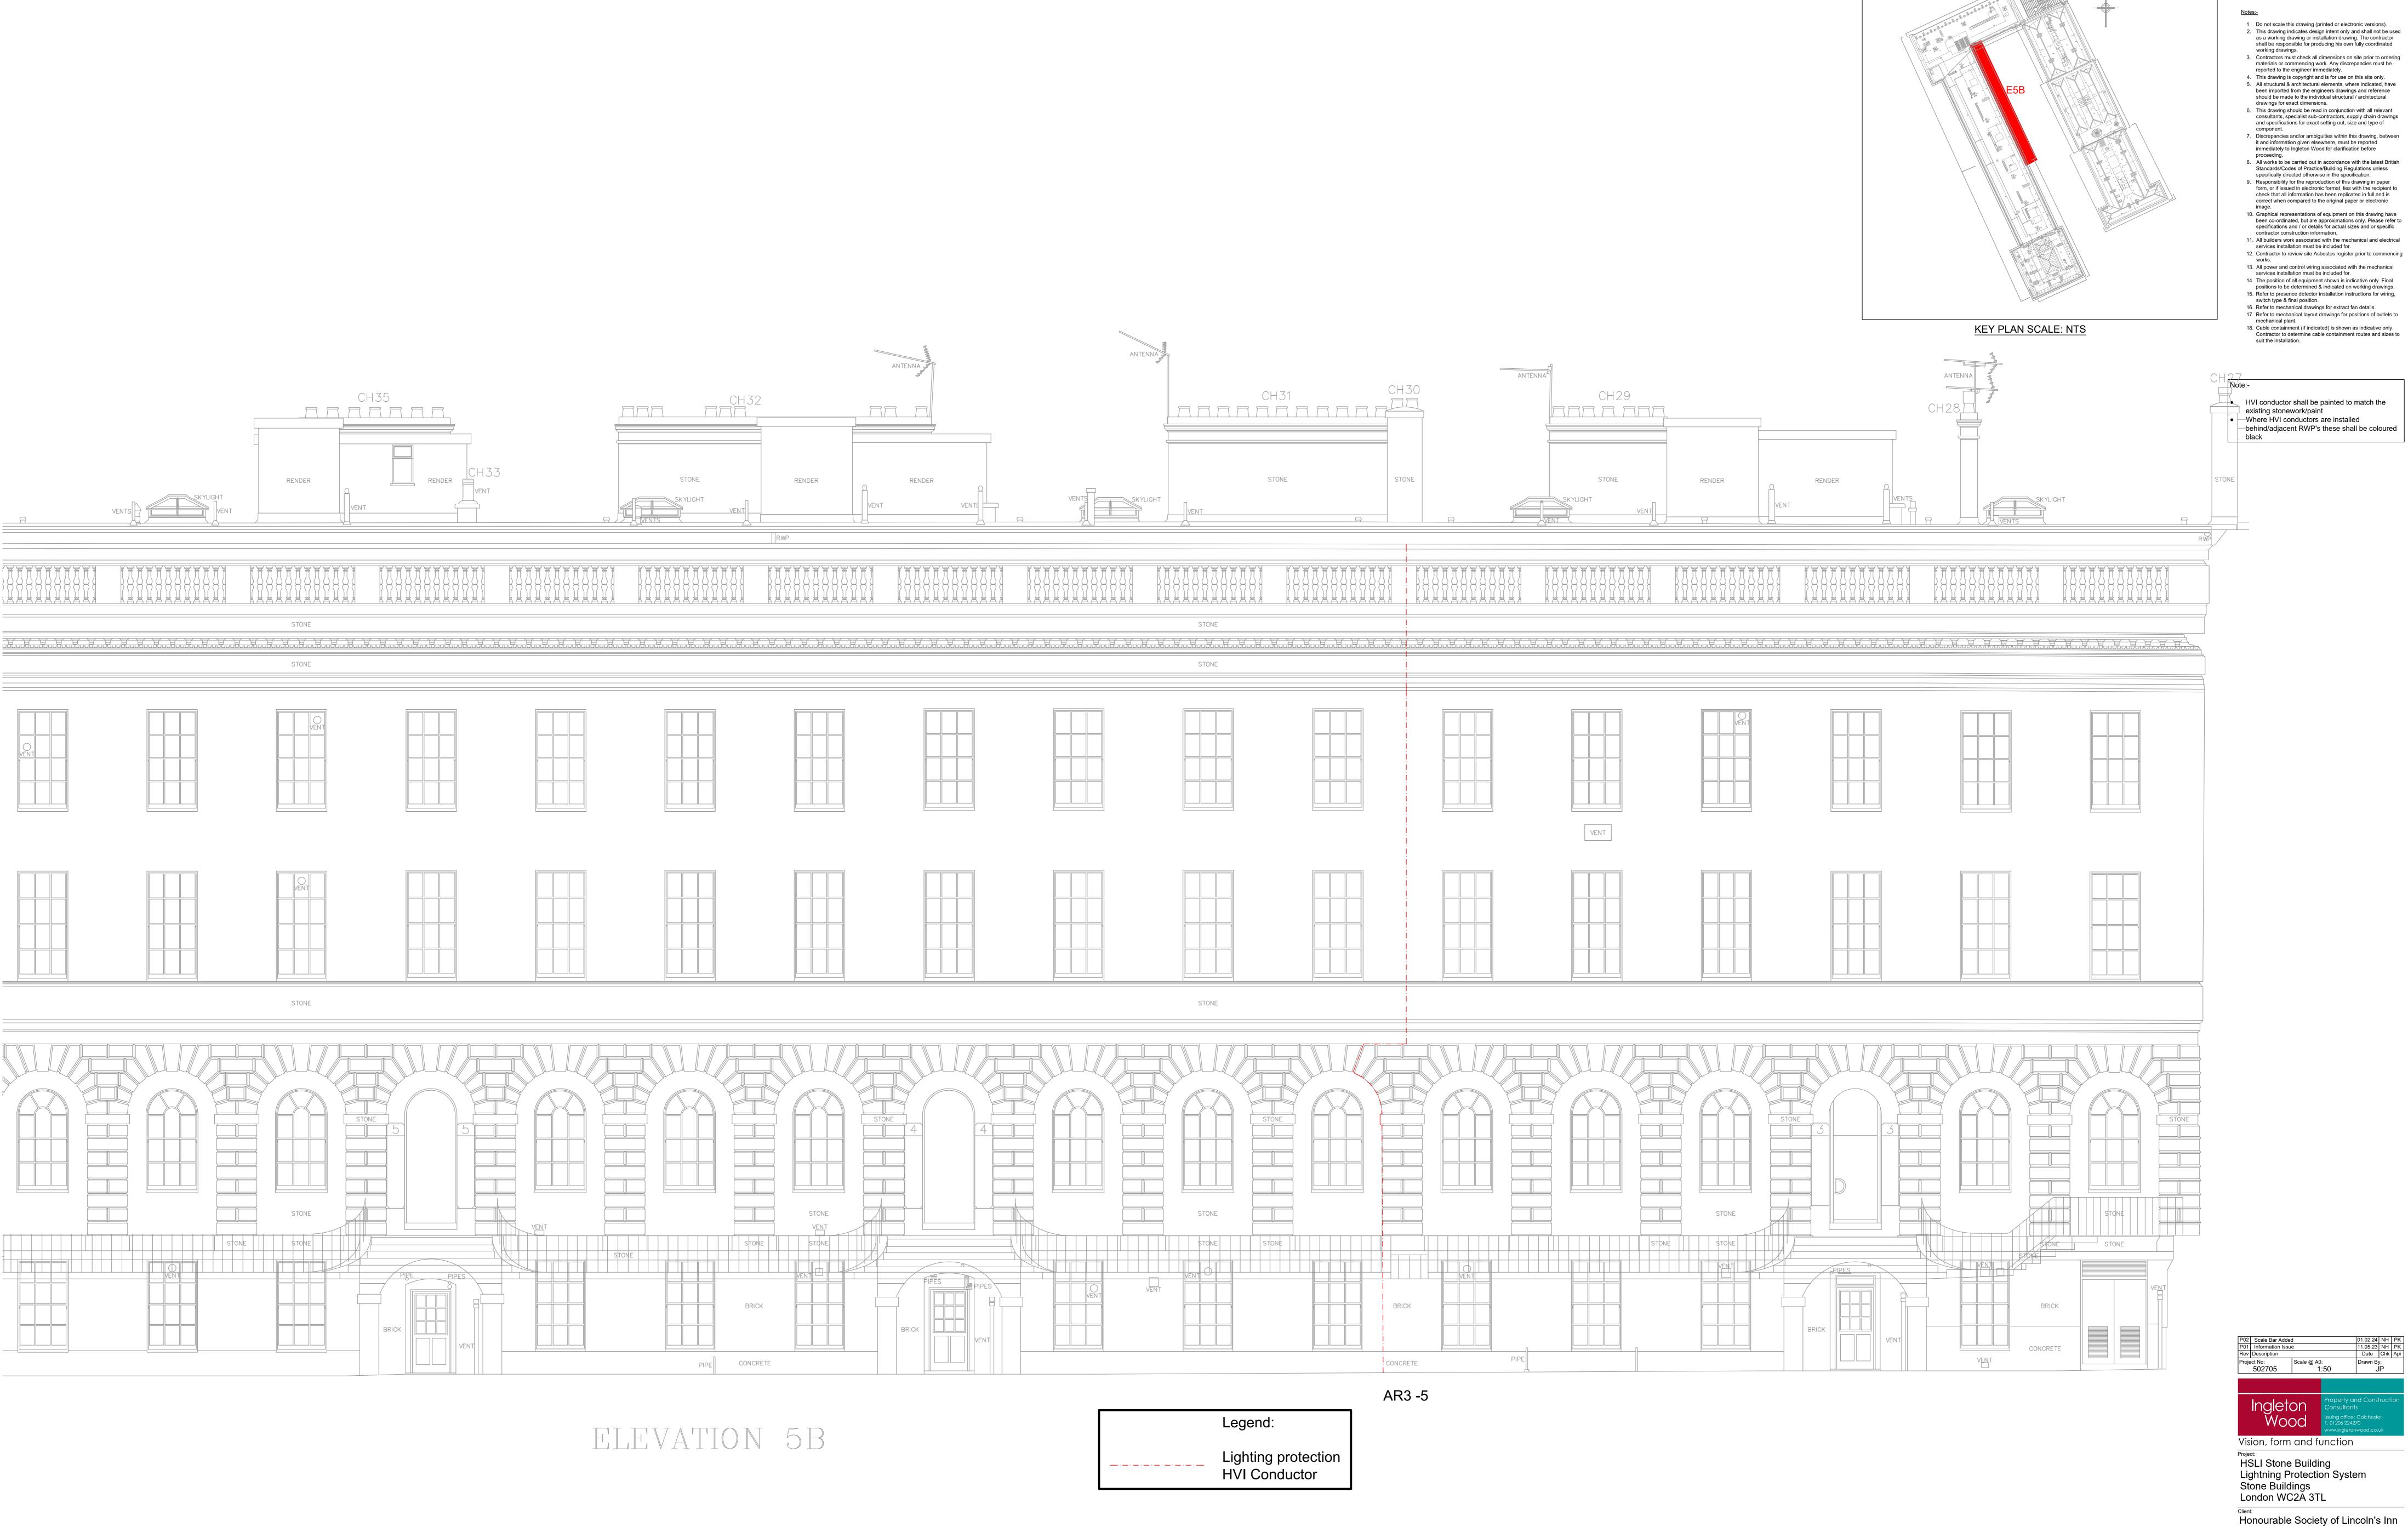

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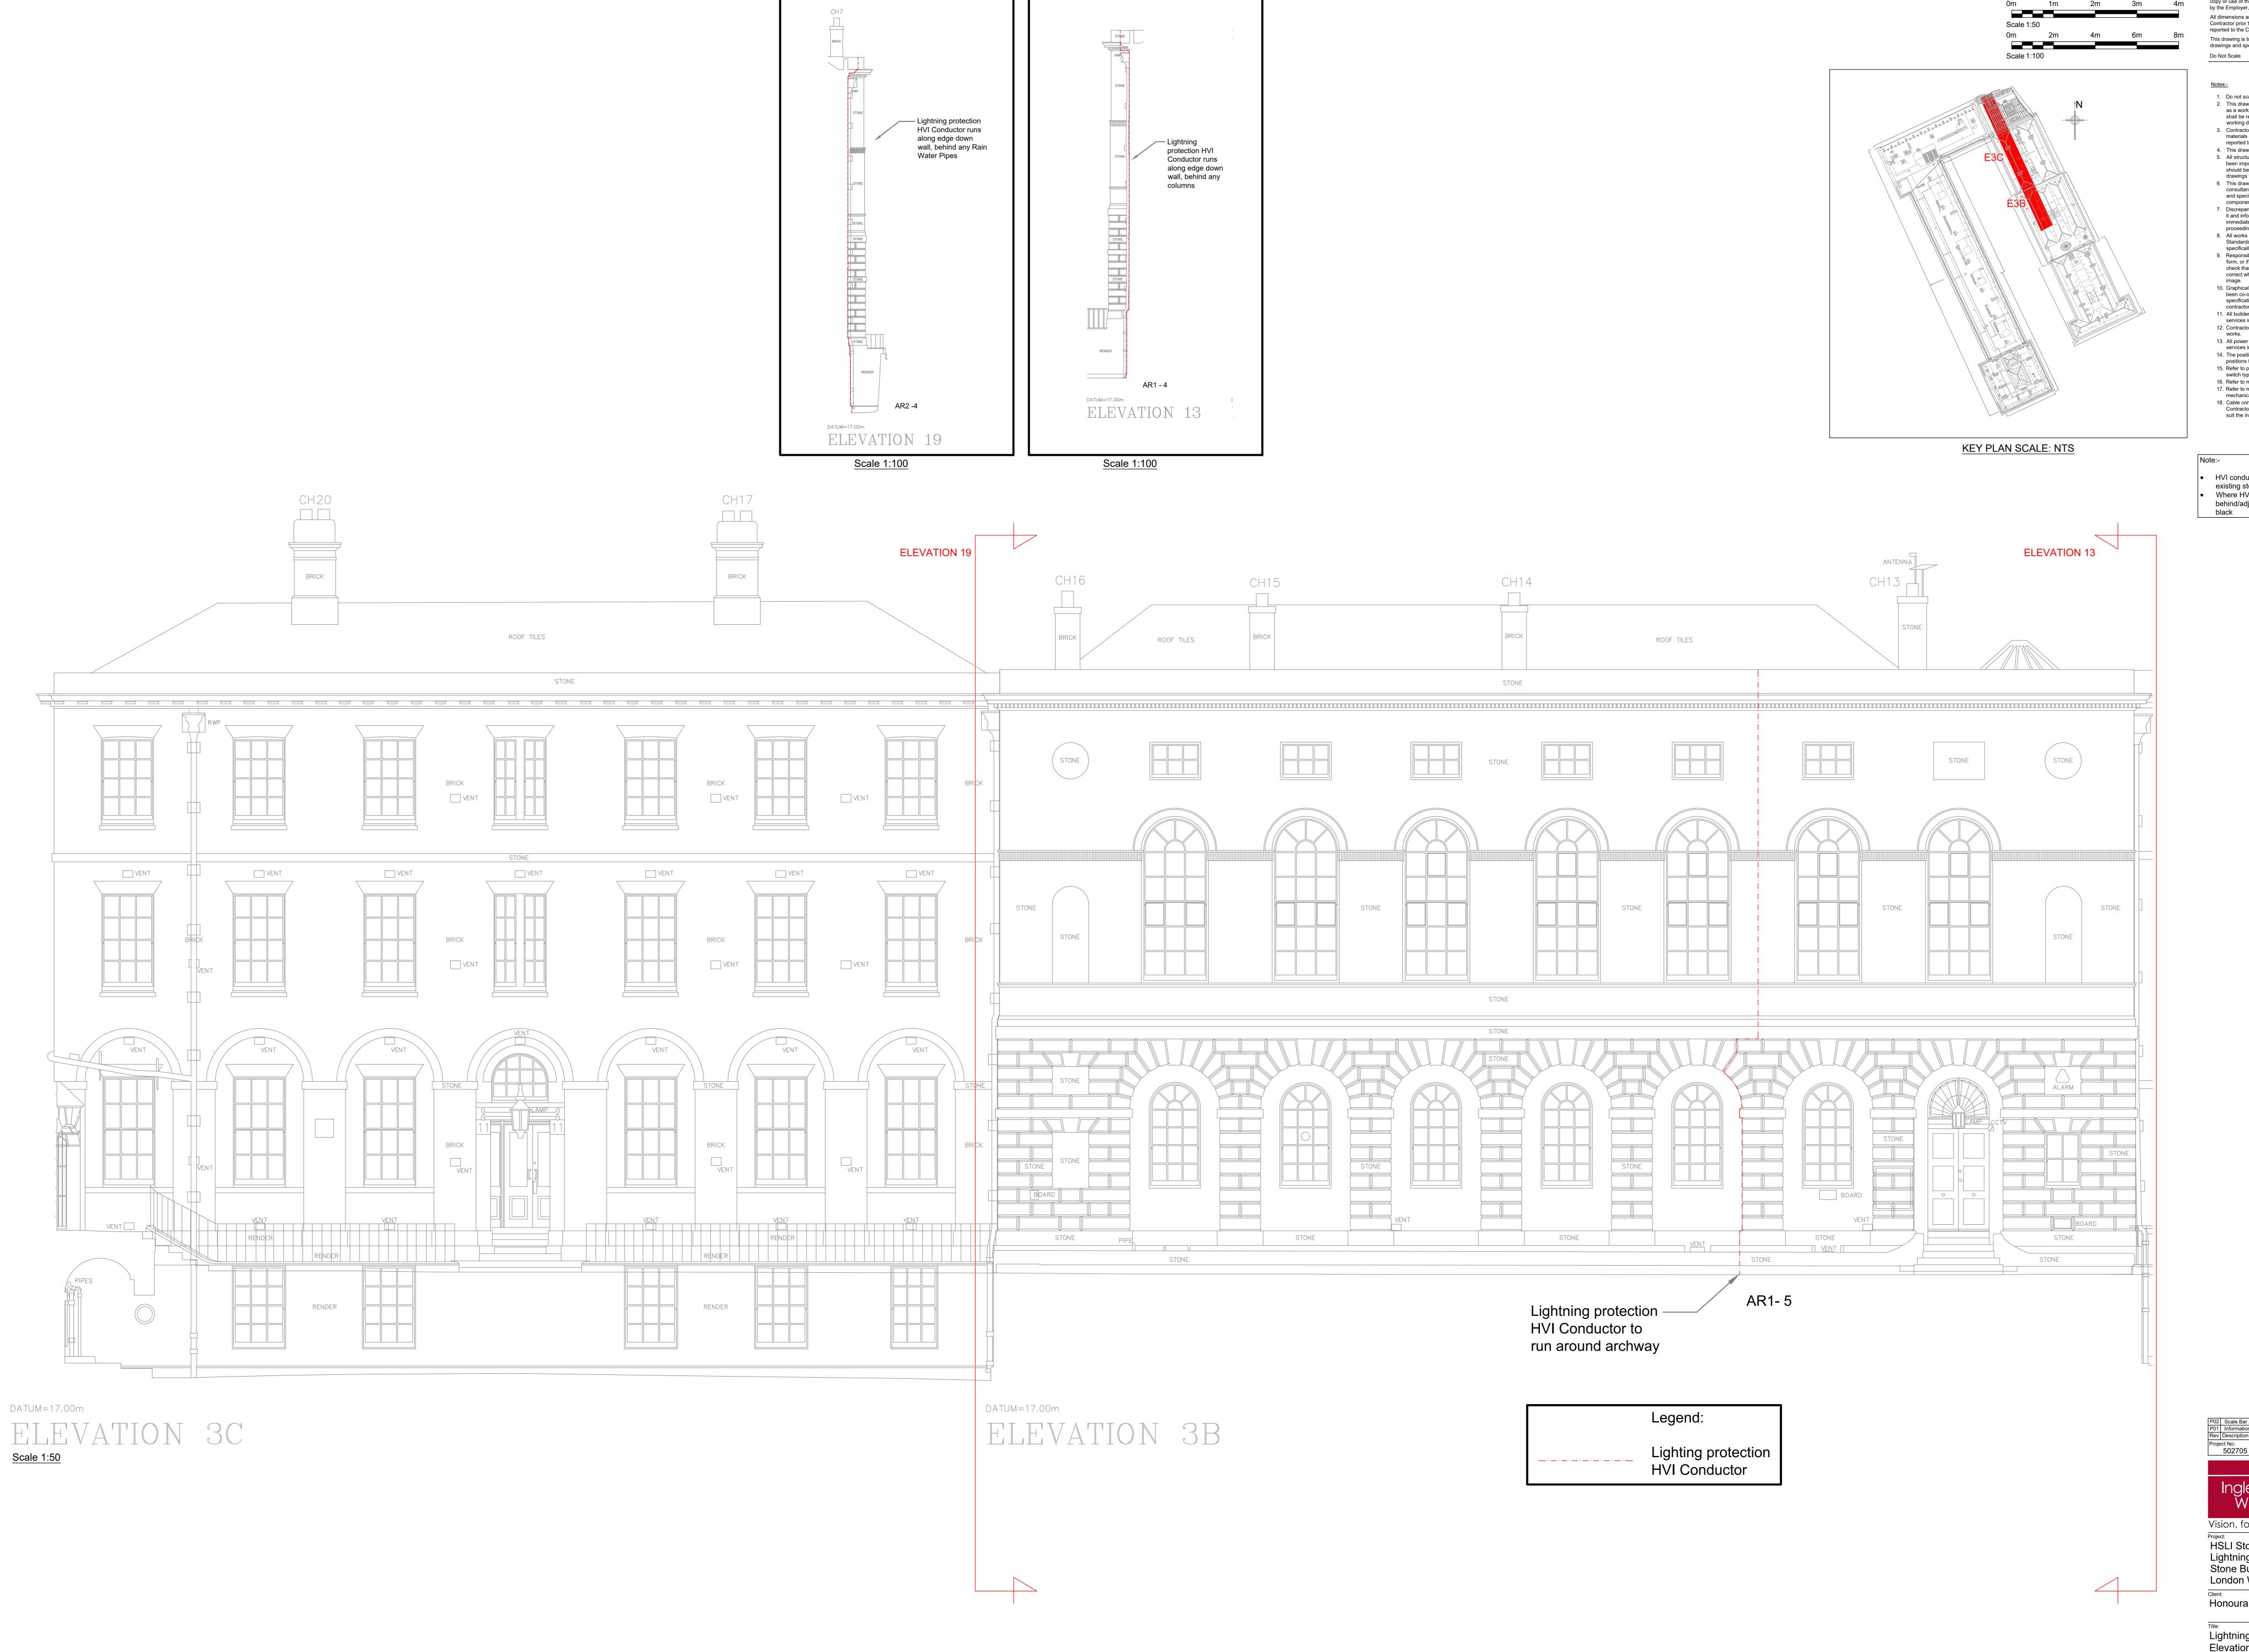
Contractor to determine cable containment routes and sizes to

HVI conductor shall be painted to match the

Vision, form and function

Honourable Society of Lincoln's Inn

Lightning Protection
Elevation E5B Drawing Number:
HSLISB-IWD-XX-XX-DR-E-5819 Status: | Purpose of Issue: S2 | Information



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HVI conductor shall be painted to match the existing stonework/paint Where HVI conductors are installed behind/adjacent RWP's these shall be coloured

 
 P02
 Scale Bar Added
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 PK

 P01
 Information Issue
 11.05.23
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 Rev
 Description
 Date
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 Apr

 Project No:
 Scale @ A0:
 Drawn By:

 502705
 1:50/1:100
 JP
 Ingleton Wood Vision, form and function HSLI Stone Building
Lightning Protection System
Stone Buildings
London WC2A 3TL


Honourable Society of Lincoln's Inn

Lightning Protection
Elevation E3C & E3B Drawing Number:

HSLISB-IWD-XX-XX-DR-E-5820

Status: | Purpose of Issue: | Revision: | P02



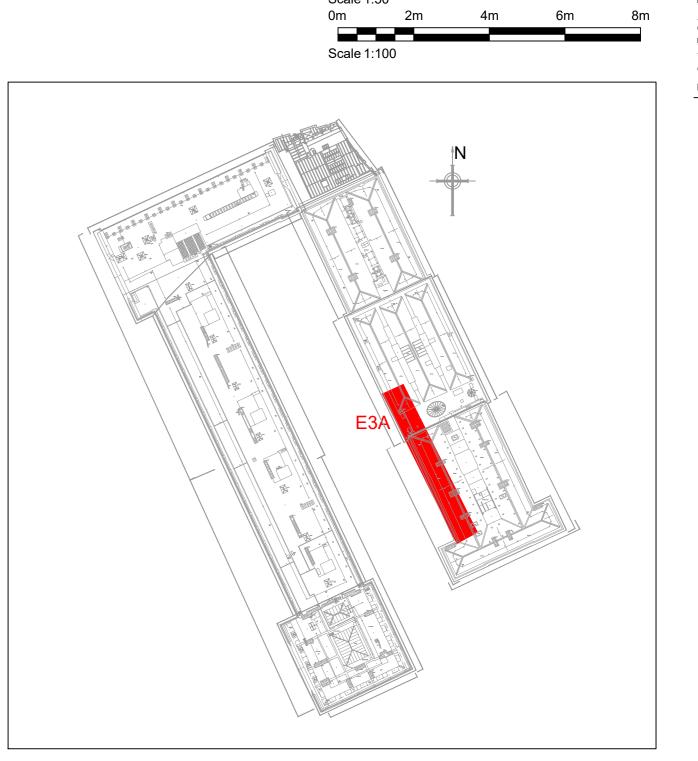

KEY PLAN SCALE: NTS

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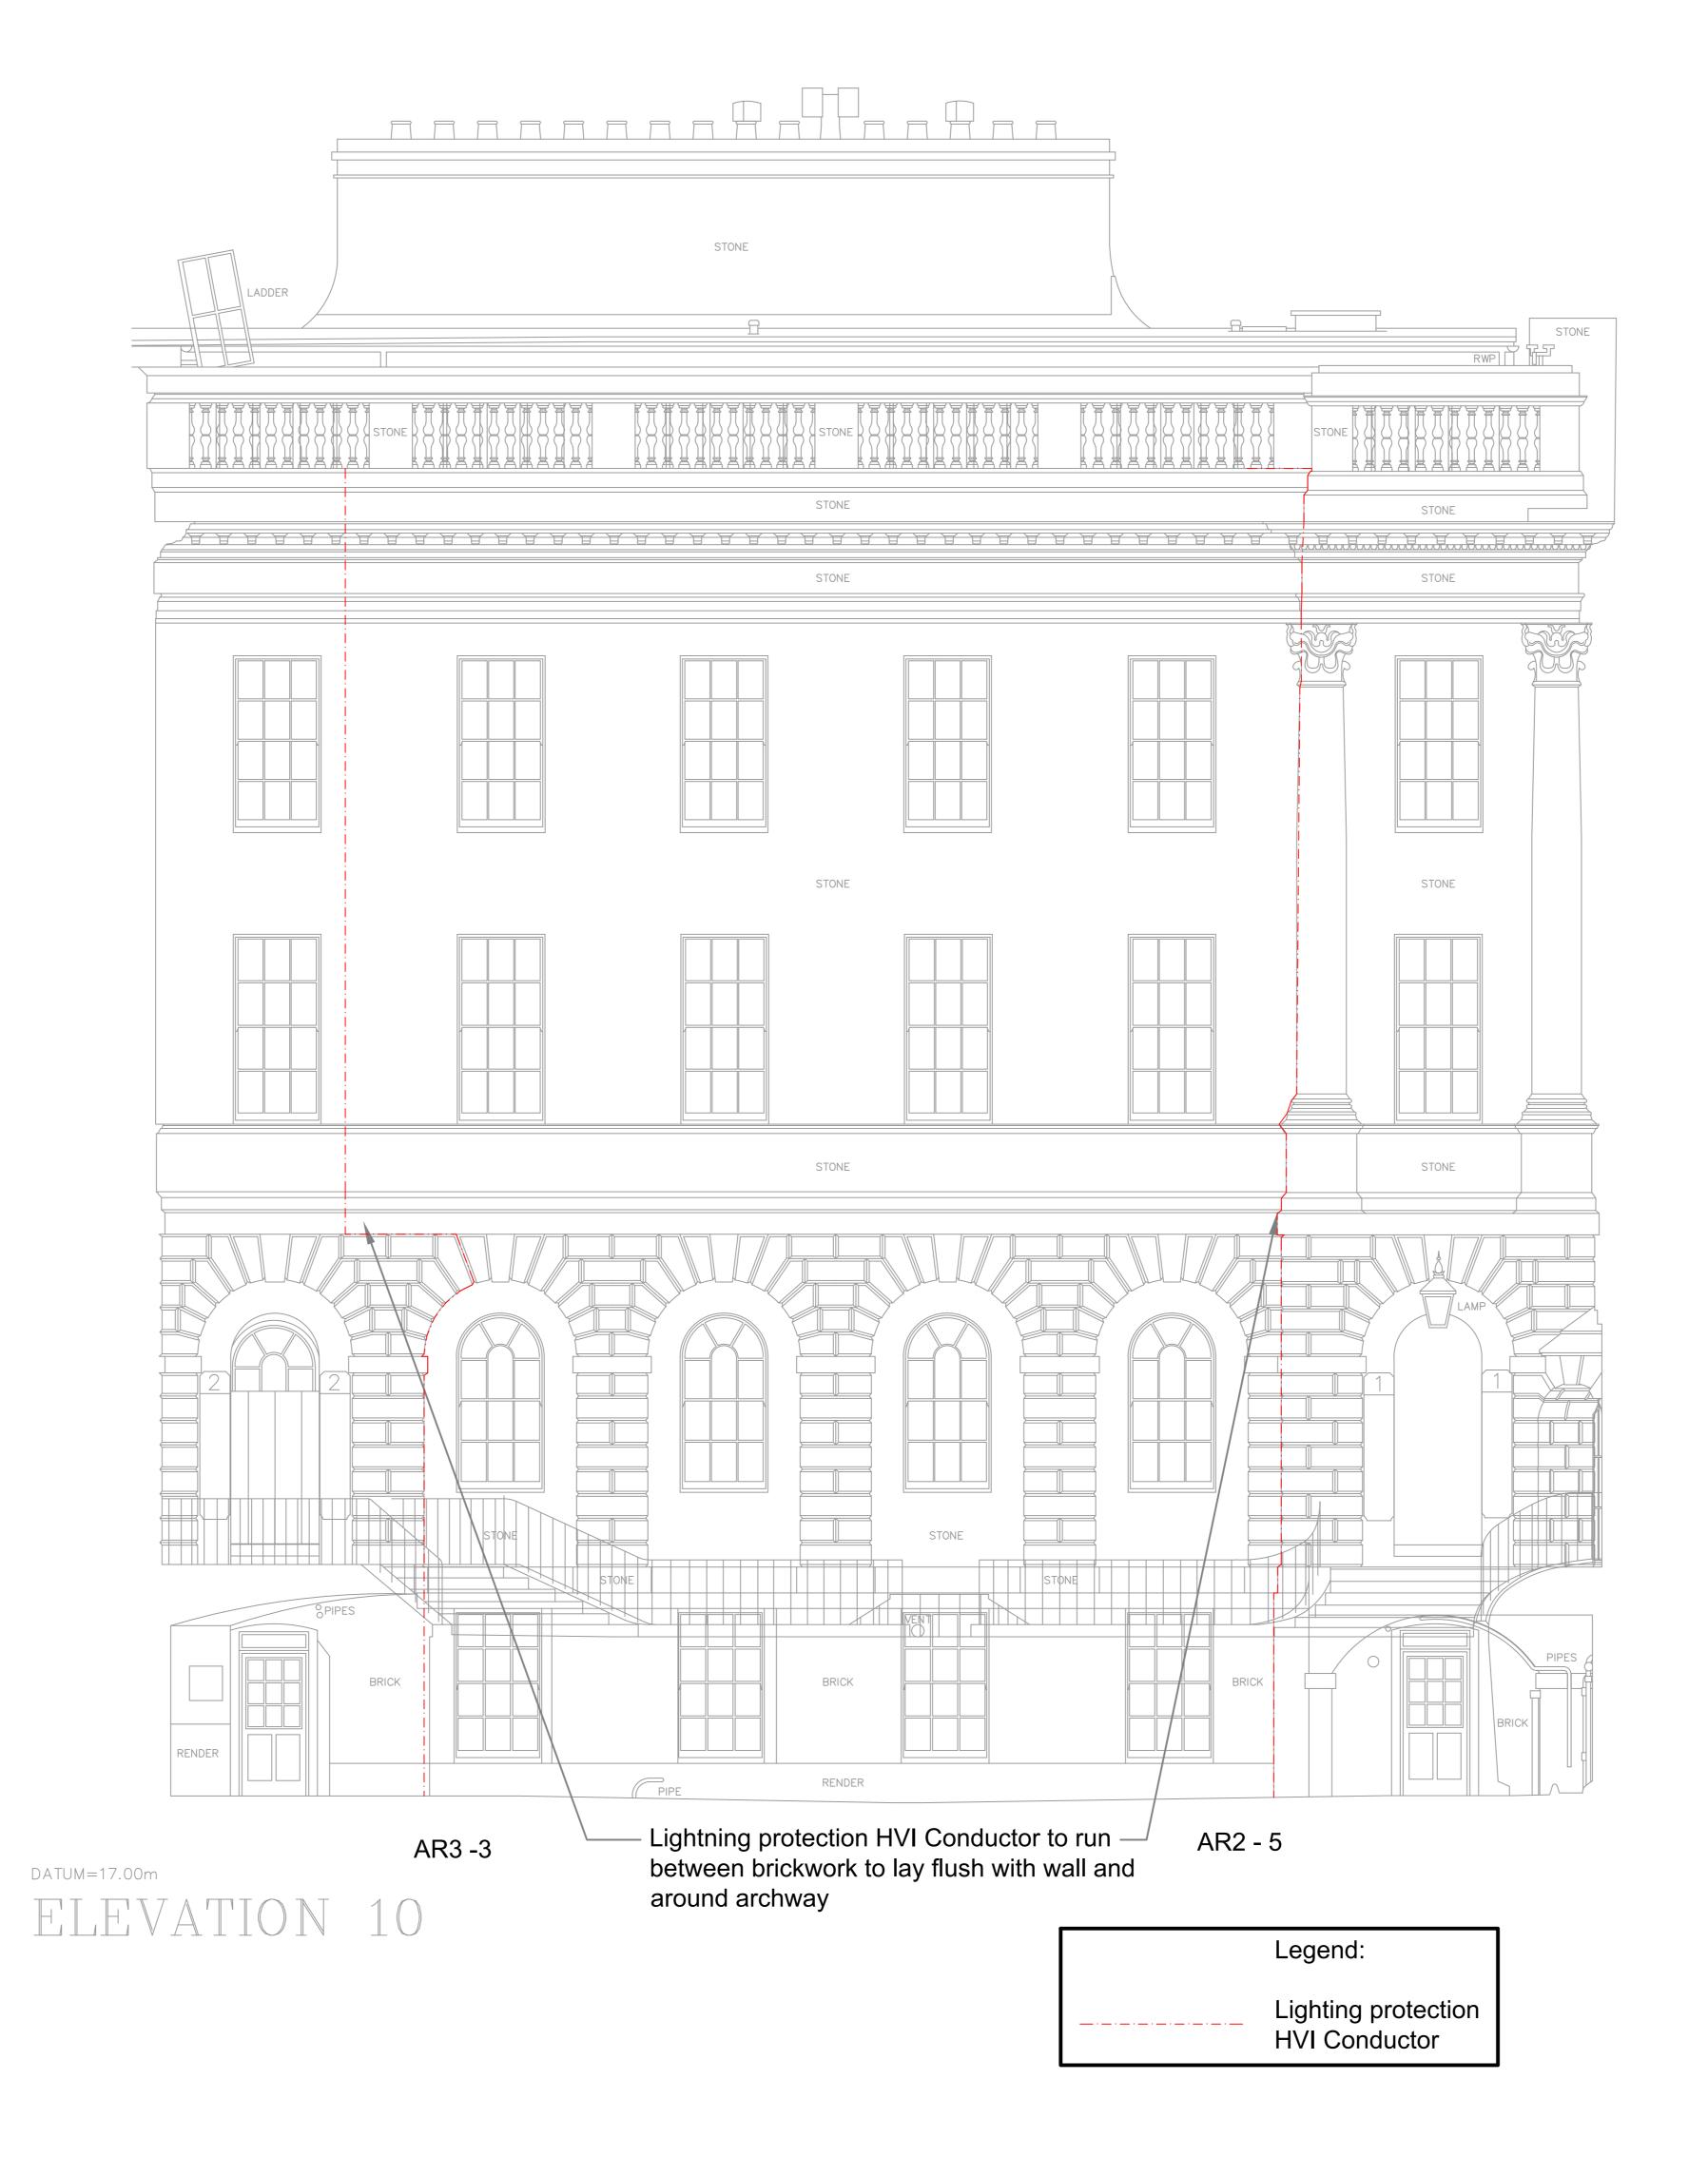
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- mechanical plant. 18. Cable containment (if indicated) is shown as indicative only. Contractor to determine cable containment routes and sizes to
- suit the installation.


HVI conductor shall be painted to match the existing stonework/paint Where HVI conductors are installed behind/adjacent RWP's these shall be coloured



Honourable Society of Lincoln's Inn

Lightning Protection Elevation E3A Drawing Number:
HSLISB-IWD-XX-XX-DR-E-5821 Status: | Purpose of Issue: S2 | Information



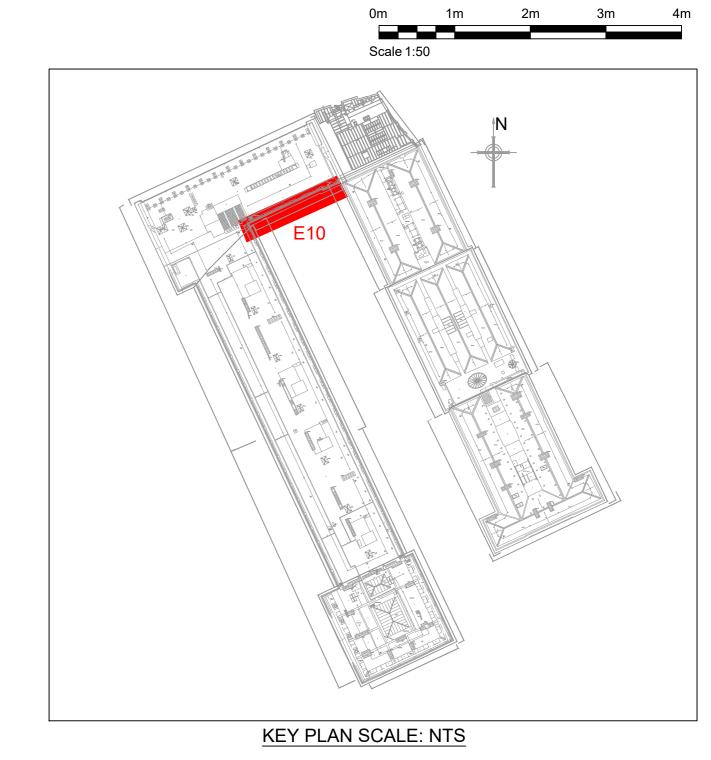

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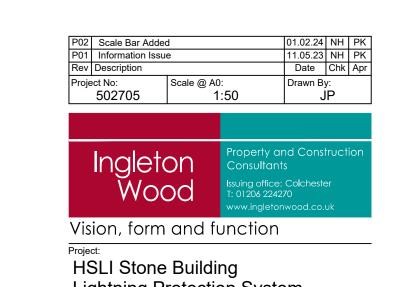
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- 11. All builders work associated with the mechanical and electrical services installation must be included for. 12. Contractor to review site Asbestos register prior to commencing 13. All power and control wiring associated with the mechanical services installation must be included for.

  14. The position of all equipment shown is indicative only. Final
- switch type & final position. 16. Refer to mechanical drawings for extract fan details. 17. Refer to mechanical layout drawings for positions of outlets to mechanical plant.

positions to be determined & indicated on working drawings. 15. Refer to presence detector installation instructions for wiring,

18. Cable containment (if indicated) is shown as indicative only. Contractor to determine cable containment routes and sizes to suit the installation.

HVI conductor shall be painted to match the existing stonework/paint Where HVI conductors are installed behind/adjacent RWP's these shall be coloured




HSLI Stone Building
Lightning Protection System
Stone Buildings
London WC2A 3TL Honourable Society of Lincoln's Inn

Lightning Protection
Elevation E10

Drawing Number:

HSLISB-IWD-XX-XX-DR-E-5822

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been co-ordinated, but are approximations only. Please refer to specifications and / or details for actual sizes and or specific 11. All builders work associated with the mechanical and electrical

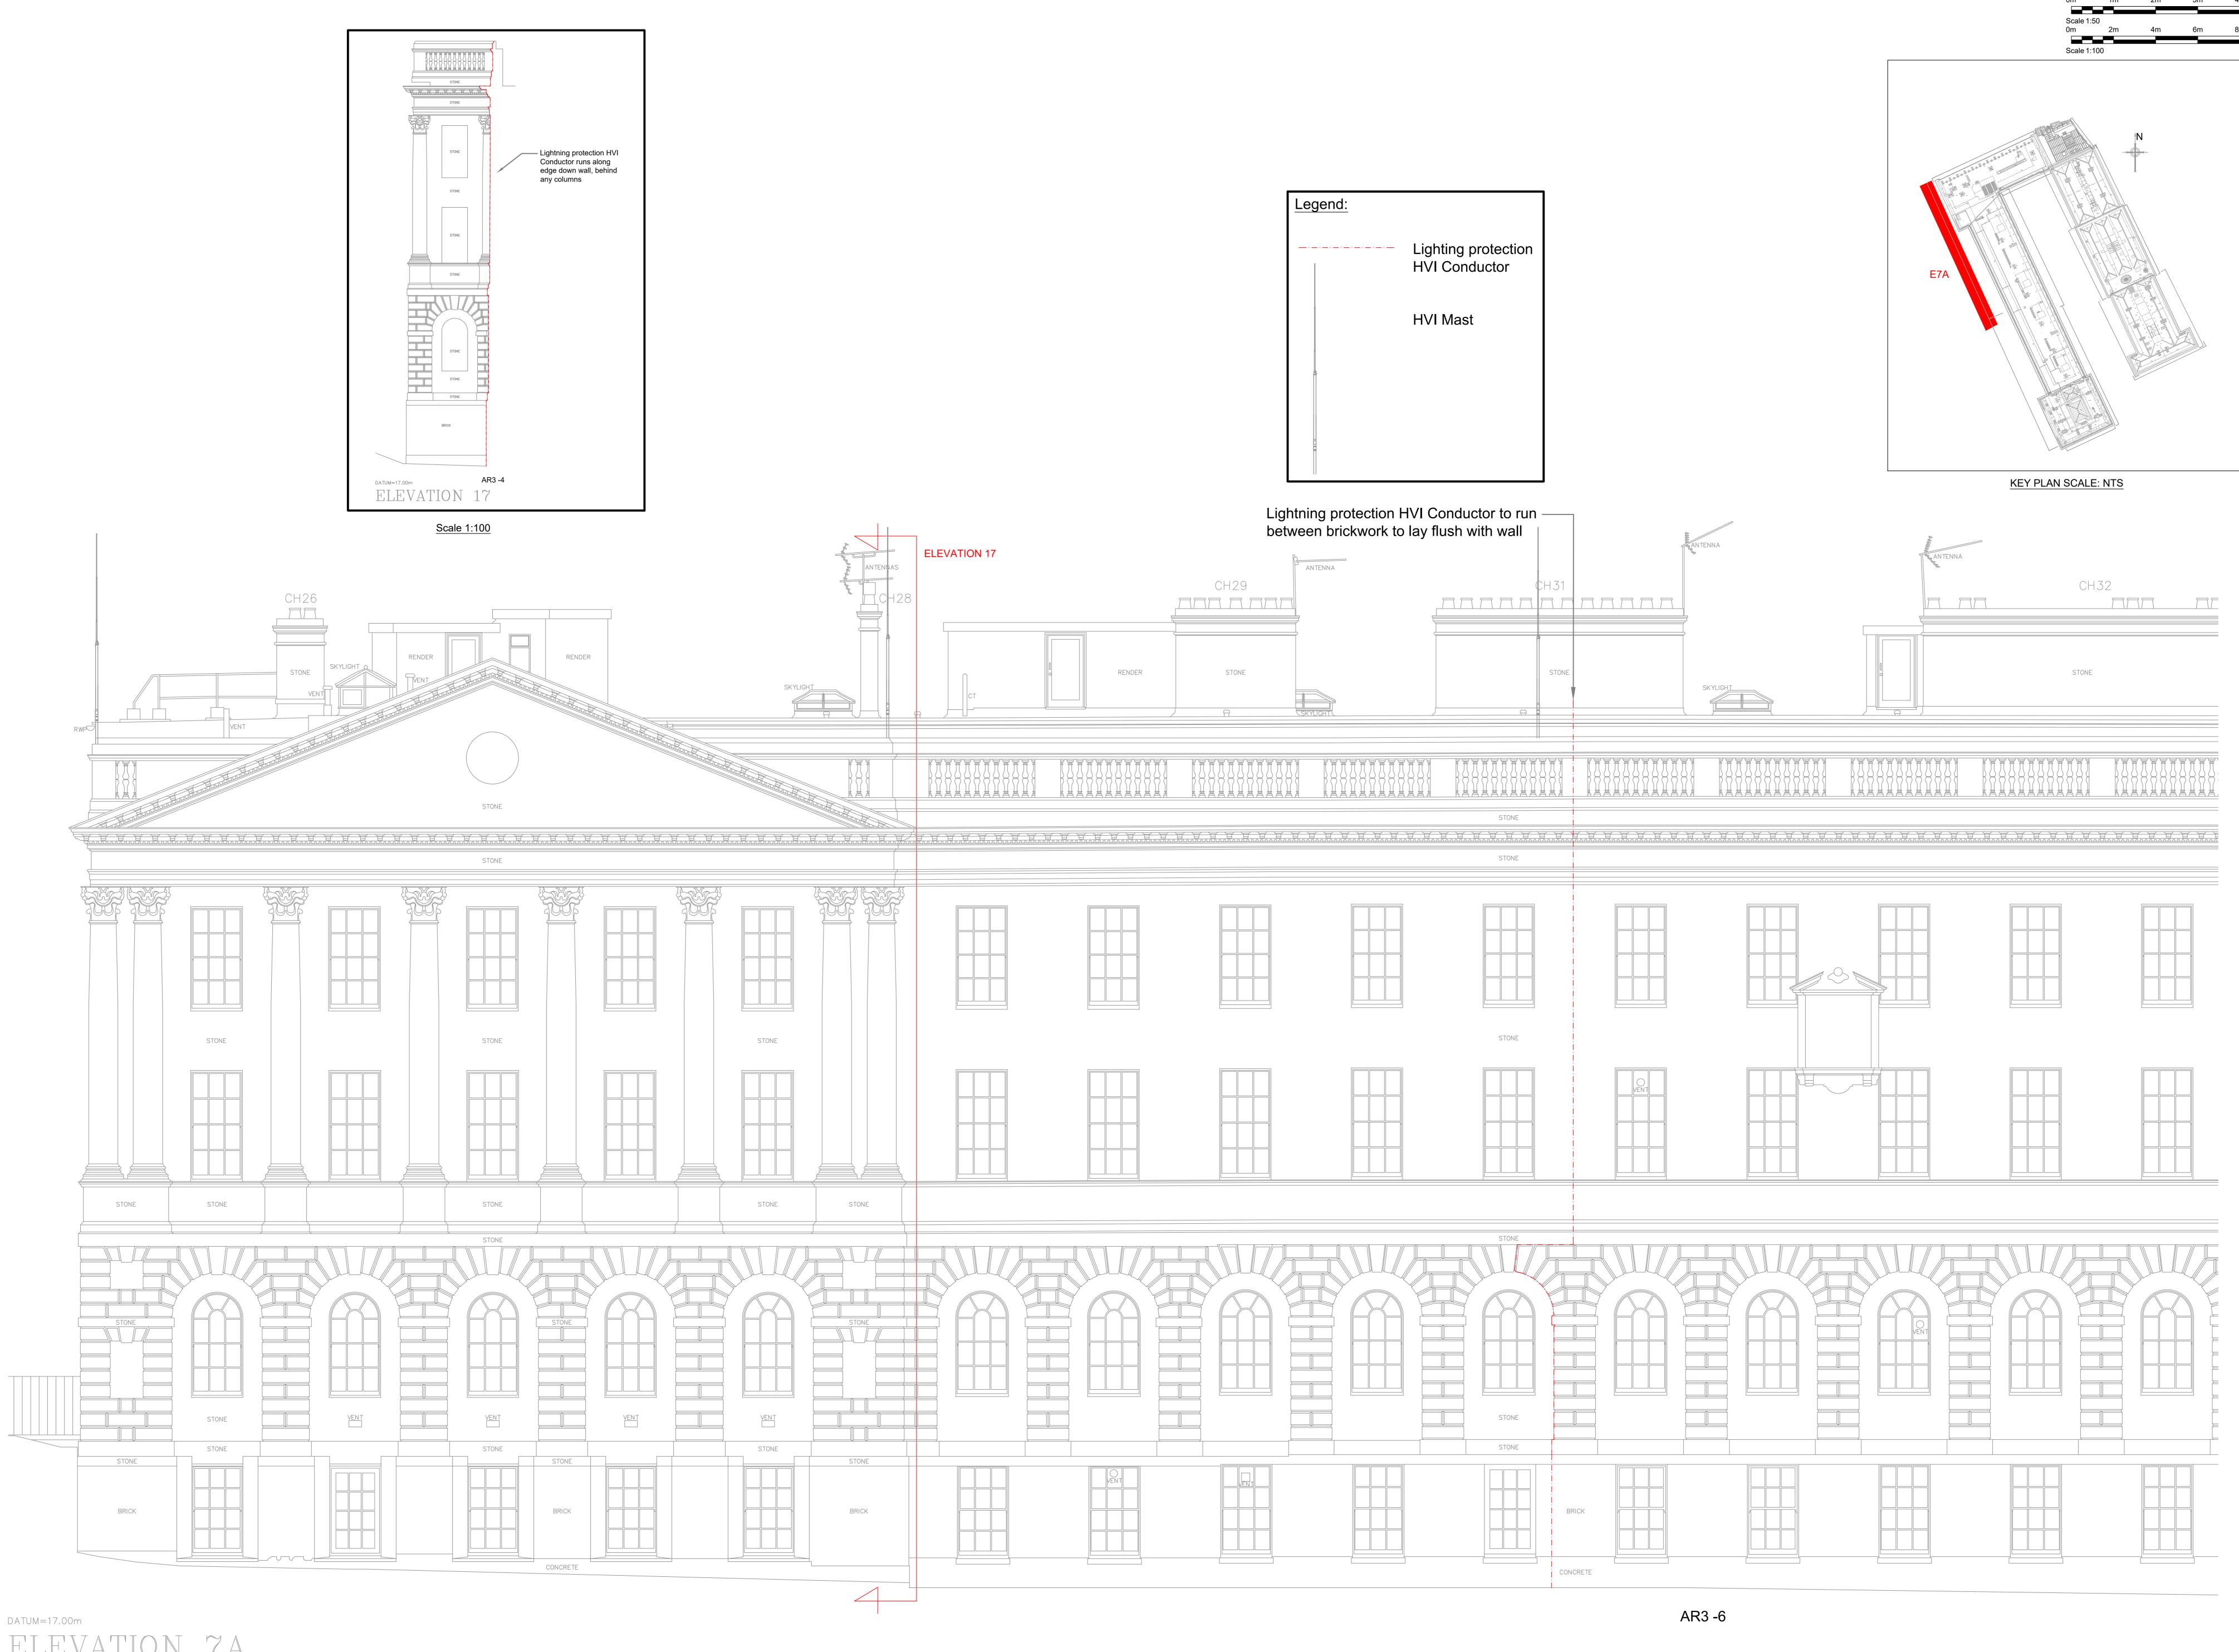services installation must be included for. 12. Contractor to review site Asbestos register prior to commencing

13. All power and control wiring associated with the mechanical services installation must be included for. 14. The position of all equipment shown is indicative only. Final positions to be determined & indicated on working drawings.

15. Refer to presence detector installation instructions for wiring, switch type & final position. 16. Refer to mechanical drawings for extract fan details. 17. Refer to mechanical layout drawings for positions of outlets to

mechanical plant. 18. Cable containment (if indicated) is shown as indicative only. Contractor to determine cable containment routes and sizes to suit the installation.

HVI conductor shall be painted to match the existing stonework/paint Where HVI conductors are installed behind/adjacent RWP's these shall be coloured

> HVI Masts are shown for illustrative purposes only and do not reflect actual appearance from

> ground level

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Lightning Protection HVI Mast typical Elevation E7A Drawing Number:
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